

APPENDIX B - REMEDIAL LOCATION WORK DESCRIPTIONS

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1920 Elizabeth	1427 Grand	817 Iowa	1408 Iowa
811 Grand	1447 Grand	819 Iowa	1419 Iowa
825 Grand	1728/30 Grand	820 Iowa	
906 Grand	1734 Grand	822 Iowa	
907/15 Grand	1918/20 Grand	825 Iowa	
914 Grand	1924 Grand	911 Iowa	
916 Grand	1928 Grand	915/17 Iowa	
921 Grand	1932/34 Grand	916 Iowa	
923 Grand	1933/35 Grand	922 Iowa	
1000 Grand	2117/19 Grand	925 Iowa	
1012 Grand	2129 Grand	1004/06 Iowa	
1013/19 Grand	2139 Grand	1008 Iowa	
1020 Grand	2149 Grand	1013 Iowa	
1021 Grand	2206 Grand	1015 Iowa	
1100 Grand	2208/10 Grand	1030 Iowa	
1101 Grand	2216/18 Grand	1109 Iowa	
1102 Grand	2224/26 Grand	1115 Iowa	
1105 Grand	2228 Grand	1117 Iowa	
1107 Grand	2240/42 Grand	1124 Iowa	
1108 Grand	2246 Grand	1201 Iowa	
1115 Grand	928 Greenwood	1205 Iowa	
1125 Grand	1009 Greenwood	1211 Iowa	
1222 Grand	1012 Greenwood	1213 Iowa	
1224 Grand	1014 Greenwood	1227 Iowa	
1233 Grand	1016 Greenwood	1230 Iowa	
1240/42 Grand	1019 Greenwood	1231 Iowa	
1300 Grand	1022 Greenwood	1245 Iowa	
1303 Grand	1024 Greenwood	1301 Iowa	
1307 Grand	1028 Greenwood	1304 Iowa	
1309 Grand	1030 Greenwood	1305 Iowa	
1311 Grand	1032 Greenwood	1311 Iowa	
1317 Grand	1100 Greenwood	1313 Iowa	
1323 Grand	1102 Greenwood	1316 Iowa	
1325 Grand	1108 Greenwood	1322 Iowa	
1330/32 Grand	1112 Greenwood	1324 Iowa	
1413 Grand	1120 Greenwood	1400 Iowa	
1417 Grand	1133 Greenwood	1406 Iowa	



Action Date: 10/1/97

Loadout: 10/31/97

Restoration Begins: 10/3/97

Restoration Completed: 10/17/97

*Stack emission sites were not sampled for verification due to the fact that a pre-determined depth for excavation was given to OHM by USACE.

*An excavation depth of 12 inches was established by USACE prior to work commencing.

*The excavation of special waste yielded a total of 48.70 cubic yards, which was shipped to WMI-Milam for disposal.

*Equipment utilized during excavation:

*TL-26

*TCM

*17-KW

*X331

*Subcontractors:

*WMI-landfill

*B. Garcia-trucking

*Granthum-trucking

*Emerald Turf Farm


OHM CORPORATION
PROJECT 19531
GRANITE CITY, IL

QUANTITY SUMMARY FOR 1920 Elizabeth

SPECIAL WASTE (TONS)	BACKFILL (LOADS)	TOPSOIL (TONS)	CA-6 (TONS)	CA-7 (TONS)	SAND (TONS)	SOD CU.YDS.	CONCRETE	OTHER
63.32	4	29.91				180		

**Sampling Analysis
Project #19531**

0 - 3" Front and Back				3 - 6" Front and Back				6 - 12" Front and Back				Depth	
Street/Number Address	A		A		B		B		C		C		Excav. (inch)
	PPM	No.	PPM	No.	PPM	No.	PPM	No.	PPM	No.	PPM	No.	
	No.	No.	No.	No.	No.	No.	No.	No.	No.	No.	No.	No.	
1920 Elizabeth	240	240	240	1070	442	845	507	543	482	609		12	

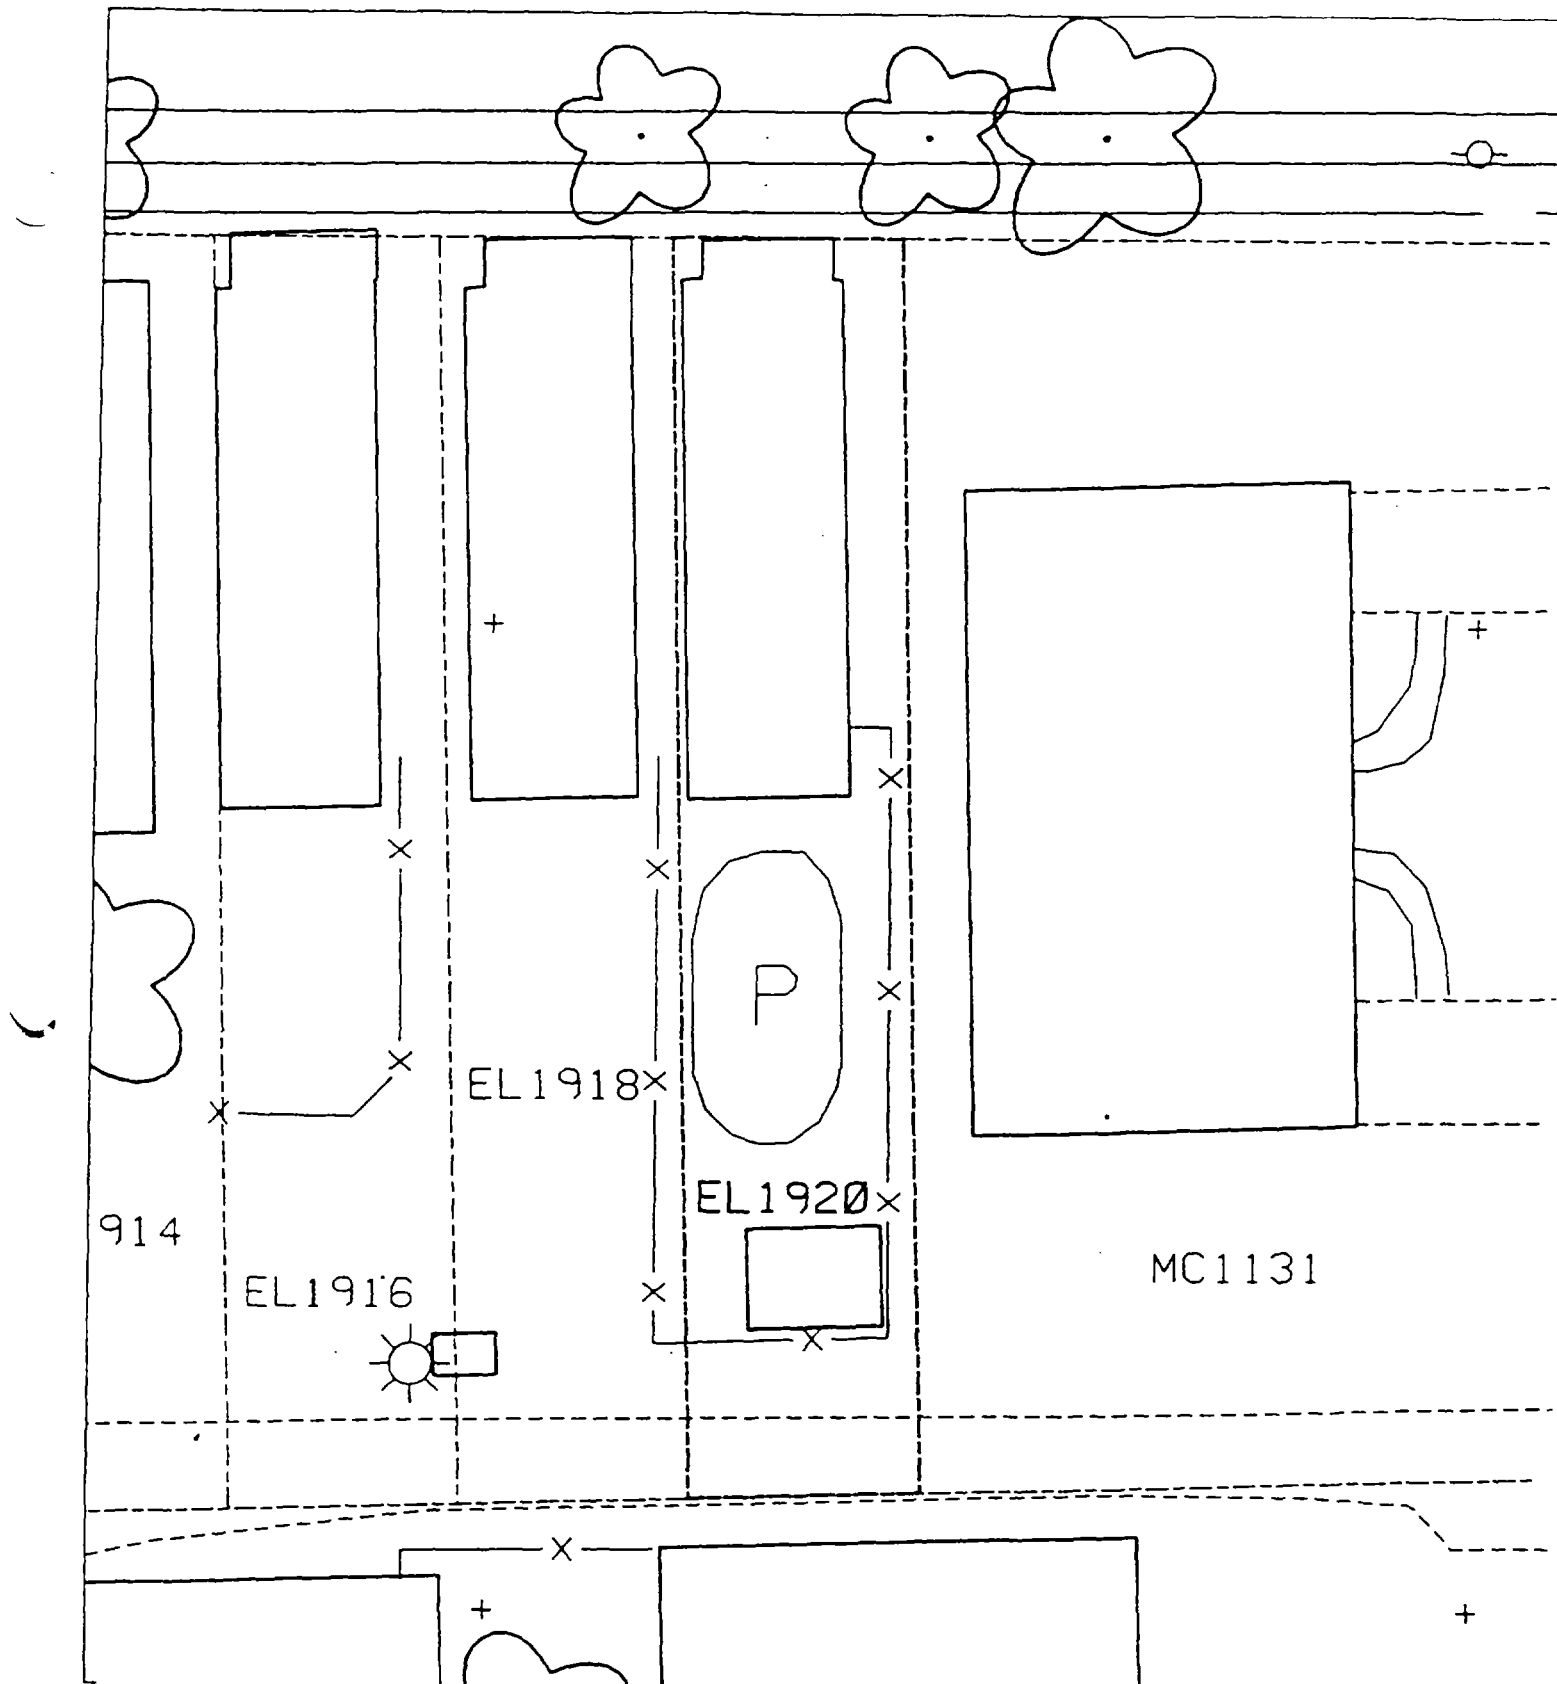

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811 Grand

Action Date: 10/6/97

Loadout: 10/7/97

Restoration Begins: 10/7/97

Restoration Completed: 10/21/97

*Stack emission sites were not sampled for verification due to the fact that a pre-determined depth for excavation was given to OHM by USACE.

*An excavation depth of 12 inches was established by USACE prior to work commencing.

*The excavation of special waste yielded a total of 94.38 cubic yards, which was shipped to WMI-Milam for disposal.

*Equipment utilized during excavation:

*TL-26

*TCM

*X331

*17-KW

*Subcontractors:

*WMI-landfill

*B. Garcia-trucking

*Grantham-trucking

*Emerald-turf farm

**OHM CORPORATION
PROJECT 19531
GRANITE CITY, IL**

QUANTITY SUMMARY FOR

811 Grand

SPECIAL WASTE (TONS)	BACKFILL (LOADS)	TOPSOIL (TONS)	CA-6 (TONS)	CA-7 (TONS)	SAND (TONS)	SOD CU.YDS.	CONCRETE	OTHER
122.7	7	44.75		14.85		360		

**Sampling Analysis
Project #19531**

0 - 3" Front and Back

Street/Number Address	A		A	
	PPM	No.	PPM	No.
811 Grand	391	539		
	334	385		

3 - 6" Front and Back

B		B	
PPM	No.	PPM	No.
347	645		
358	418		

6 - 12" Front and Back

C		C	
PPM	No.	PPM	No.
187	2840		
226	506		

Depth
Excav. (inch)
12

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825 Grand

Action Date: 10/21/97

Loadout: 10/23/97

Restoration Begins: 10/23/97

Restoration Completed: 10/30/97

*Stack emission sites were not sampled for verification due to the fact that a pre-determined depth for excavation was given to OHM by USACE.

*An excavation depth of 12 inches was established by USACE prior to work commencing.

*The excavation of special waste yielded a total of 40.03 cubic yards, which was shipped to WMI-Milam for disposal.

*Equipment utilized during excavation:

*TL-26

*TCM

*17-KW

*X331

*Subcontractors:

*WMI-landfill

*B. Garcia-trucking

*Granthum-trucking

*Emerald Turf Farm

OHM CORPORATION
PROJECT 19531
GRANITE CITY, IL

QUANTITY SUMMARY FOR

825 Grand

SPECIAL WASTE (TONS)	BACKFILL (LOADS)	TOPSOIL (TONS)	CA-6 (TONS)	CA-7 (TONS)	SAND (TONS)	SOD CU.YDS.	CONCRETE	OTHER
52.05	3		13.3			120		

Sampling Analysis
Project #19531

0 - 3" Front and Back

Street/Number Address	A		A	
	PPM	No.	PPM	No.
	PPM	No.	PPM	No.

825 Grand 52 309
180 780
833 478

3 - 6" Front and Back

	B		B	
	PPM	No.	PPM	No.
	PPM	No.	PPM	No.

1680 270
200 83
435 474


6 - 12" Front and Back

	C		C	
	PPM	No.	PPM	No.
	PPM	No.	PPM	No.

516 320
220 110
280 417

Depth
Excav.
(inch)

12

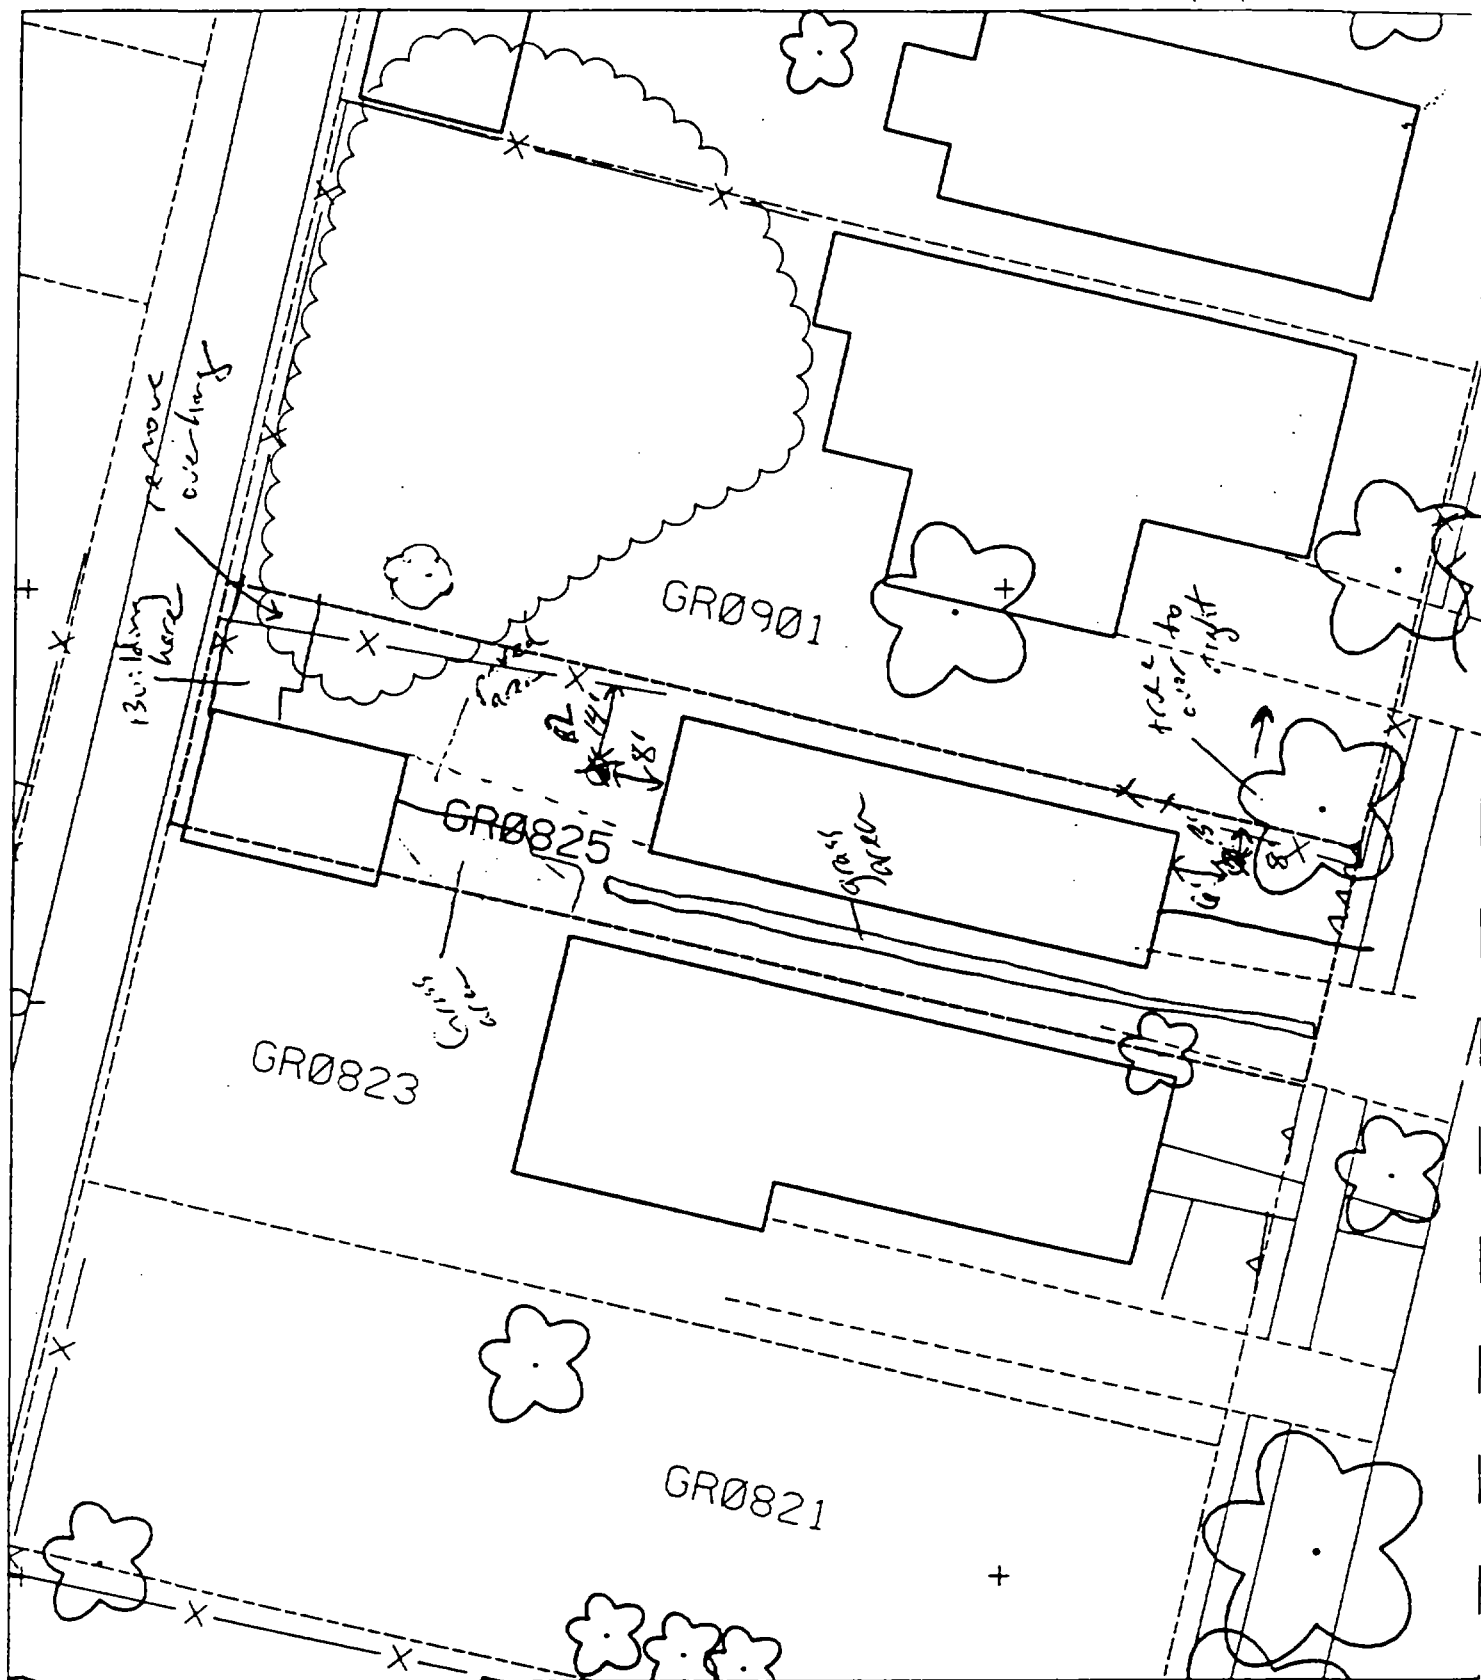

B' - 6' east of house & 8' south of fence.

B' - 8' west of house & 14' south of fence.

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906 Grand

Action Date: 9/8/97

Loadout: 9/10/97

Restoration Begins: 9/10/97

Restoration Completed: 10/18/97

*Stack emission sites were not sampled for verification due to the fact that a pre-determined depth for excavation was given to OHM by USACE.

*An excavation depth of 12 inches was established by USACE prior to work commencing.

*The excavation of special waste yielded a total of 67.95 cubic yards, which was shipped to WMI-Milam for disposal.

*Equipment utilized during excavation:

*TL-26

*TCM

*17-KW

*X331

*Subcontractors:

*WMI-landfill

*B. Garcia-trucking

*Granthum-trucking

*Emerald Turf Farm

OHM CORPORATION
PROJECT 19531
GRANITE CITY, IL

QUANTITY SUMMARY FOR 906 Grand

SPECIAL WASTE (TONS)	BACKFILL (LOADS)	TOPSOIL (TONS)	CA-6 (TONS)	CA-7 (TONS)	SAND (TONS)	SOD CU.YDS.	CONCRETE	OTHER
88.34	4	30.6	15.35	29.3		180		

Sampling Analysis
Project #19531

Street/Number Address	0 - 3" Front and Back			
	A		A	
	PPM	No.	PPM	No.

906 Grand 283 382

	3 - 6" Front and Back			
	B		B	
	PPM	No.	PPM	No.


2350 277
196 66

	6 - 12" Front and Back			
	C		C	
	PPM	No.	PPM	No.

394 537
767 4460

	Depth	
	Excav.	
	(inch)	

12

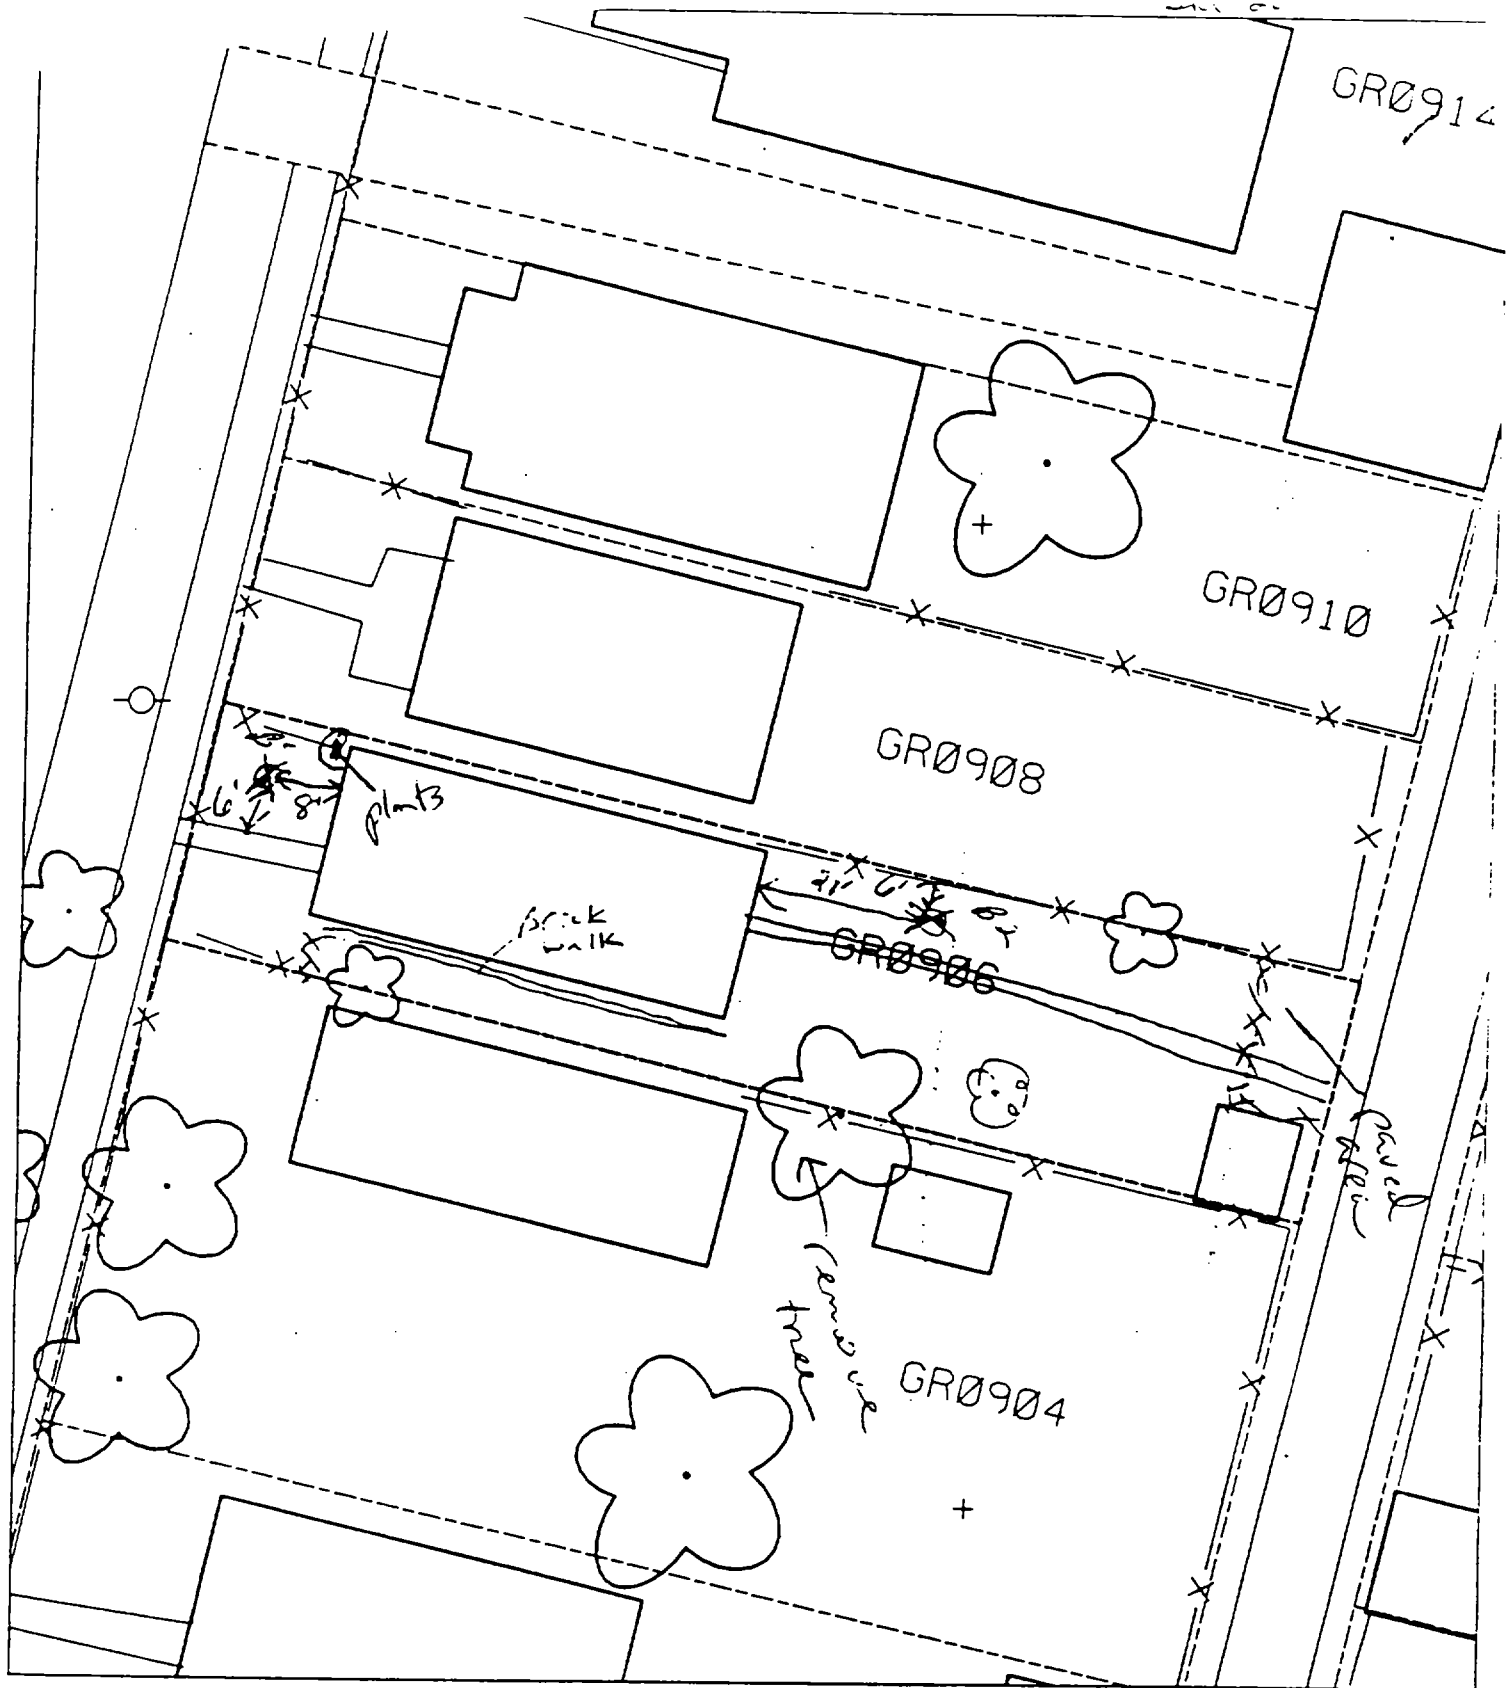

2 paved + house 30' 70'

B' - 6' north of sidewalk & 8' west of house.

B2 - 6' south of fence & 20' east of house.

2

3

4

907/15 Grand

Action Date: 10/9/97

Loadout: 10/14/97

Restoration Begins: 10/14/97

Restoration Completed: 10/30/97

*Stack emission sites were not sampled for verification due to the fact that a pre-determined depth for excavation was given to OHM by USACE.

*An excavation depth of 12 inches was established by USACE prior to work commencing.

*The excavation of special waste yielded a total of 284.93 cubic yards, which was shipped to WMI-Milam for disposal.

*Equipment utilized during excavation:

*TL-26

*TCM

*17-KW

*X331

*Subcontractors:

*WMI-landfill

*B. Garcia-trucking

*Granthum-trucking

*Emerald Turf Farm

OHM CORPORATION
PROJECT 19531
GRANITE CITY, IL

QUANTITY SUMMARY FOR 907/15 Grand

SPECIAL WASTE (TONS)	BACKFILL (LOADS)	TOPSOIL (TONS)	CA-6 (TONS)	CA-7 (TONS)	SAND (TONS)	SOD CU.YDS.	CONCRETE	OTHER
370.42	39	54.24	14.8	15.05		1260		

Sampling Analysis
Project #19531

0 - 3" Front and Back

Street/Number Address	A	
	PPM	PPM
	No.	No.

907/15 Grand 398 1880

3 - 6" Front and Back

B	B	
	PPM	PPM
	No.	No.

405 572


6 - 12" Front and Back

C	C	
	PPM	PPM
	No.	No.

334 915
213 173
271 602

Depth
Excav.
(inch)

12

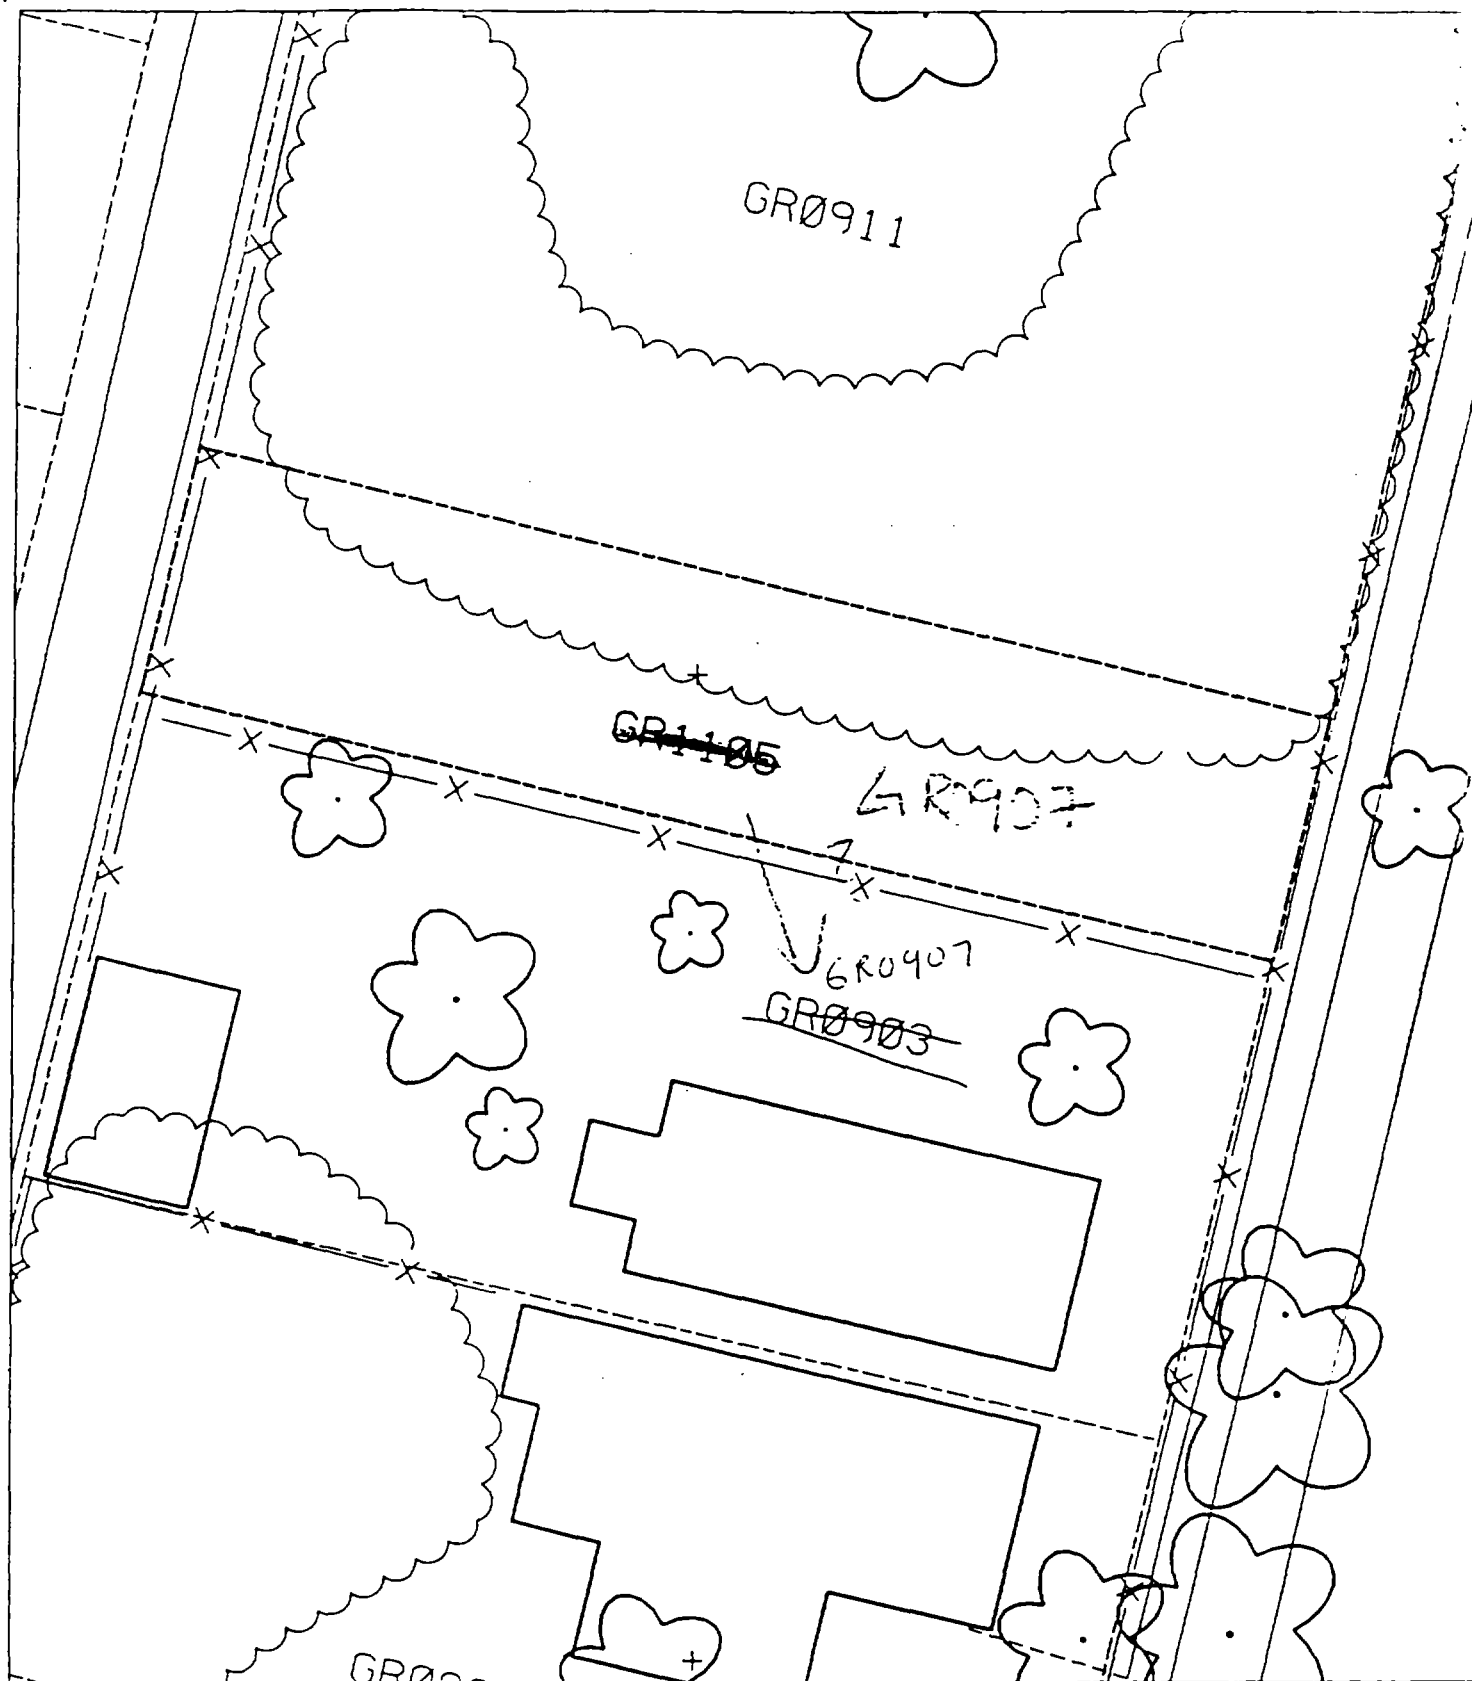

Z Part of ~~223~~
or 911

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914 Grand

Action Date: 9/3/97

Loadout: 9/4/97

Restoration Begins: 9/4/97

Restoration Completed: 10/1/97

*Stack emission sites were not sampled for verification due to the fact that a pre-determined depth for excavation was given to OHM by USACE.

*An excavation depth of 12 inches was established by USACE prior to work commencing.

*The excavation of special waste yielded a total of 52.79 cubic yards, which was shipped to WMI-Milam for disposal.

*Equipment utilized during excavation:

*TL-26

*TCM

*17-KW

*X331

*Subcontractors:

*WMI-landfill

*B. Garcia-trucking

*Granthum-trucking

*Emerald Turf Farm

OHM CORPORATION
PROJECT 19531
GRANITE CITY, IL

QUANTITY SUMMARY FOR 914 Grand

SPECIAL WASTE (TONS)	BACKFILL (LOADS)	TOPSOIL (TONS)	CA-6 (TONS)	CA-7 (TONS)	SAND (TONS)	SOD CU.YDS.	CONCRETE	OTHER
68.63	6	31.35	43.6	26.5		300		

**Sampling Analysis
Project #19531**

0 - 3" Front and Back

Street/Number Address	A		A	
	PPM	No.	PPM	No.
914 Grand	234	648		
	279	514		


3 - 6" Front and Back

B	B		B	
	PPM	No.	PPM	No.
193	615			
310	511			

6 - 12" Front and Back

C	C		C	
	PPM	No.	PPM	No.
127	793			
391	502			

Depth Excav. (inch)
12

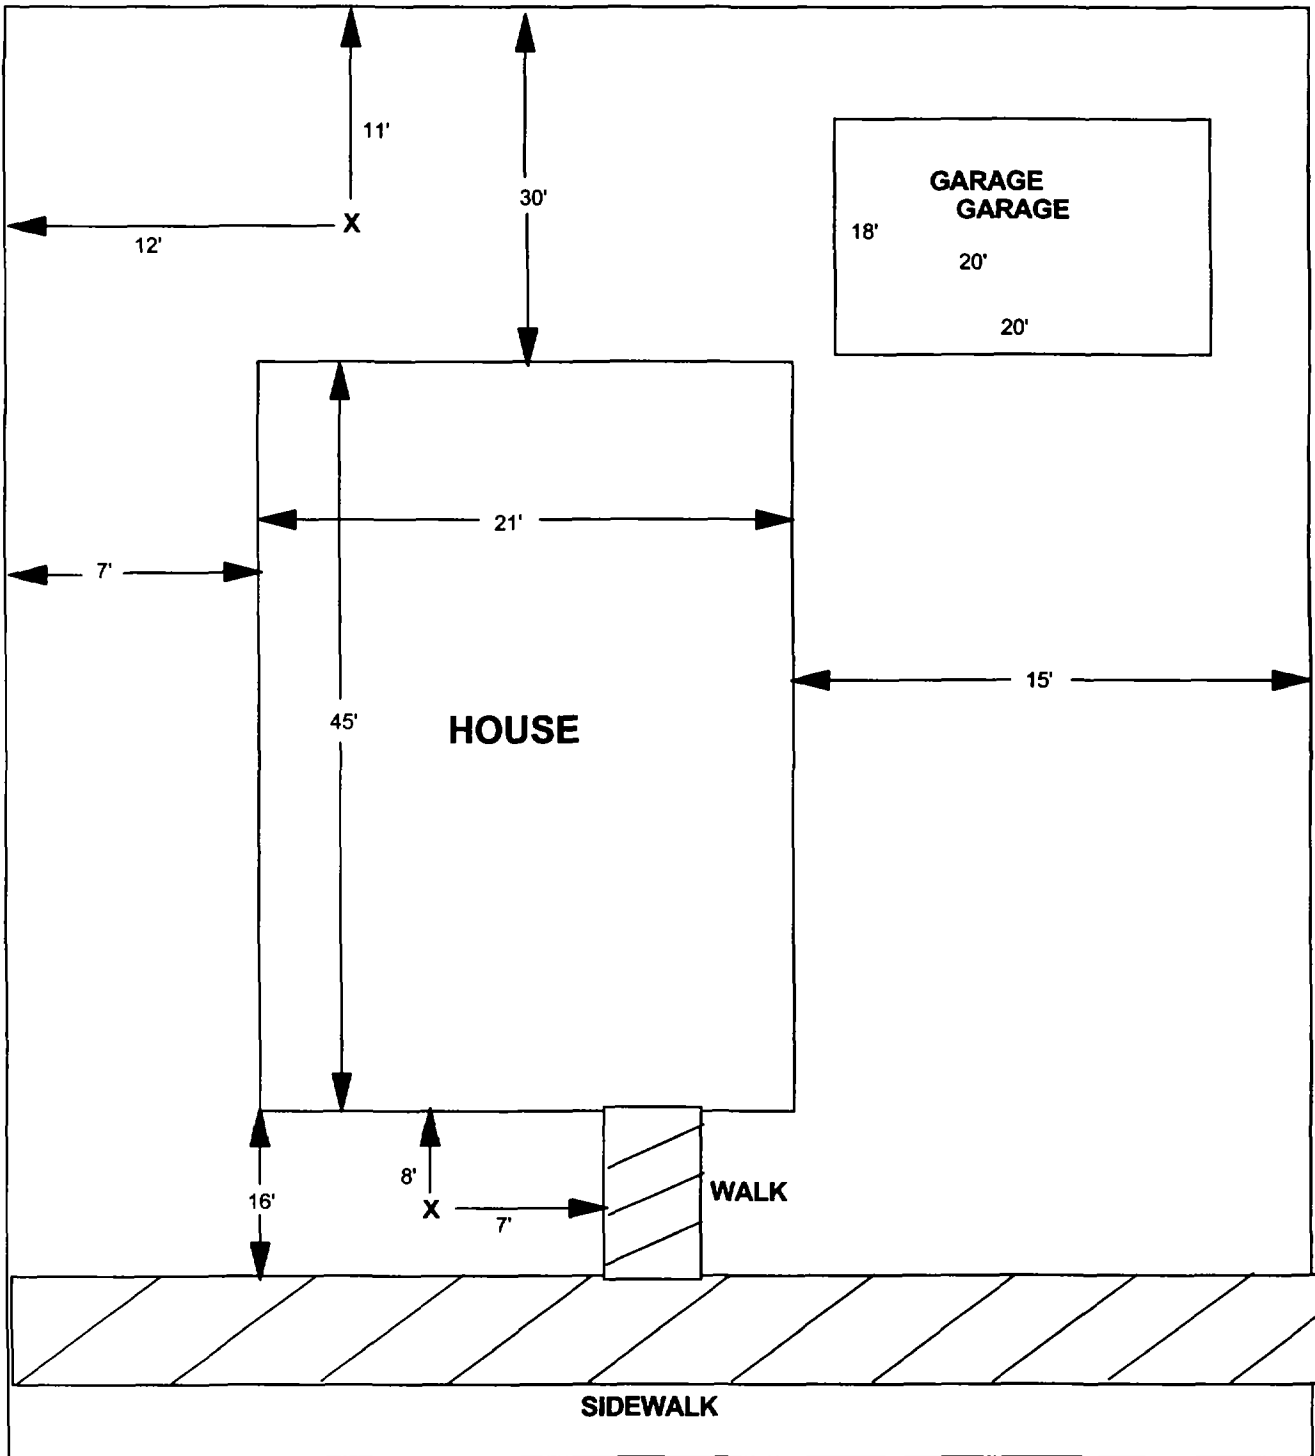

X = SAMPLE POINT

914 GRAND

**TOTAL
DIMENSIONS
91'X33'**

OHM 
Corporation
Findlay, Ohio

Drawn By: JG	Checked By:
Date: 8/17/98	Approved By:
Scale: NTS	Drawing No:

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2

3

916 Grand

Action Date: 9/11/97

Loadout: 9/12/97

Restoration Begins: 9/13/97

Restoration Completed: 10/6/97

*Stack emission sites were not sampled for verification due to the fact that a pre-determined depth for excavation was given to OHM by USACE.

*An excavation depth of 12 inches was established by USACE prior to work commencing.

*The excavation of special waste yielded a total of 41.21 cubic yards, which was shipped to WMI-Milam for disposal.

*Equipment utilized during excavation:

*TL-26

*TCM

*17-KW

*X331

*Subcontractors:

*WMI-landfill

*B. Garcia-trucking

*Granthum-trucking

*Schneider Turf Farm

OHM CORPORATION
PROJECT 19531
GRANITE CITY, IL

QUANTITY SUMMARY FOR

916 Grand

SPECIAL WASTE (TONS)	BACKFILL (LOADS)	TOPSOIL (TONS)	CA-6 (TONS)	CA-7 (TONS)	SAND (TONS)	SOD CU.YDS.	CONCRETE	OTHER
53.58	3	32.02				180		

**Sampling Analysis
Project #19531**

0 - 3" Front and Back				
Street/Number Address	A	A	A	
	PPM	PPM	PPM	
	No.	No.	No.	

916 Grand 640 1110

3 - 6" Front and Back				
Street/Number Address	B	B	B	
	PPM	PPM	PPM	
	No.	No.	No.	


162 6737
546 565

6 - 12" Front and Back				
Street/Number Address	C	C	C	
	PPM	PPM	PPM	
	No.	No.	No.	

597 376
653 570

Depth
Excav. (inch)

12

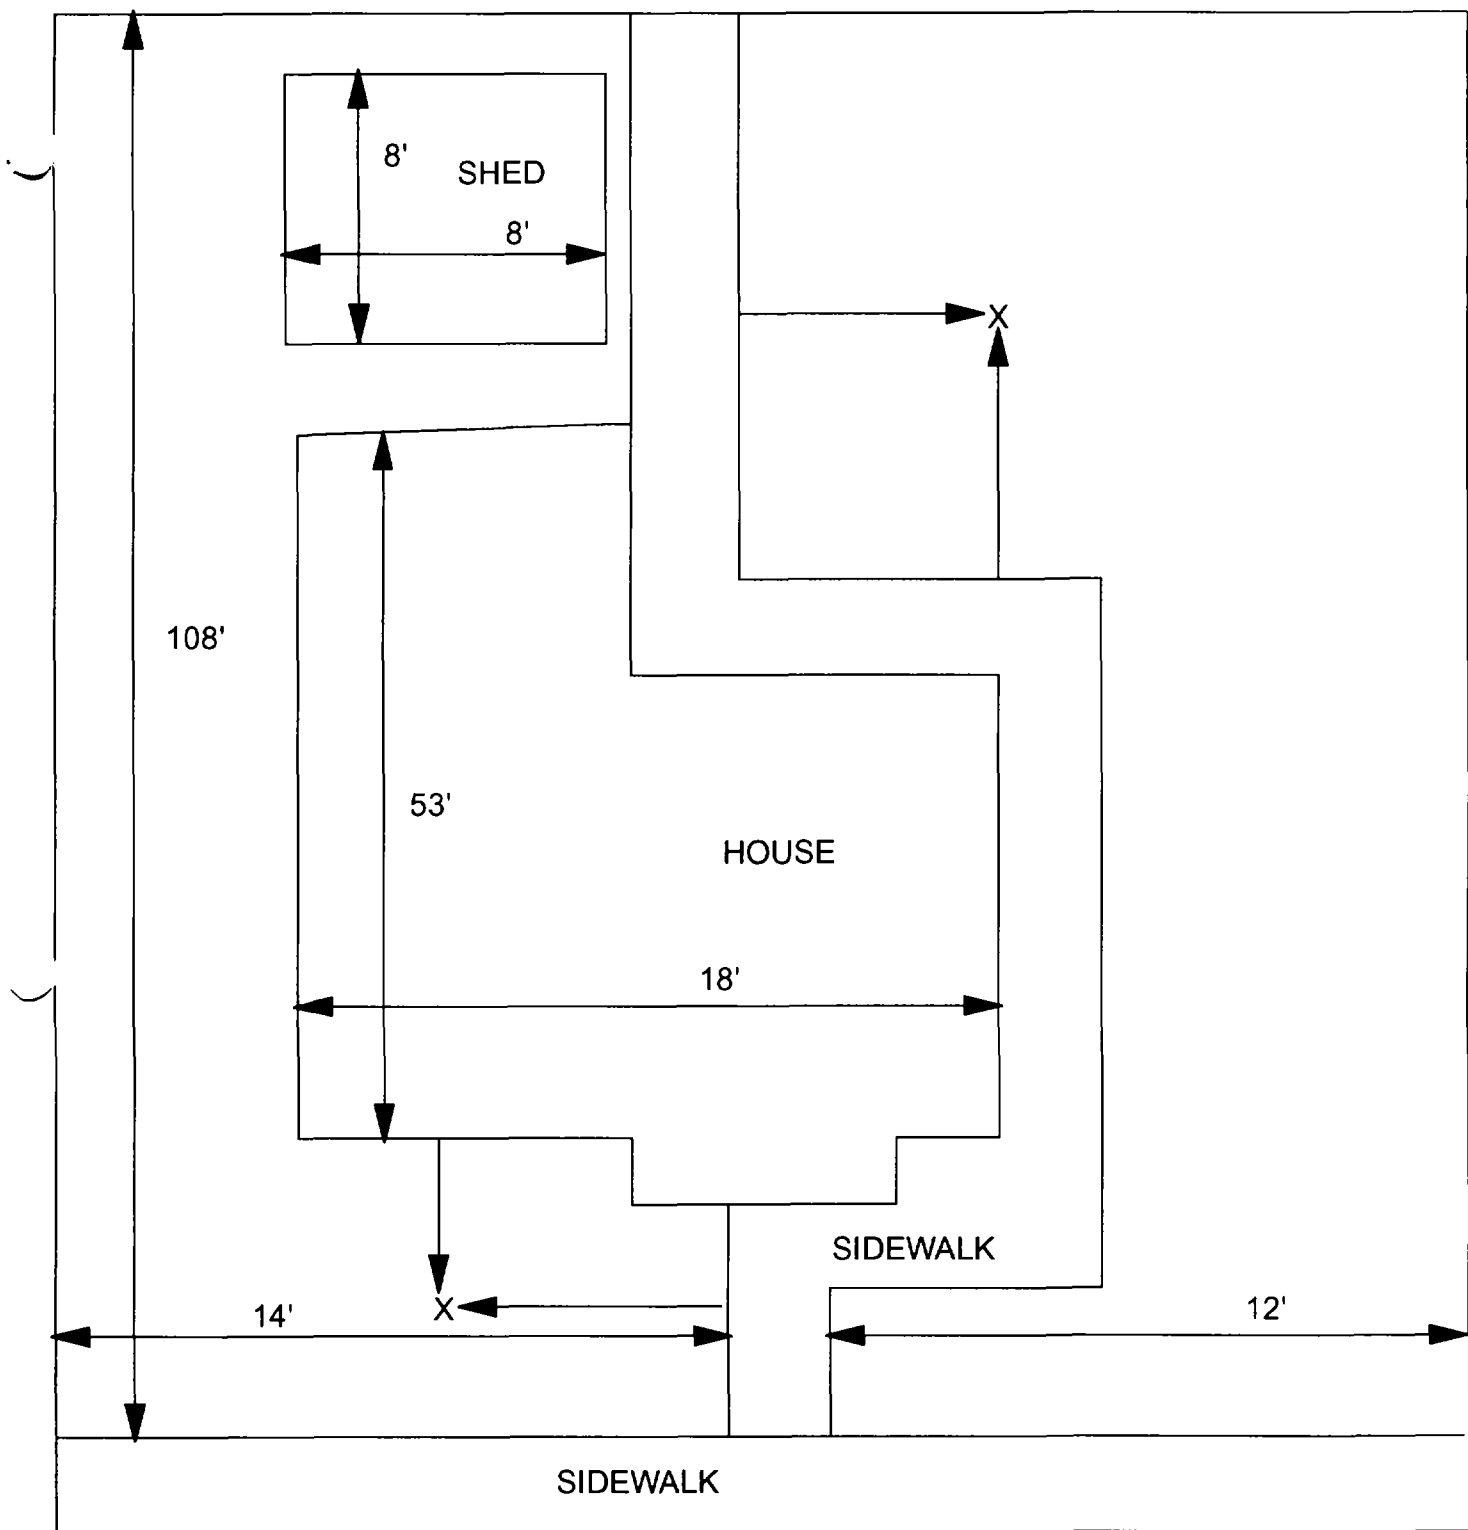

X = SAMPLE POINT

916 GRAND
26' X 108'

OHM 
Corporation
Findlay, Ohio

Drawn By: **EDJ** Checked By:

Date: **7/29/98** Approved By:

Scale: **NTS** Drawing No:

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921 Grand

Action Date: 10/15/97

Loadout: 10/18/97

Restoration Begins: 10/20/97

Restoration Completed: 10/30/97

*Stack emission sites were not sampled for verification due to the fact that a pre-determined depth for excavation was given to OHM by USACE.

*An excavation depth of 12 inches was established by USACE prior to work commencing.

*The excavation of special waste yielded a total of 34.77 cubic yards, which was shipped to WMI-Milam for disposal.

*Equipment utilized during excavation:

*TL-26

*TCM

*17-KW

*X331

*Subcontractors:

*WMI-landfill

*B. Garcia-trucking

*Granthum-trucking

*Emerald Turf Farm

OHM CORPORATION
PROJECT 19531
GRANITE CITY, IL

QUANTITY SUMMARY FOR 921 Grand

SPECIAL WASTE (TONS)	BACKFILL (LOADS)	TOPSOIL (TONS)	CA-6 (TONS)	CA-7 (TONS)	SAND (TONS)	SOD CU.YDS.	CONCRETE	OTHER
45.29	4	34.92				240		

Sampling Analysis
Project #19531

0 - 3" Front and Back

	A	A	A
Street/Number	PPM	PPM	PPM
Address	No.	No.	No.

921 Grand 617 638

3 - 6" Front and Back

B	B	B
PPM	PPM	PPM
No.	No.	No.

428 488


6 - 12" Front and Back

C	C	C
PPM	PPM	PPM
No.	No.	No.

244 510
339 302
816 1097

Depth
Excav.
(inch)

12

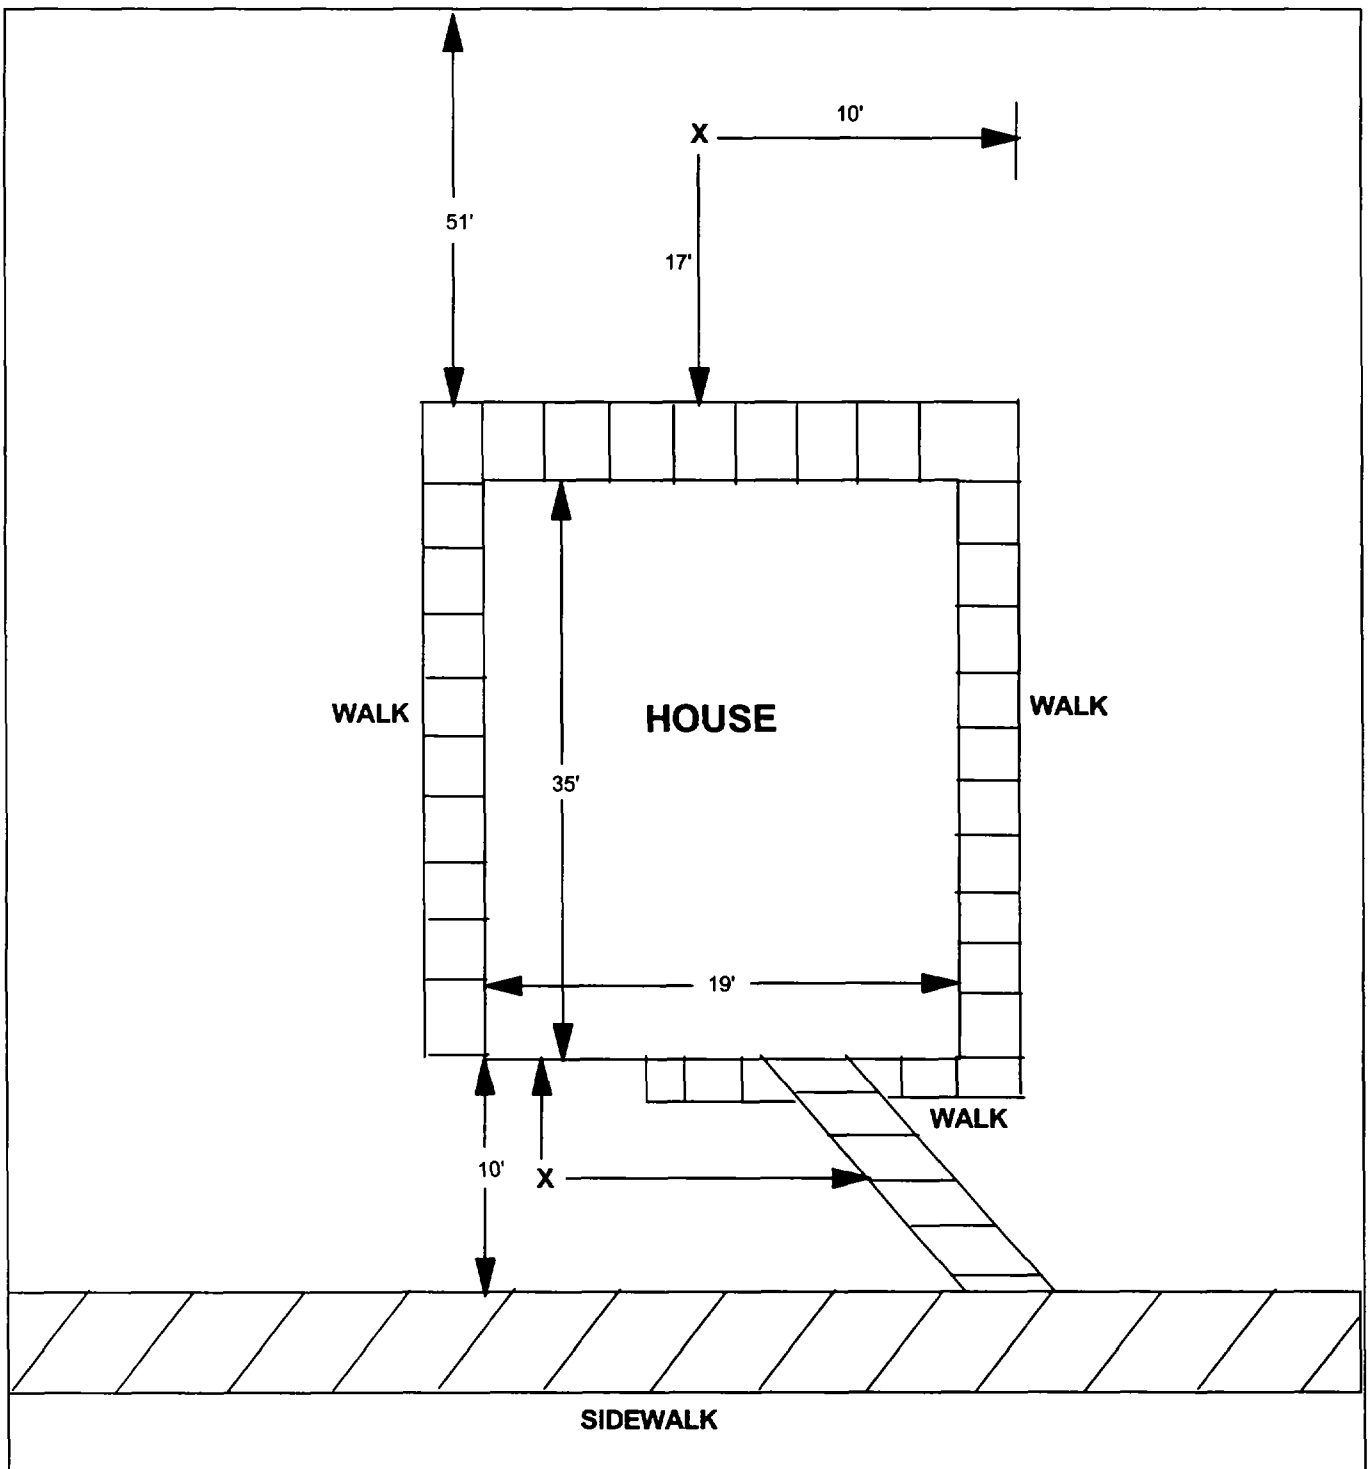

X = SAMPLE POINT

921 GRAND

**TOTAL
DIMENSIONS
96'X20'**

OHM 
Corporation
Findlay, Ohio

Drawn By: jg	Checked By:
Date: 8/17/98	Approved By:
Scale: NTS	Drawing No:

923 Grand

Action Date: 10/15/97

Loadout: 10/18/97

Restoration Begins: 10/20/97

Restoration Completed: 10/30/97

*Stack emission sites were not sampled for verification due to the fact that a pre-determined depth for excavation was given to OHM by USACE.

*An excavation depth of 3 inches was established by USACE prior to work commencing.

*The excavation of special waste yielded a total of 53.38 cubic yards, which was shipped to WMI-Milam for disposal.

*Equipment utilized during excavation:

*TL-26

*TCM

*17-KW

*X331

*Subcontractors:

*WMI-landfill

*B. Garcia-trucking

*Granthum-trucking

*Emerald Turf Farm

OHM CORPORATION
PROJECT 19531
GRANITE CITY, IL

QUANTITY SUMMARY FOR 923 Grand

SPECIAL WASTE (TONS)	BACKFILL (LOADS)	TOPSOIL (TONS)	CA-6 (TONS)	CA-7 (TONS)	SAND (TONS)	SOD CU.YDS.	CONCRETE	OTHER
69.4	2	28.47				240		

**Sampling Analysis
Project #19531**

0 - 3" Front and Back

Street/Number Address	A		A	
	PPM	No.	PPM	No.

3 - 6" Front and Back

	B		B	
	PPM	No.	PPM	No.

6 - 12" Front and Back

	C		C	
	PPM	No.	PPM	No.

	Depth	
	Excav.	(inch)


923 Grand

1362 1692

398 452

167 404

3

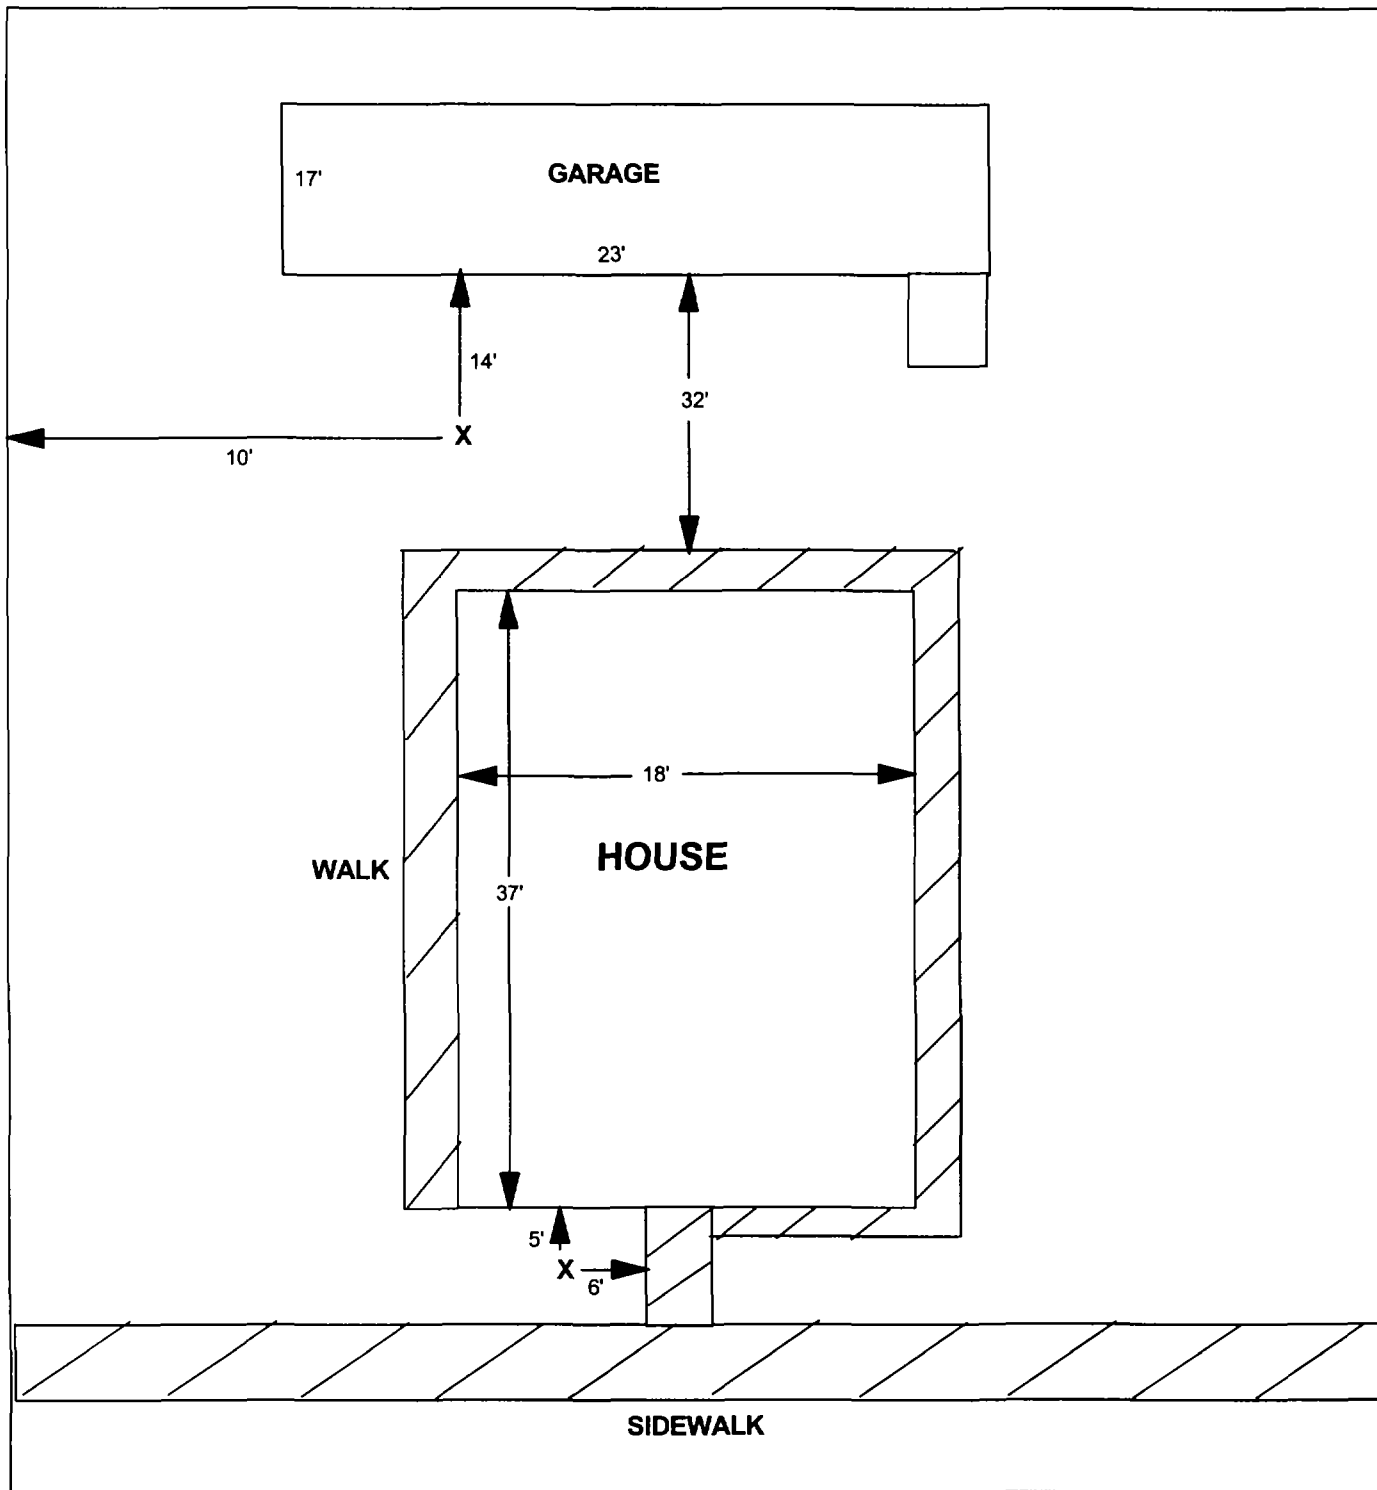

X = SAMPLE POINT

923 GRAND

**TOTAL
DIMENSIONS
95'X20'**

OHM 
Corporation
Findlay, Ohio

Drawn By: **JG** Checked By:

Date: 8/18/98 Approved By:

Scale: **NTS** Drawing No:

1000 Grand

Action Date: 8/7/97

Loadout: 8/8/97

Restoration Begins: 8/8/97

Restoration Completed: 8/16/97

*Stack emission sites were not sampled for verification due to the fact that a pre-determined depth for excavation was given to OHM by USACE.

*An excavation depth of 3 inches was established by USACE prior to work commencing.

*The excavation of special waste yielded a total of 20.99 cubic yards, which was shipped to WMI-Milam for disposal.

*Equipment utilized during excavation:

*TL-26

*TCM

*X331

*17-KW

*Subcontractors:

*WMI-landfill

*B. Garcia-trucking

*Grantham-trucking

*Emerald-turf farm

**OHM CORPORATION
PROJECT 19531
GRANITE CITY, IL**

QUANTITY SUMMARY FOR

1000 Grand

SPECIAL WASTE (TONS)	BACKFILL (LOADS)	TOPSOIL (TONS)	CA-6 (TONS)	CA-7 (TONS)	SAND (TONS)	SOD CU.YDS.	CONCRETE	OTHER
27.29	2	14.78				210		

**Sampling Analysis
Project #19531**

0 - 3" Front and Back

Street/Number Address	A		A	
	PPM	No.	PPM	No.

3 - 6" Front and Back

	B		B	
	PPM	No.	PPM	No.

6 - 12" Front and Back

	C		C	
	PPM	No.	PPM	No.


	Depth	
	Excav.	(inch)

1000 Grand 516 701

316 494

198 476

3

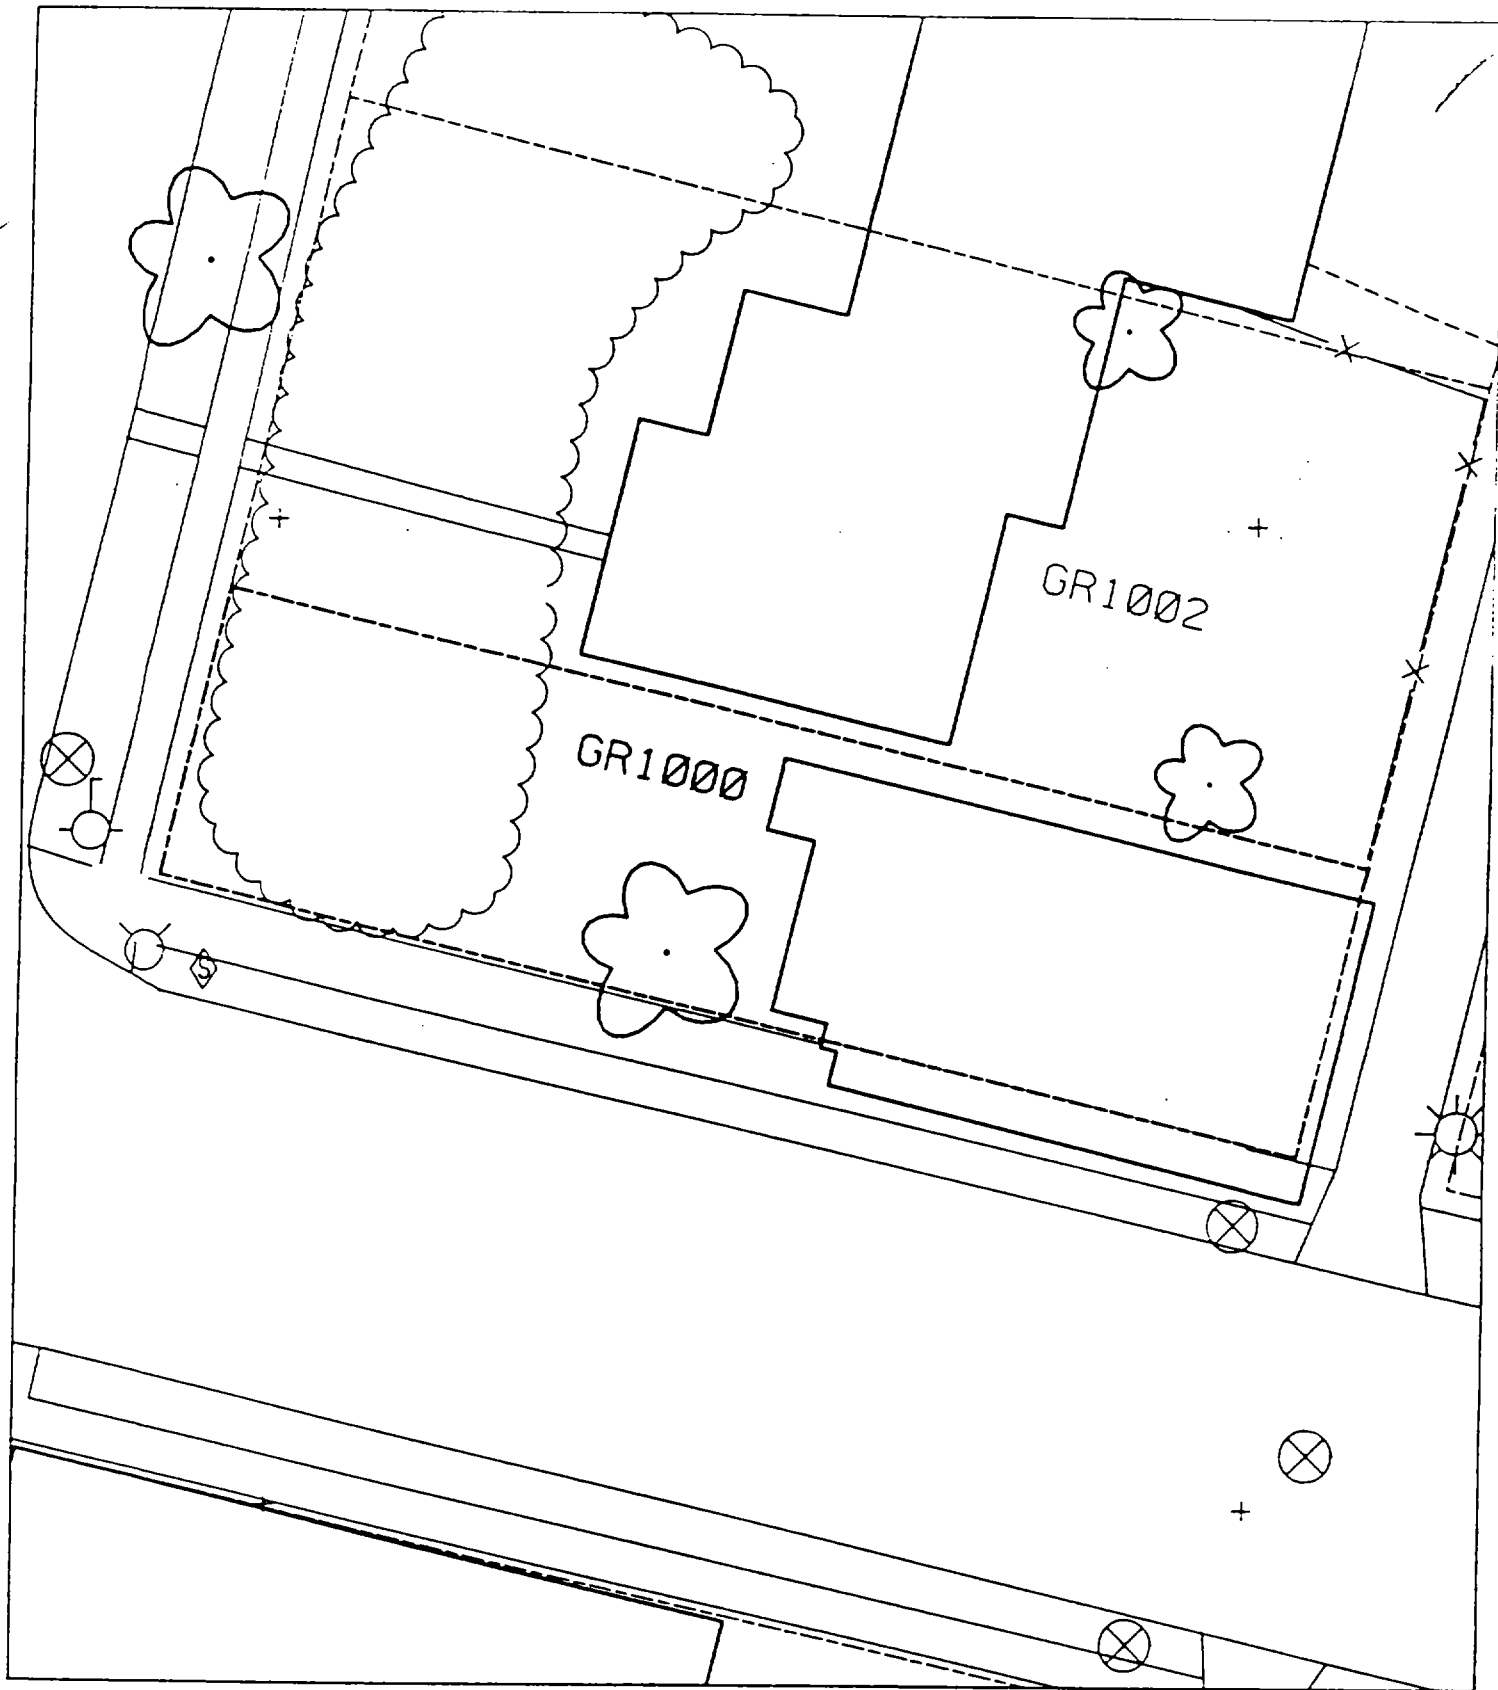

1

2

3

1012 Grand

Action Date: 7/25/97

— Loadout: 7/28/97

Restoration Begins: 7/28/97

Restoration Completed: 8/16/97

*Stack emission sites were not sampled for verification due to the fact that a pre-determined depth for excavation was given to OHM by USACE.

*An excavation depth of 12 inches was established by USACE prior to work commencing.

*The excavation of special waste yielded a total of 131.53 cubic yards, which was shipped to WMI-Milam for disposal.

*Equipment utilized during excavation:

*TL-26

*X331

*Subcontractors:

*WMI-landfill

*B. Garcia-trucking

*Granthum-trucking

*Emerald Turf Farm

OHM CORPORATION
PROJECT 19531
GRANITE CITY, IL


QUANTITY SUMMARY FOR 1012 Grand

SPECIAL WASTE (TONS)	BACKFILL (LOADS)	TOPSOIL (TONS)	CA-6 (TONS)	CA-7 (TONS)	SAND (TONS)	SOD CU.YDS.	CONCRETE	OTHER
170.99	11	15.2	59.3	14.9		450		

**Sampling Analysis
Project #19531**

Street/Number Address	0 - 3" Front and Back				3-6" Front and Back				6-12" Front and Back				Depth Excav. (inch)
	A	A	A	A	B	B	B	B	C	C	C	C	
	PPM	PPM	PPM	PPM	PPM	PPM	PPM	PPM	PPM	PPM	PPM	PPM	
	No.	No.	No.	No.	No.	No.	No.	No.	No.	No.	No.	No.	
1012 Grand	392	810			335	654			279	1010			12
	597	1202			475	975			196	1010			

Sh+ 21

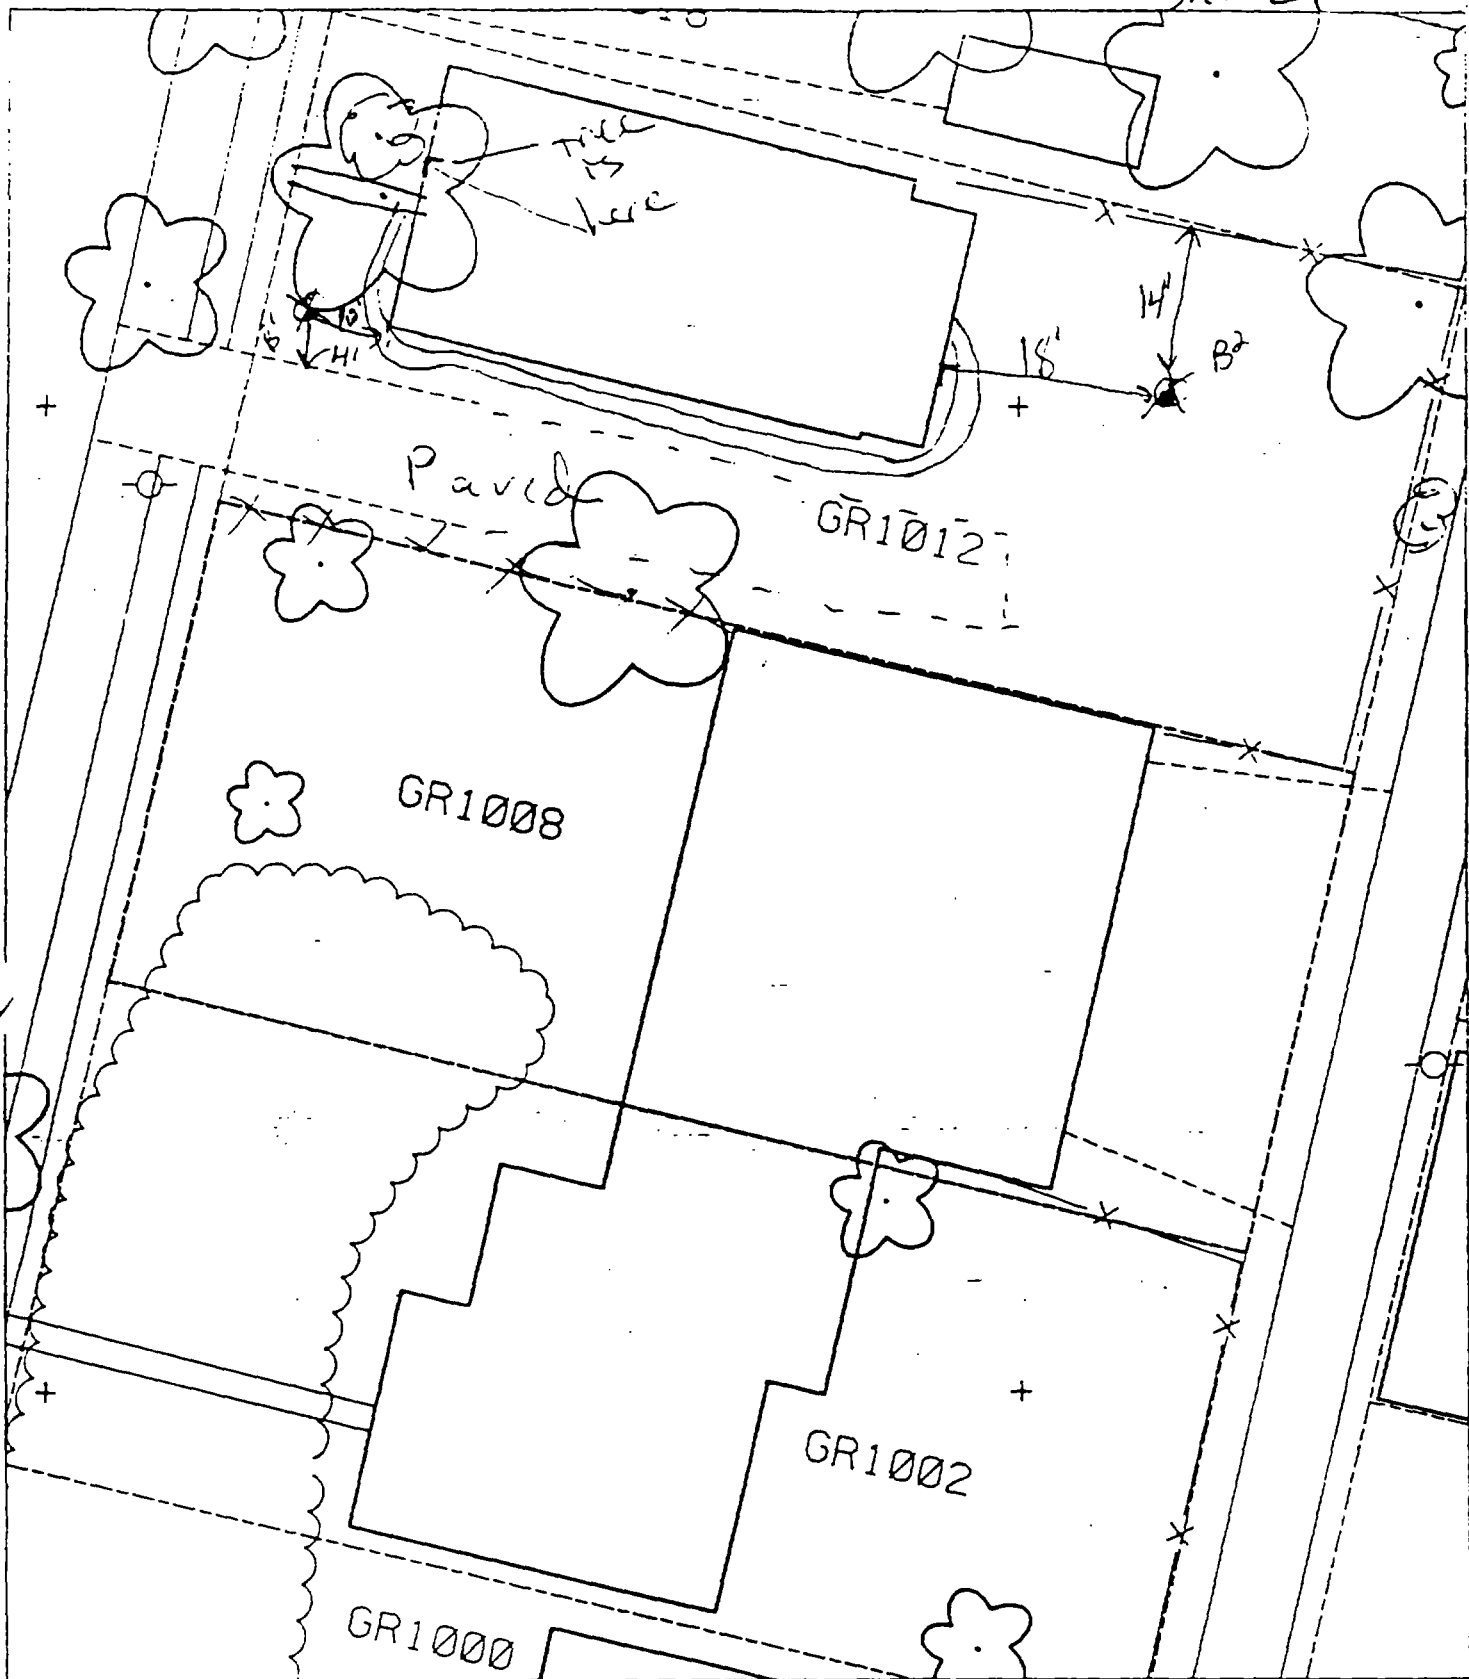

13'-10' west of corner of house & 4' north of drive.

16' east of house & 14' south of fence.

1

2

3

4

Action Date: 5/29/97

Loadout: 6/4/97

Restoration Begins: 6/5/97

Restoration Completed: 6/18/97

*Stack emission sites were not sampled for verification due to the fact that a pre-determined depth for excavation was given to OHM by USACE.

*An excavation depth of 12 inches was established by USACE prior to work commencing.

*The excavation of special waste yielded a total of 189.40 cubic yards, which was shipped to WMI-Milam for disposal.

*Equipment utilized during excavation:

*TL-26

*TCM

*X331

*17-KW

*Subcontractors:

*WMI-landfill

*B. Garcia-trucking

*Granthum-trucking

*Schneider Turf Farm

OHM CORPORATION
PROJECT 19531
GRANITE CITY, IL

QUANTITY SUMMARY FOR 1013/15/17/19 Grand

SPECIAL WASTE (TONS)	BACKFILL (LOADS)	TOPSOIL (TONS)	CA-6 (TONS)	CA-7 (TONS)	SAND (TONS)	SOD CU.YDS.	CONCRETE	OTHER
246.22	17	73.79				952.5		

**Sampling Analysis
Project #19531**

0 - 3" Front and Back

Street/Number Address	A		A	
	PPM	No.	PPM	No.
1017/19 Grand	589	613	454	
	615	1320		


3 - 6" Front and Back

B	B		B	
	PPM	No.	PPM	No.
435	387	523		
342	1180			

6 - 12" Front and Back

C	C		C	
	PPM	No.	PPM	No.
335	386	737		
232	891			

Depth Excav. (inch)
12

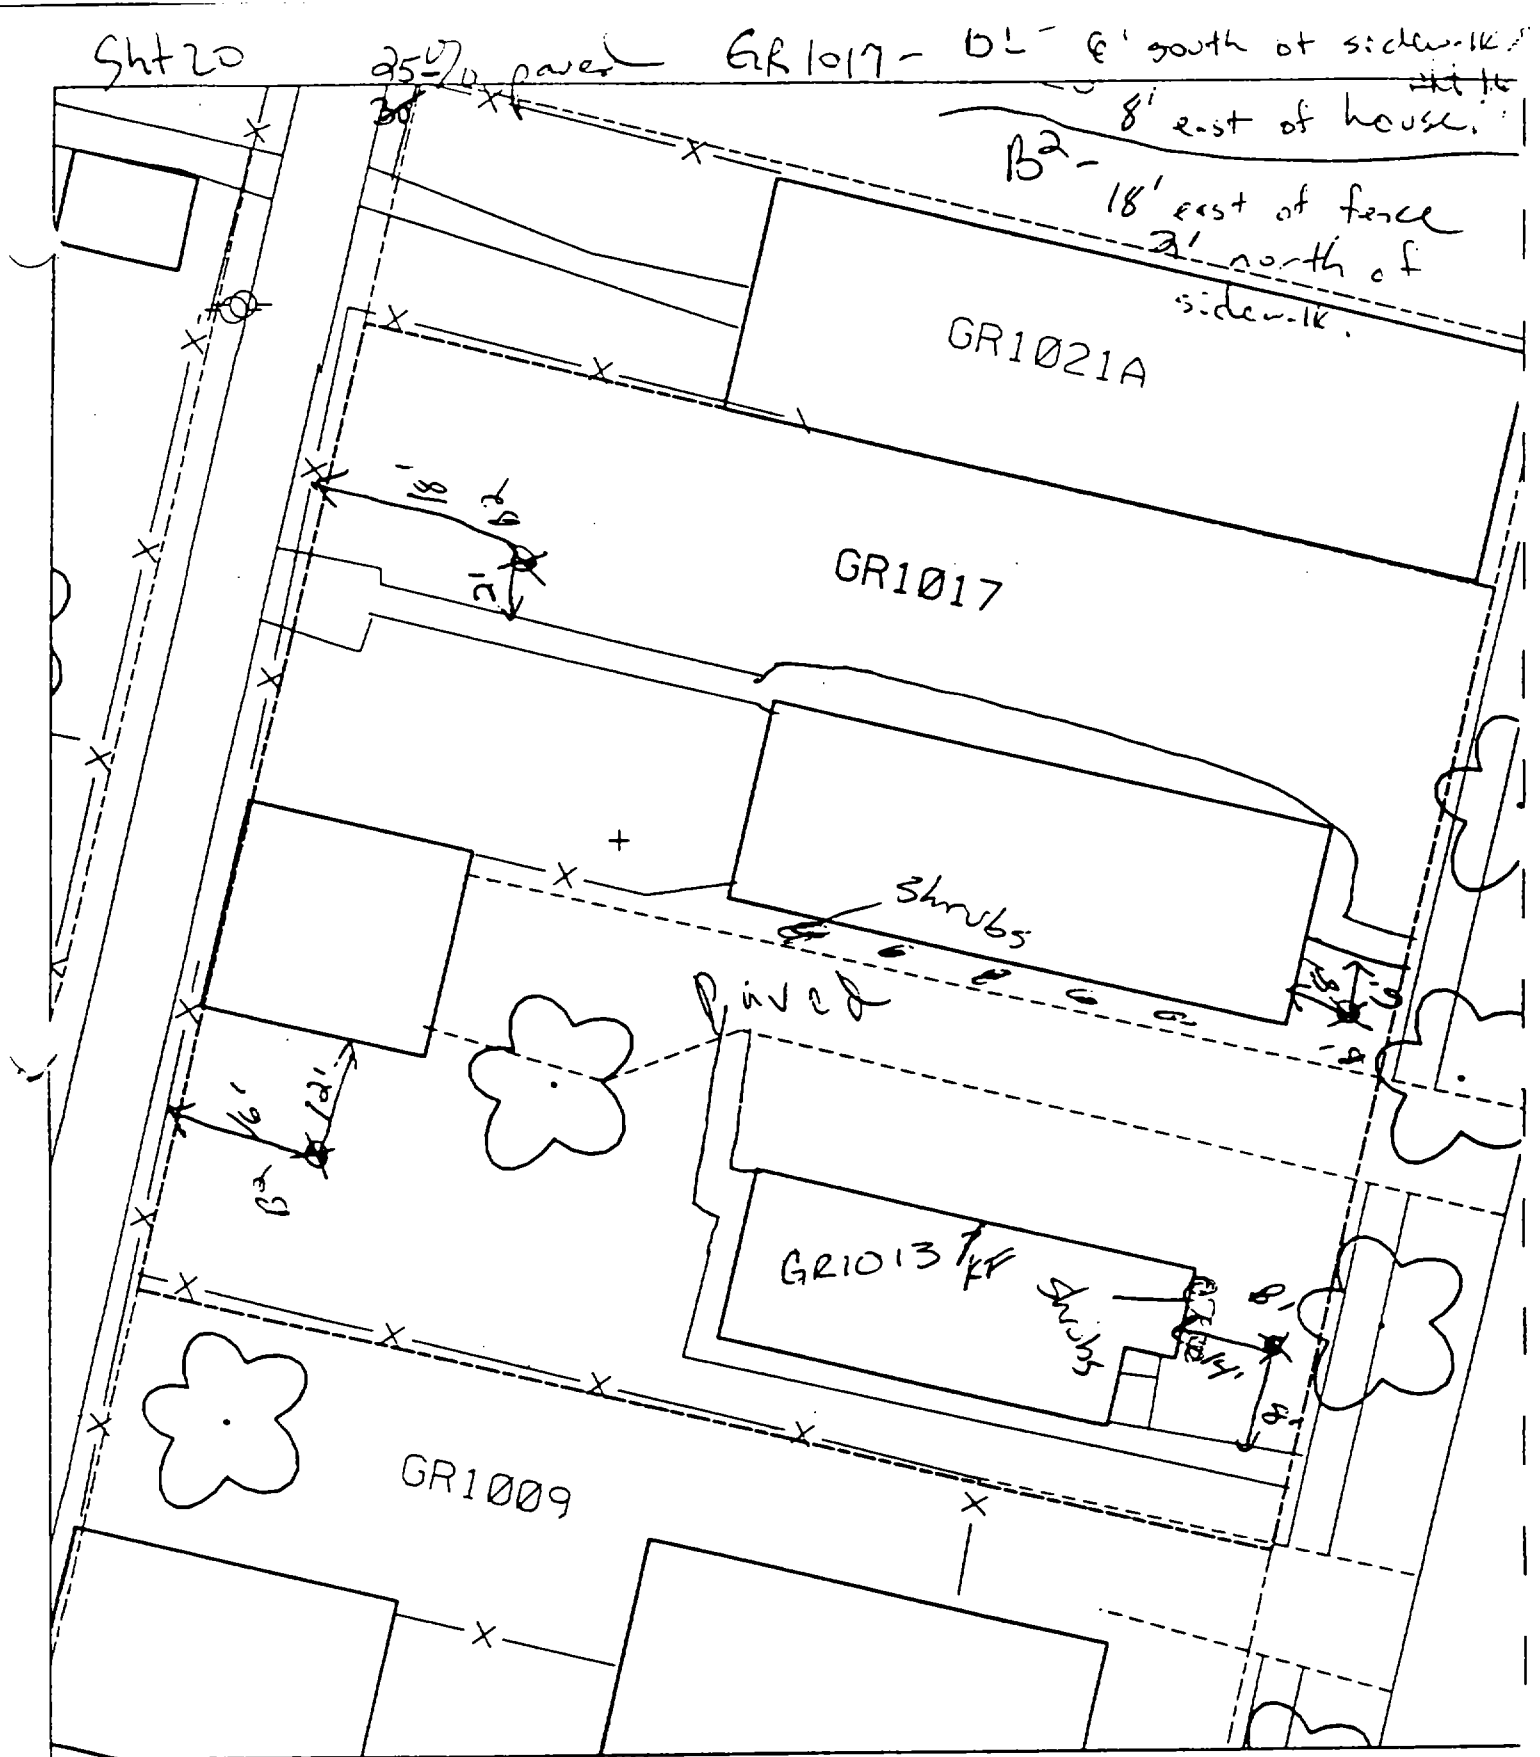

B1 - 14' east of house & 8' north of sidewalk.

70 paved - 40%

B2 - 12' south of garage & 16' east of fence.

1

2

3

1020 Grand

Action Date: 7/22/97

Loadout: 7/23/97

Restoration Begins: 7/24/97

Restoration Completed: 8/8/97

*Stack emission sites were not sampled for verification due to the fact that a pre-determined depth for excavation was given to OHM by USACE.

*An excavation depth of 12 inches was established by USACE prior to work commencing.

*The excavation of special waste yielded a total of 118.00 cubic yards, which was shipped to WMI-Milam for disposal.

*Equipment utilized during excavation:

*TL-26

*TCM

*X331

*17-KW

*Subcontractors:

*WMI-landfill

*B. Garcia-trucking

*Granthum-trucking

*Emerald Turf Farm

OHM CORPORATION
PROJECT 19531
GRANITE CITY, IL

QUANTITY SUMMARY FOR 1020 Grand

SPECIAL WASTE (TONS)	BACKFILL (LOADS)	TOPSOIL (TONS)	CA-6 (TONS)	CA-7 (TONS)	SAND (TONS)	SOD CU.YDS.	CONCRETE	OTHER
153.41	11	75.62				540		

**Sampling Analysis
Project #19531**

0 - 3" Front and Back

Street/Number Address	A		A	
	PPM	No.	PPM	No.

3 - 6" Front and Back

	B		B	
	PPM	No.	PPM	No.

6 - 12" Front and Back

	C		C	
	PPM	No.	PPM	No.

Depth	
Excav.	
(inch)	


1020 Grand

685 673

762 506

562 446

12

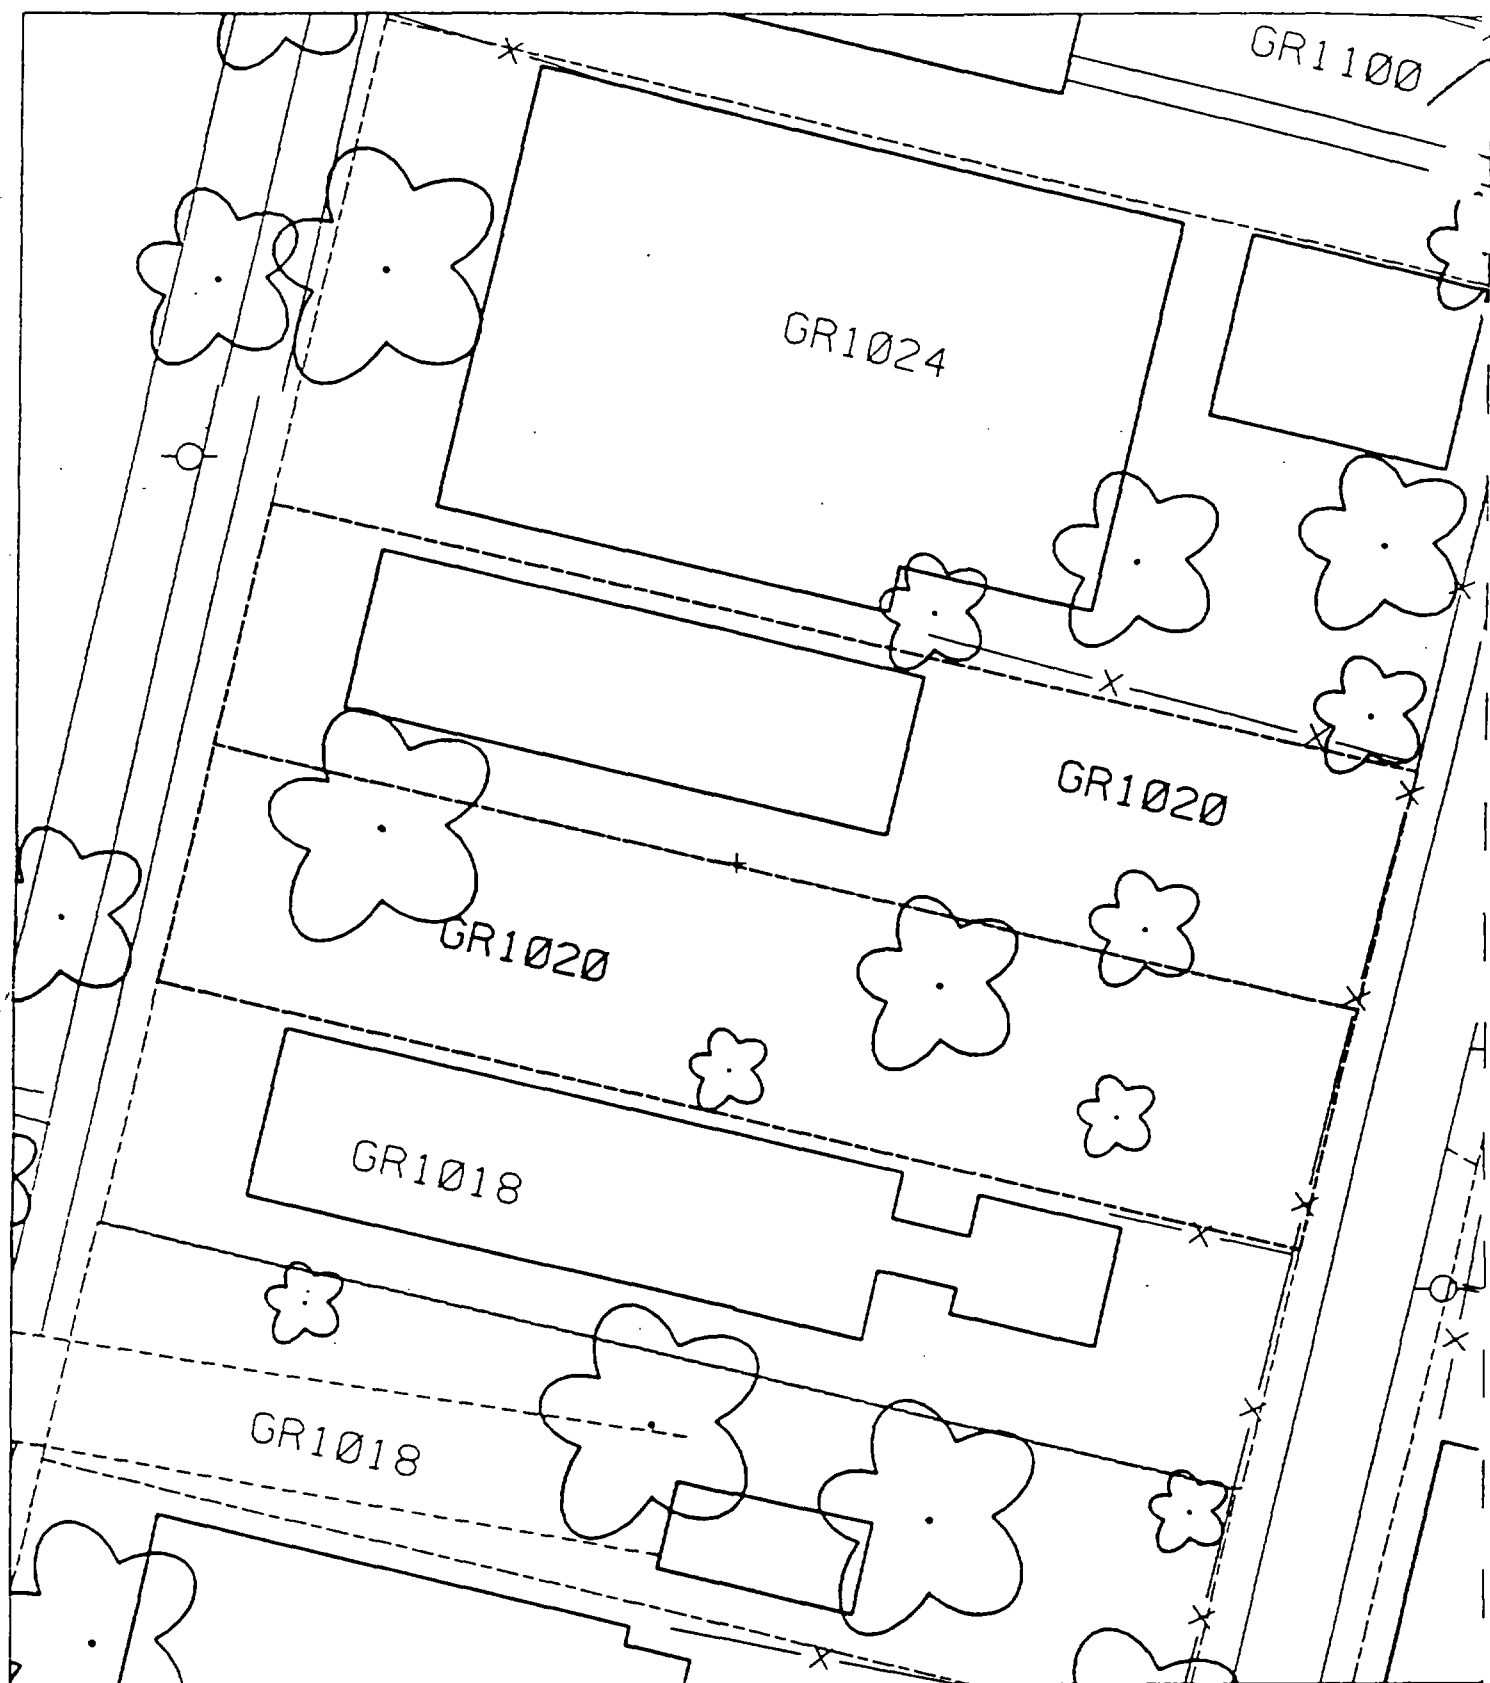

2

1

1

1

1

1021 Grand

Action Date: 6/28/97

Loadout: 6/30/97

Restoration Begins: 6/30/97

Restoration Completed: 7/18/97

*Stack emission sites were not sampled for verification due to the fact that a pre-determined depth for excavation was given to OHM by USACE.

*An excavation depth of 6 inches was established by USACE prior to work commencing.

*The excavation of special waste yielded a total of 26.88 cubic yards, which was shipped to WMI-Milam for disposal.

*Equipment utilized during excavation:

*TL-26

*TCM

*X331

*17-KW

*Subcontractors:

*WMI-landfill

*B. Garcia-trucking

*Granthum-trucking

*Schneider Turf Farm

OHM CORPORATION
PROJECT 19531
GRANITE CITY, IL

QUANTITY SUMMARY FOR

1021 Grand

SPECIAL WASTE (TONS)	BACKFILL (LOADS)	TOPSOIL (TONS)	CA-6 (TONS)	CA-7 (TONS)	SAND (TONS)	SOD CU.YDS.	CONCRETE	OTHER
34.95	2	15.7		15.1		127		

Sampling Analysis
Project #19531

0 - 3" Front and Back

Street/Number Address	A		A	
	PPM	No.	PPM	No.
	PPM	No.	PPM	No.

3 - 6" Front and Back

	B		B	
	PPM	No.	PPM	No.
	PPM	No.	PPM	No.

6 - 12" Front and Back

	C		C	
	PPM	No.	PPM	No.
	PPM	No.	PPM	No.

Depth Excav. (inch)


1021 Grand

442

556

481

6

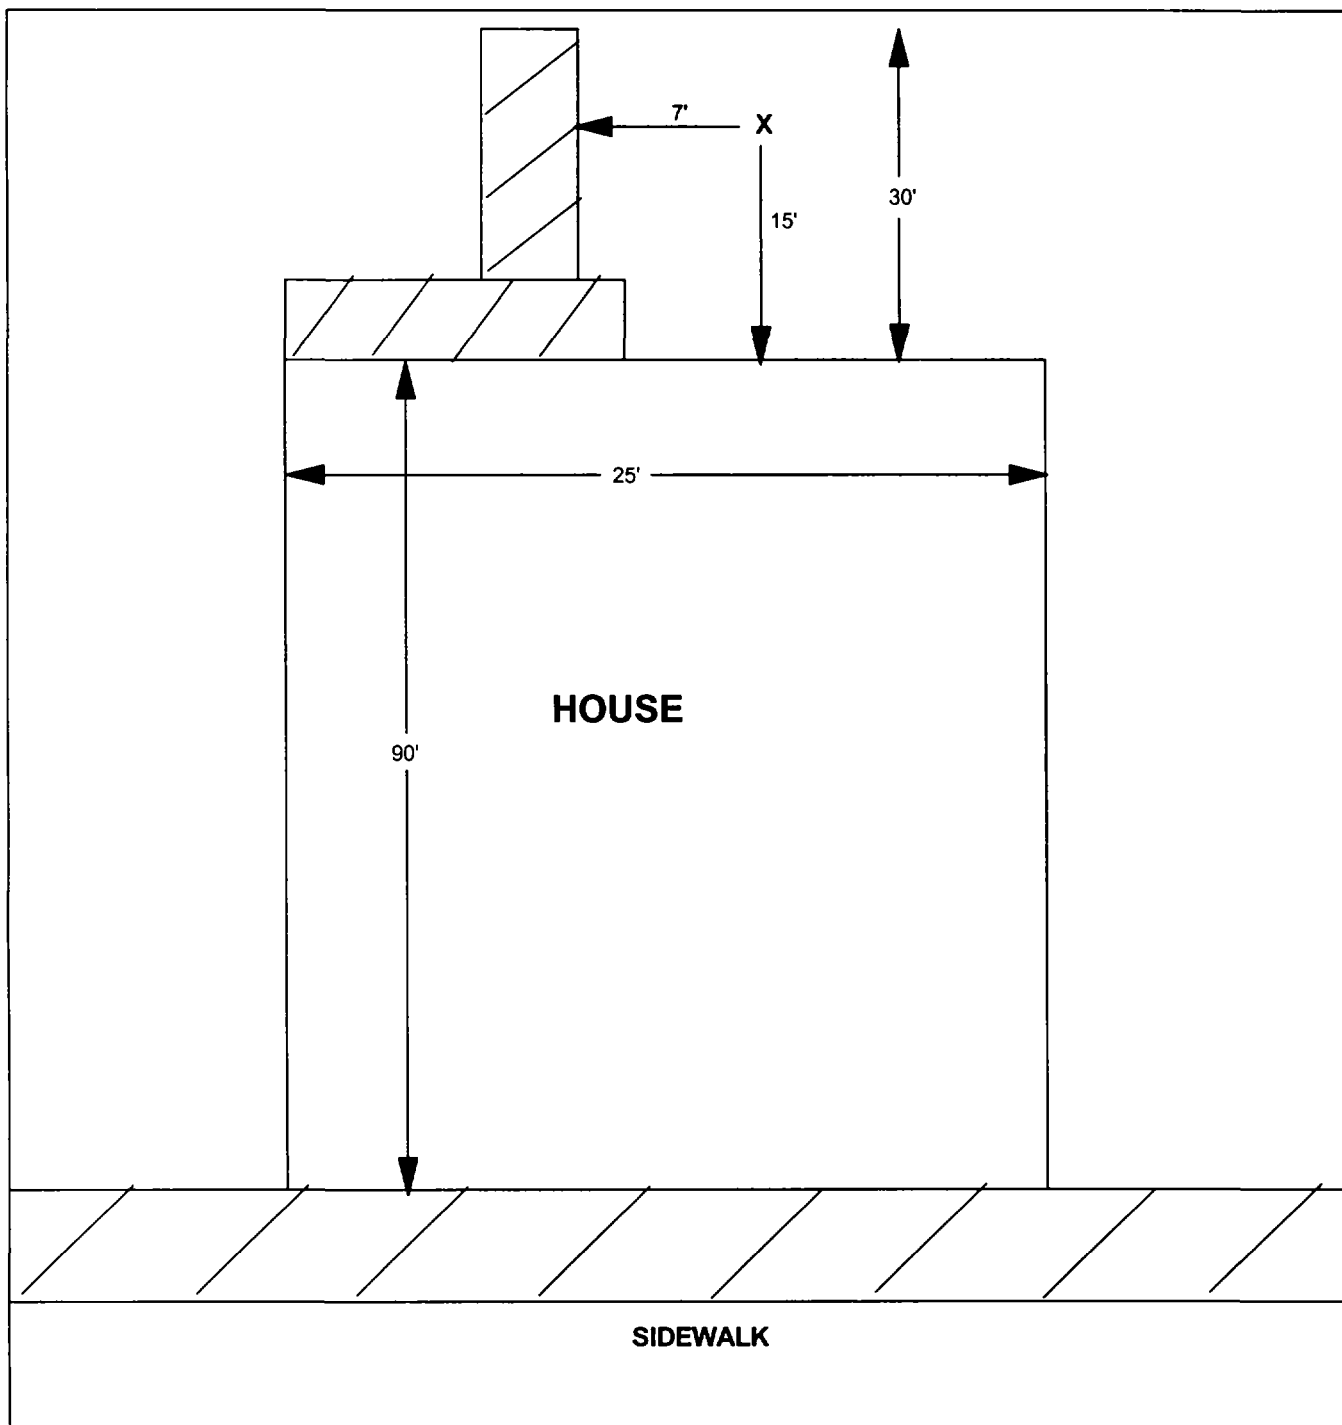

X = SAMPLE POINT

1021 GRAND

**TOTAL
DIMENSIONS
120'X25'**

OHM 
Corporation
Findlay, Ohio

Drawn By: JG	Checked By:
Date: 8/18/98	Approved By:
Scale: NTS	Drawing No:

1

2

3

4

1100 Grand

Action Date: 6/12/97

Loadout: 6/14/97

Restoration Begins: 6/18/97

Restoration Completed: 7/2/97

*Stack emission sites were not sampled for verification due to the fact that a pre-determined depth for excavation was given to OHM by USACE.

*An excavation depth of 12 inches was established by USACE prior to work commencing.

*The excavation of special waste yielded a total of 29.46 cubic yards, which was shipped to WMI-Milam for disposal.

*Equipment utilized during excavation:

*TL-26

*TCM

*X331

*17-KW

*Subcontractors:

*WMI-landfill

*B. Garcia-trucking

*Grantham-trucking

*Schneider-turf farm

**OHM CORPORATION
PROJECT 19531
GRANITE CITY, IL**

QUANTITY SUMMARY FOR

1100 Grand

SPECIAL WASTE (TONS)	BACKFILL (LOADS)	TOPSOIL (TONS)	CA-6 (TONS)	CA-7 (TONS)	SAND (TONS)	SOD CU.YDS.	CONCRETE	OTHER
38.31	5	49.55				254		

Sampling Analysis
Project #19531

Street/Number Address	0 - 3" Front and Back			
	A		A	
	PPM	No.	PPM	No.

1100 Grand 294 3360
485 864

	3 - 6" Front and Back			
	B		B	
	PPM	No.	PPM	No.


144 591
697 1020

	6 - 12" Front and Back			
	C		C	
	PPM	No.	PPM	No.

284 538
84 575

Depth
Excav.
(inch)

12

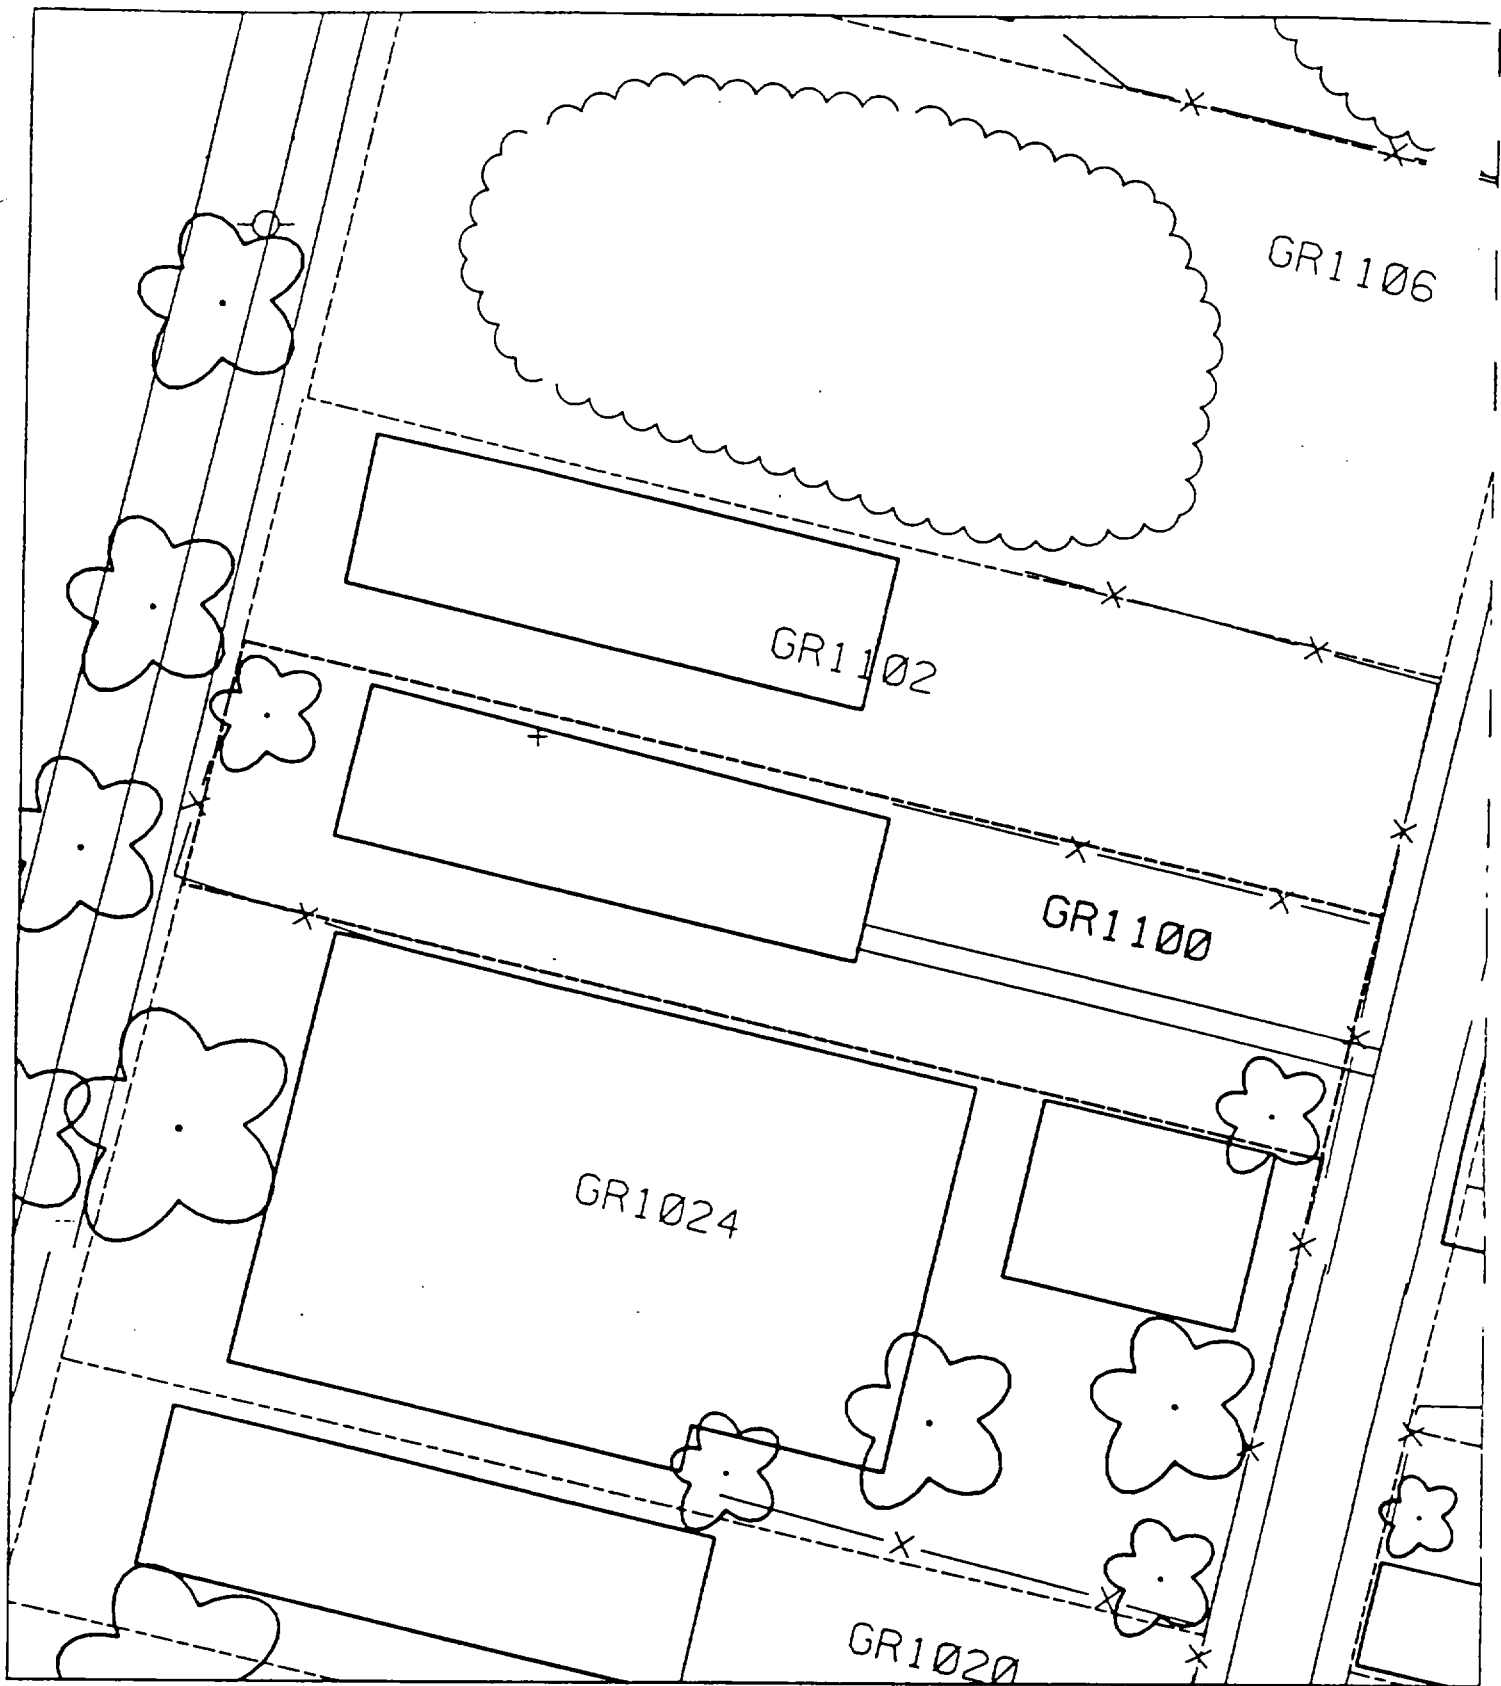

1101 Grand

Action Date: 6/7/97

— Loadout: 6/11/97

Restoration Begins: 6/11/97

Restoration Completed: 6/24/97

*Stack emission sites were not sampled for verification due to the fact that a pre-determined depth for excavation was given to OHM by USACE.

*An excavation depth of 12 inches was established by USACE prior to work commencing.

*The excavation of special waste yielded a total of 194.71 cubic yards, which was shipped to WMI-Milam for disposal.

*Equipment utilized during excavation:

*TL-26

*TCM

*X331

*17-KW

*Subcontractors:

*WMI-landfill

*B. Garcia-trucking

*Granthum-trucking

*Schneider Turf Farm

OHM CORPORATION
PROJECT 19531
GRANITE CITY, IL

QUANTITY SUMMARY FOR 1101 Grand

SPECIAL WASTE (TONS)	BACKFILL (LOADS)	TOPSOIL (TONS)	CA-6 (TONS)	CA-7 (TONS)	SAND (TONS)	SOD CU.YDS.	CONCRETE	OTHER
253.13	8	108.52	74.55	14.9		347		

Sampling Analysis
Project #19531

0 - 3" Front and Back

Street/Number Address	A		A	
	PPM	No.	PPM	No.
1101 Grand	1540	473		
	595	256		


3 - 6" Front and Back

	B		B	
	PPM	No.	PPM	No.
	653	291		
	562	157		

6 - 12" Front and Back

	C		C	
	PPM	No.	PPM	No.
	416	1060		
	551	183		

Depth Excav. (inch)
12

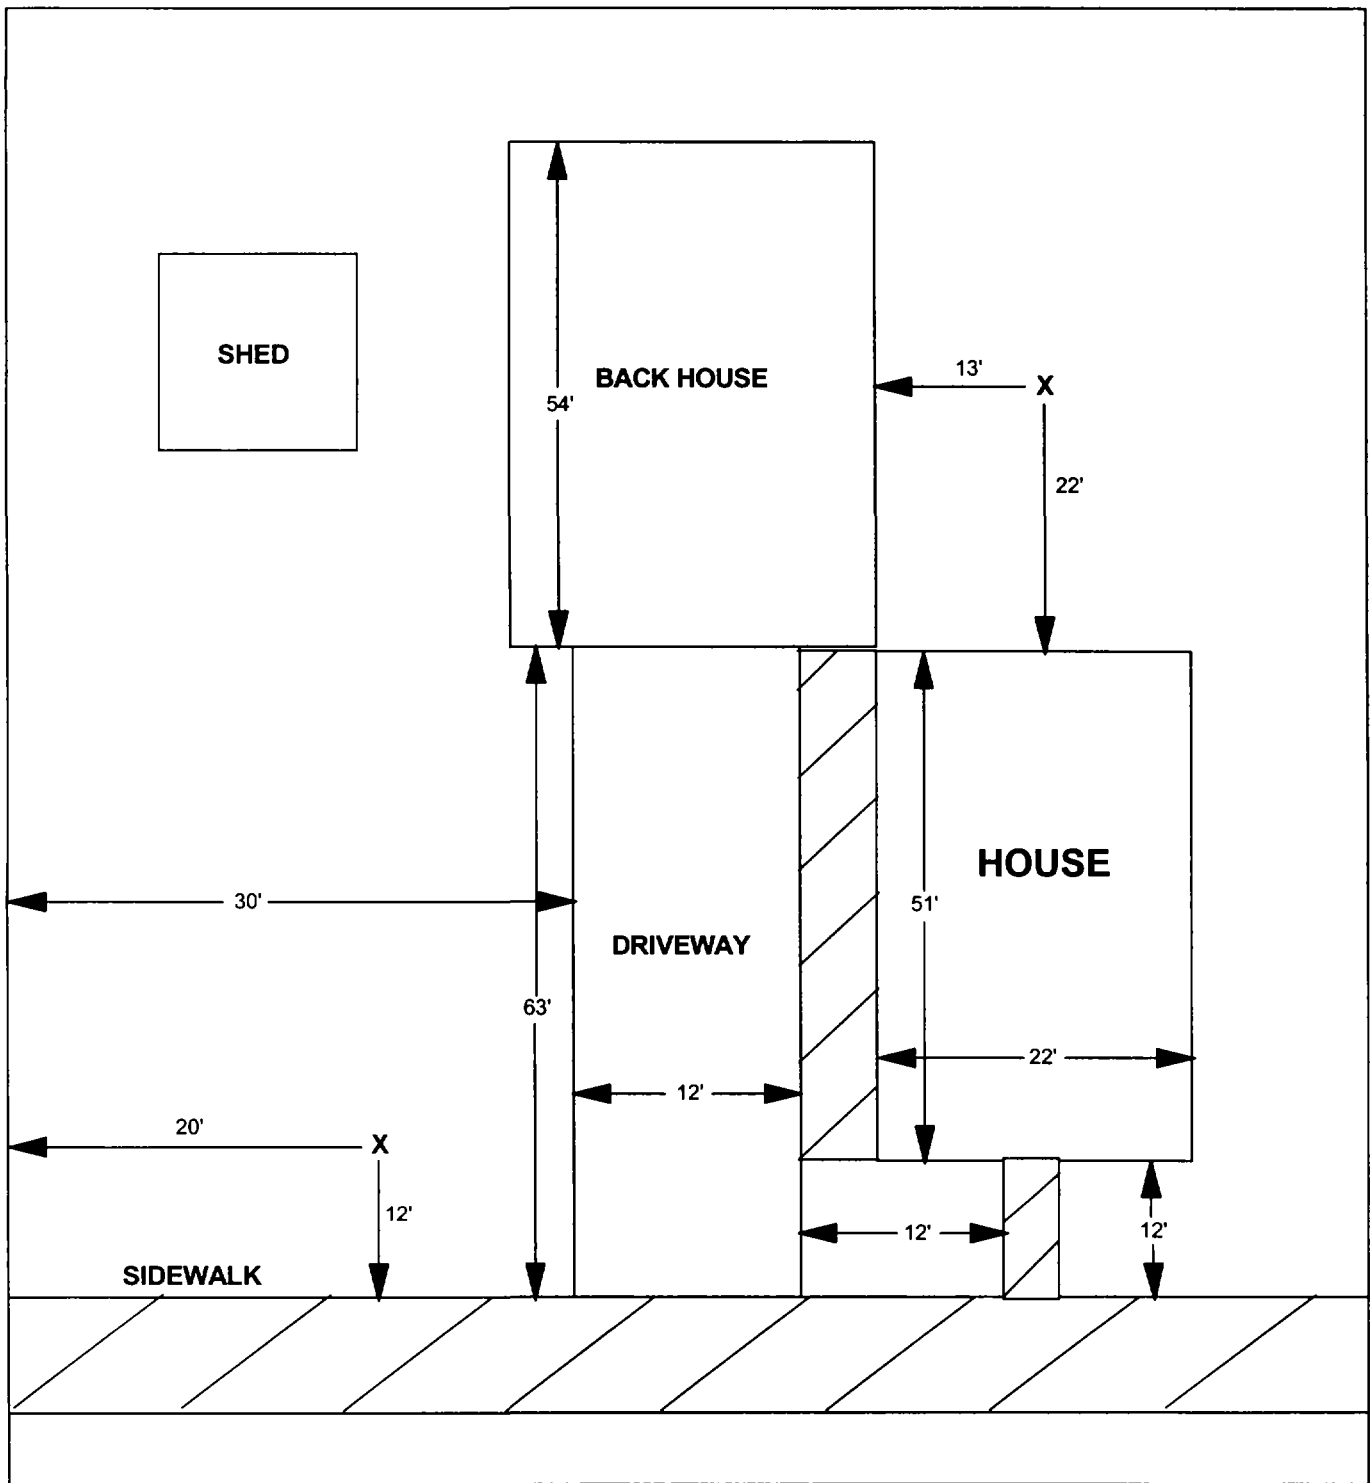

X = SAMPLE POINT

1101 GRAND

**TOTAL
DIMENSIONS
117'X67'**

OHM
Corporation
Findlay, Ohio

Drawn By: **JG** Checked By:

Date: **8/25/98** Approved By:

Scale: **NTS** Drawing No:

1

2

3

1102 Grand

Action Date: 7/29/97

Loadout: 8/2/97

Restoration Begins: 8/2/97

Restoration Completed: 8/16/97

*Stack emission sites were not sampled for verification due to the fact that a pre-determined depth for excavation was given to OHM by USACE.

*An excavation depth of 12 inches was established by USACE prior to work commencing.

*The excavation of special waste yielded a total of 75.55 cubic yards, which was shipped to WMI-Milam for disposal.

*Equipment utilized during excavation:

*TL-26

*TCM

*X331

*Subcontractors:

*WMI-landfill

*B. Garcia-trucking

*Granthum-trucking

*Schneider Turf Farm

OHM CORPORATION
 PROJECT 19531
 GRANITE CITY, IL

QUANTITY SUMMARY FOR 1102 Grand

SPECIAL WASTE (TONS)	BACKFILL (LOADS)	TOPSOIL (TONS)	CA-6 (TONS)	CA-7 (TONS)	SAND (TONS)	SOD CU.YDS.	CONCRETE	OTHER
98.22	5	34.48		13.9		120		

**Sampling Analysis
Project #19531**

0 - 3" Front and Back

Street/Number Address	A		A	
	PPM	PPM	PPM	PPM
	No.	No.	No.	No.

3 - 6" Front and Back

	B		B	
	PPM	PPM	PPM	PPM
	No.	No.	No.	No.

6 - 12" Front and Back

	C		C	
	PPM	PPM	PPM	PPM
	No.	No.	No.	No.

Depth
Excav. (inch)

1102 Grand

270

557


503

531

439

814

12

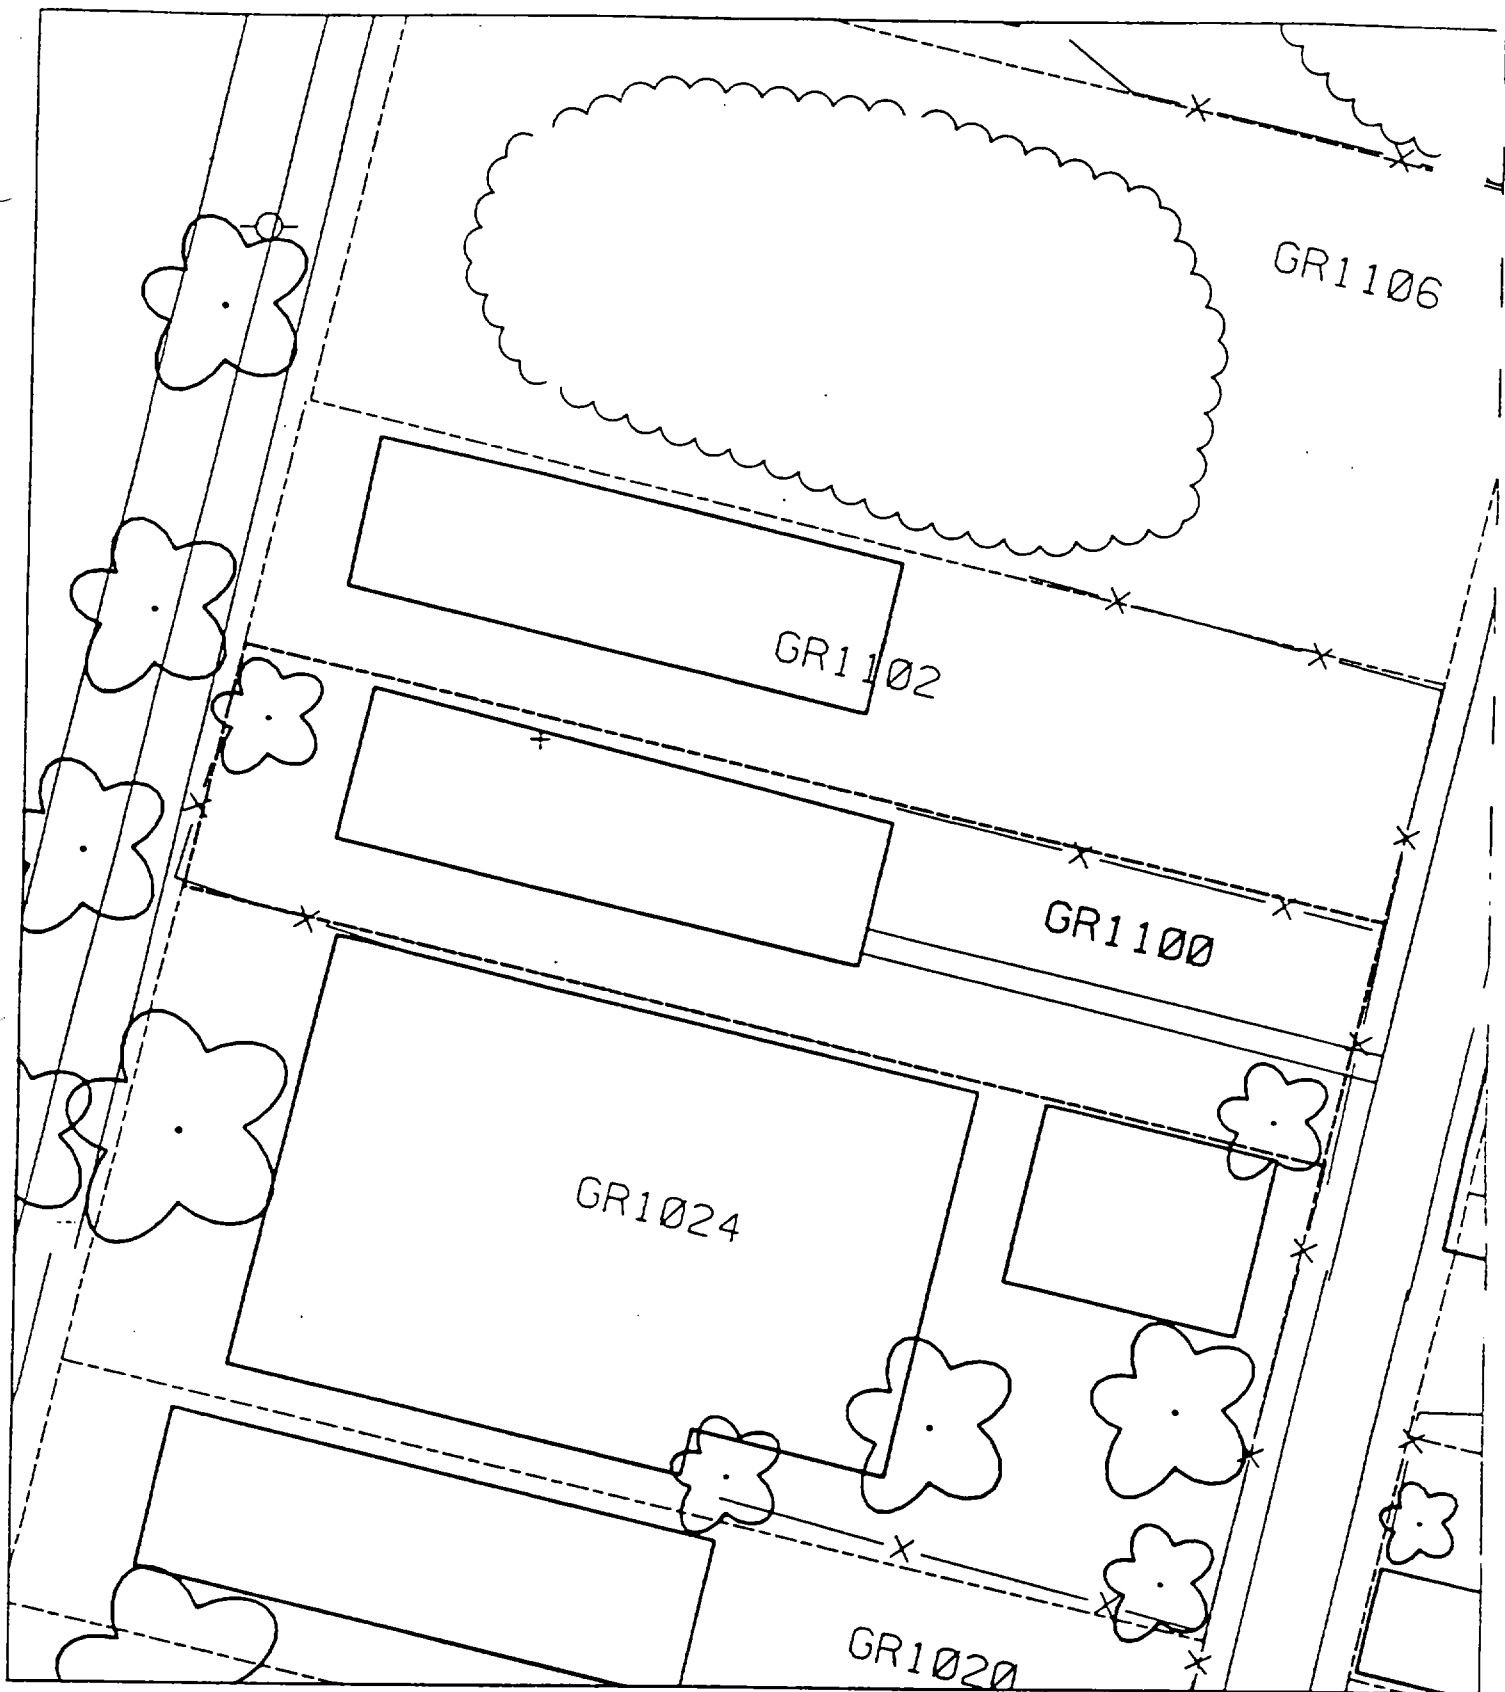

1105 Grand

Action Date: 6/17/97

Loadout: 6/18/97

Restoration Begins: 6/19/97

Restoration Completed: 7/3/97

*Stack emission sites were not sampled for verification due to the fact that a pre-determined depth for excavation was given to OHM by USACE.

*An excavation depth of 6 inches was established by USACE prior to work commencing.

*The excavation of special waste yielded a total of 117.63 cubic yards, which was shipped to WMI-Milam for disposal.

*Equipment utilized during excavation:

*TL-26

*TCM

*X331

*17-KW

*Subcontractors:

*WMI-landfill

*B. Garcia-trucking

*Grantham-trucking

*Schneider-turf farm

**OHM CORPORATION
PROJECT 19531
GRANITE CITY, IL**

QUANTITY SUMMARY FOR

1105 Grand

SPECIAL WASTE (TONS)	BACKFILL (LOADS)	TOPSOIL (TONS)	CA-6 (TONS)	CA-7 (TONS)	SAND (TONS)	SOD CU.YDS.	CONCRETE	OTHER
152.93	8	48.28	43.95	14.45		317.5		

Sampling Analysis
Project #19531

0 - 3" Front and Back

Street/Number Address	A		A	
	PPM	No.	PPM	No.
	PPM	No.	PPM	No.

1105 Grand 315 **543**
 358 326
 374 **788**

3 - 6" Front and Back

B		B	
PPM	No.	PPM	No.
PPM	No.	PPM	No.

247 **563**
390 316
282 **640**


6 - 12" Front and Back

C		C	
PPM	No.	PPM	No.
PPM	No.	PPM	No.

218 307

Depth Excav. (inch)

6

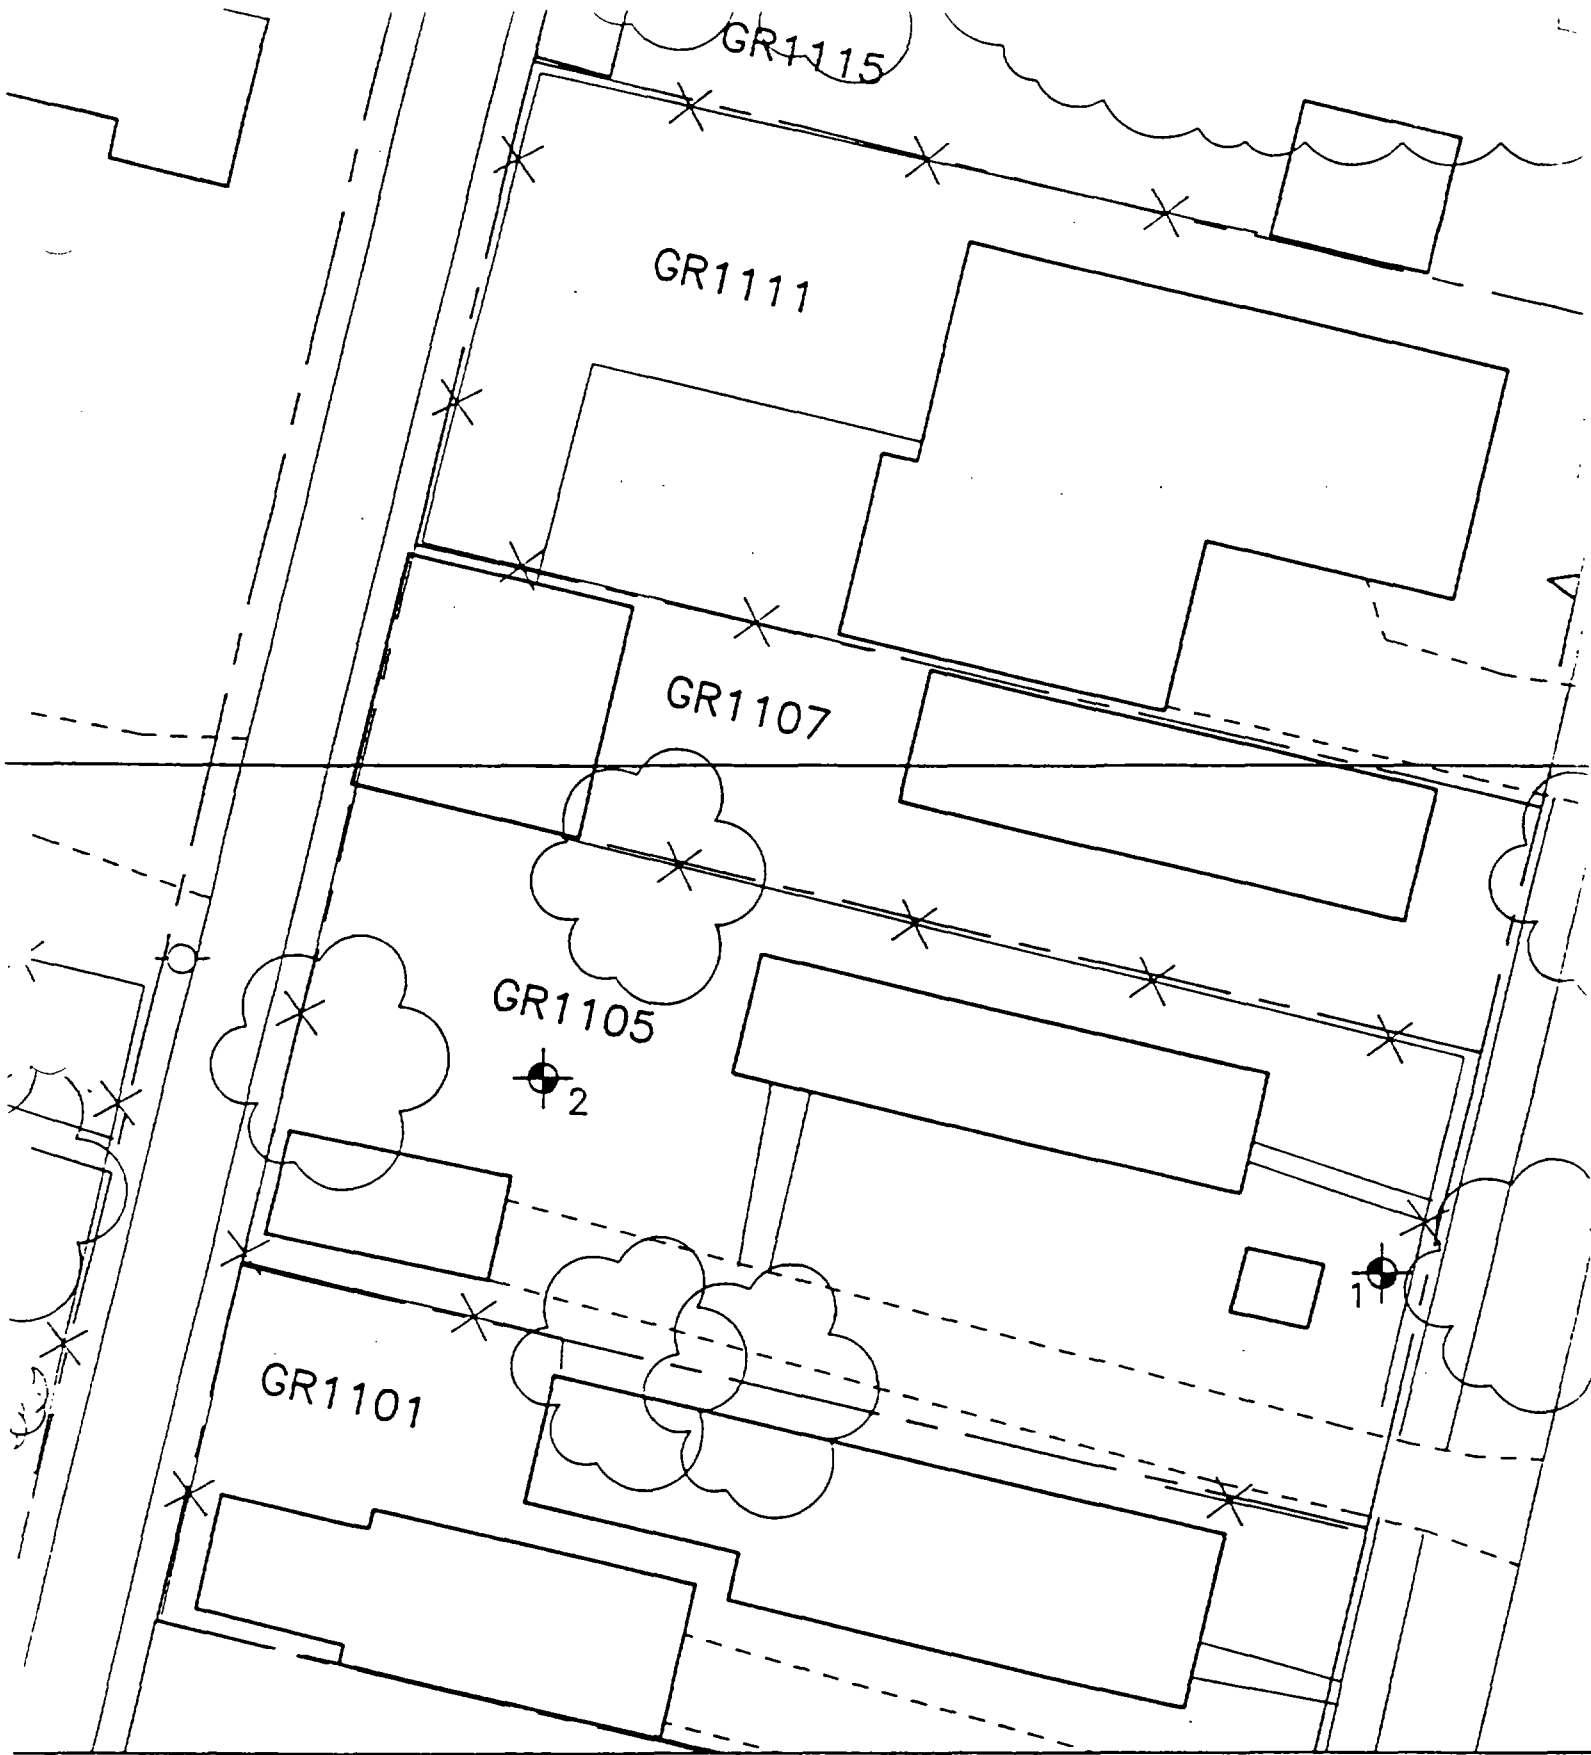

1107 Grand

Action Date: 6/20/97

Loadout: 6/23/97

Restoration Begins: 6/23/97

Restoration Completed: 7/10/97

*Stack emission sites were not sampled for verification due to the fact that a pre-determined depth for excavation was given to OHM by USACE.

*An excavation depth of 12 inches was established by USACE prior to work commencing.

*The excavation of special waste yielded a total of 47.32 cubic yards, which was shipped to WMI-Milam for disposal.

*Equipment utilized during excavation:

*TL-26

*TCM

*X331

*17-KW

*Subcontractors:

*WMI-landfill

*B. Garcia-trucking

*Grantham-trucking

*Schneider-turf farm

OHM CORPORATION
PROJECT 1953I
GRANITE CITY, IL

QUANTITY SUMMARY FOR

1107 Grand

SPECIAL WASTE (TONS)	BACKFILL (LOADS)	TOPSOIL (TONS)	CA-6 (TONS)	CA-7 (TONS)	SAND (TONS)	SOD CU.YDS.	CONCRETE	OTHER
61.52	4	15.33		14.95		159		

Sampling Analysis
Project #19531

0 - 3" Front and Back

Street/Number Address	A		A	
	PPM	No.	PPM	No.
1107 Grand	347	690		
	301	715		


3 - 6" Front and Back

	B		B	
	PPM	No.	PPM	No.
	245	1584		
	501	725		

6 - 12" Front and Back

	C		C	
	PPM	No.	PPM	No.
	97	3664		
	92	1781		

	Depth	
	Excav.	(inch)
		12

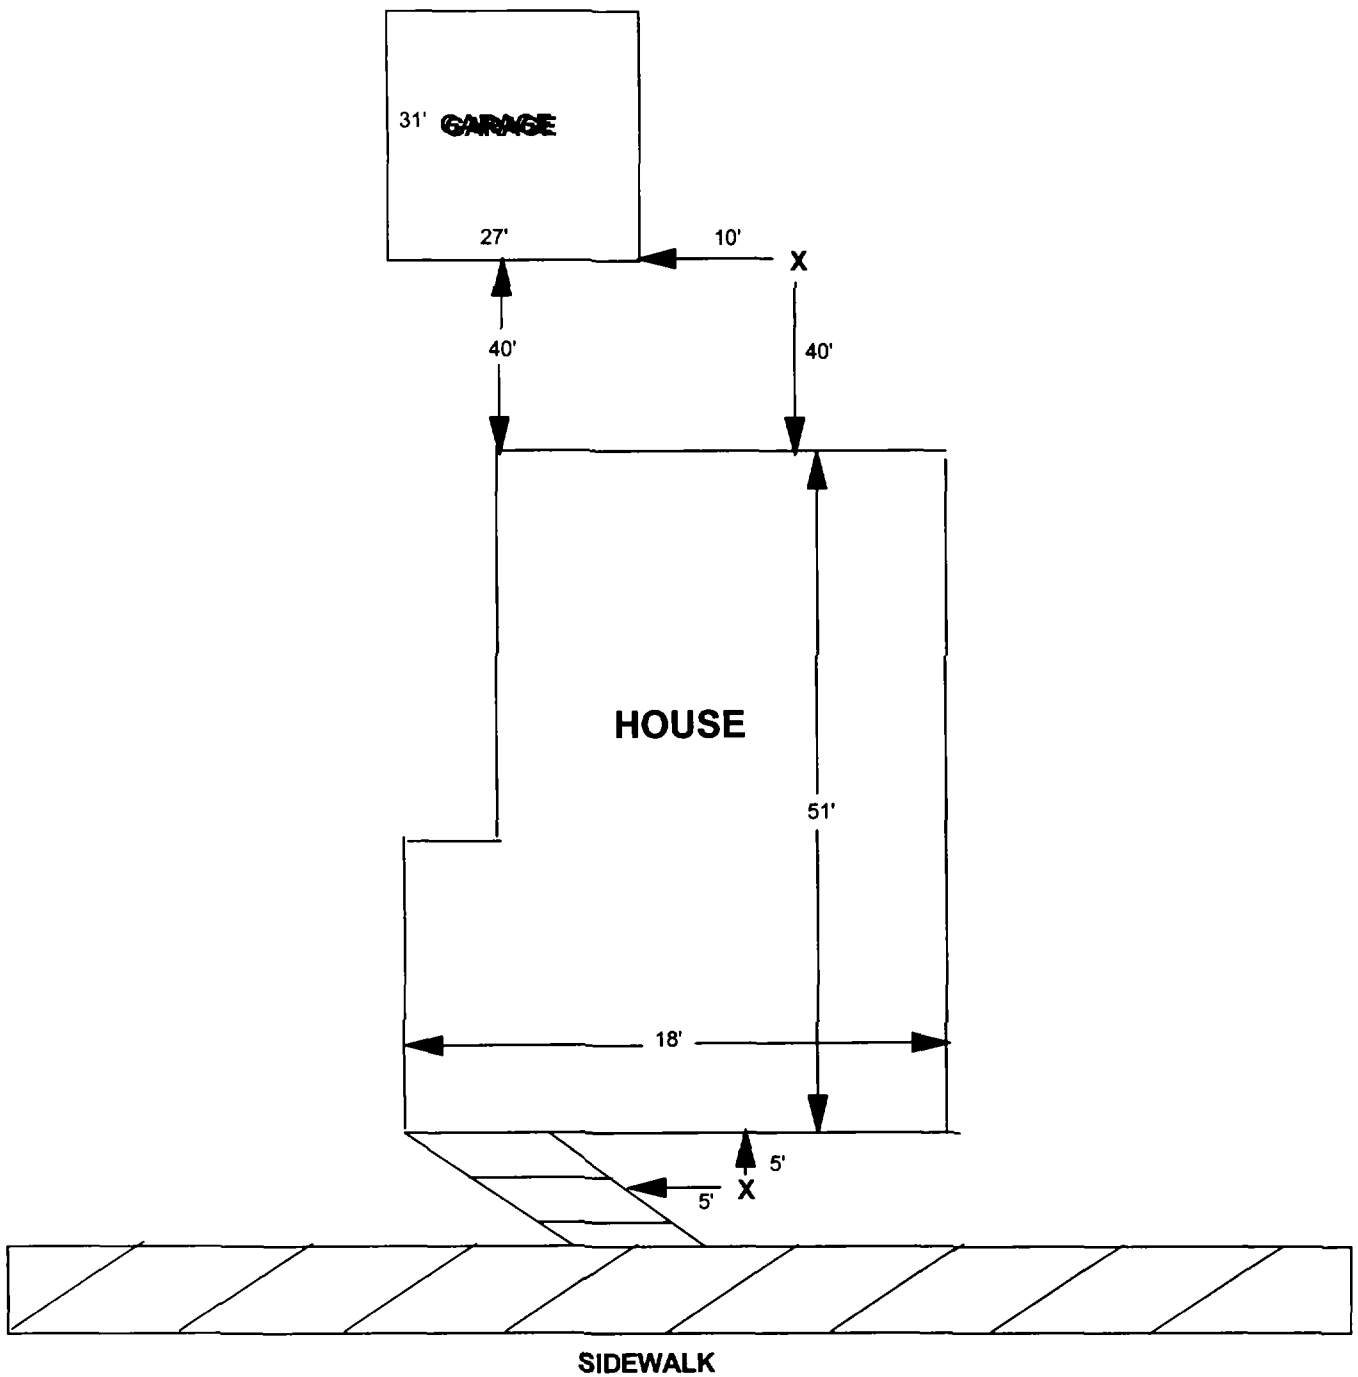

X = SAMPLE POINT

1107 GRAND

**TOTAL
DIMENSIONS
113'X27'**

OHM 
Corporation
Findlay, Ohio

Drawn By: **JG** Checked By:

Date: **8/18/98** Approved By:

Scale: **NTS** Drawing No:

1108 Grand

Action Date: 8/5/97

— Loadout: 8/6/97

Restoration Begins: 8/6/97

Restoration Completed: 8/20/97

*Stack emission sites were not sampled for verification due to the fact that a pre-determined depth for excavation was given to OHM by USACE.

*An excavation depth of 12 inches was established by USACE prior to work commencing.

*The excavation of special waste yielded a total of 92.16 cubic yards, which was shipped to WMI-Milam for disposal.

*Equipment utilized during excavation:

*TL-26

*TCM

*X331

*17-KW

*Subcontractors:

*WMI-landfill

*B. Garcia-trucking

*Granthum-trucking

*Emerald Turf Farm

OHM CORPORATION
PROJECT 19531
GRANITE CITY, IL

QUANTITY SUMMARY FOR 1108 Grand

SPECIAL WASTE (TONS)	BACKFILL (LOADS)	TOPSOIL (TONS)	CA-6 (TONS)	CA-7 (TONS)	SAND (TONS)	SOD CU.YDS.	CONCRETE	OTHER
119.82	6	32.92	11.95	14.65		300		

Sampling Analysis
Project #19531

0 - 3" Front and Back

Street/Number Address	A		A	
	PPM	PPM	PPM	PPM
	No.	No.	No.	No.

3 - 6" Front and Back

	B		B	
	PPM	PPM	PPM	PPM
	No.	No.	No.	No.

6 - 12" Front and Back

	C		C	
	PPM	PPM	PPM	PPM
	No.	No.	No.	No.

Depth	
Excav.	
(inch)	

1108 Grand

195

502


929

112

759

944

12

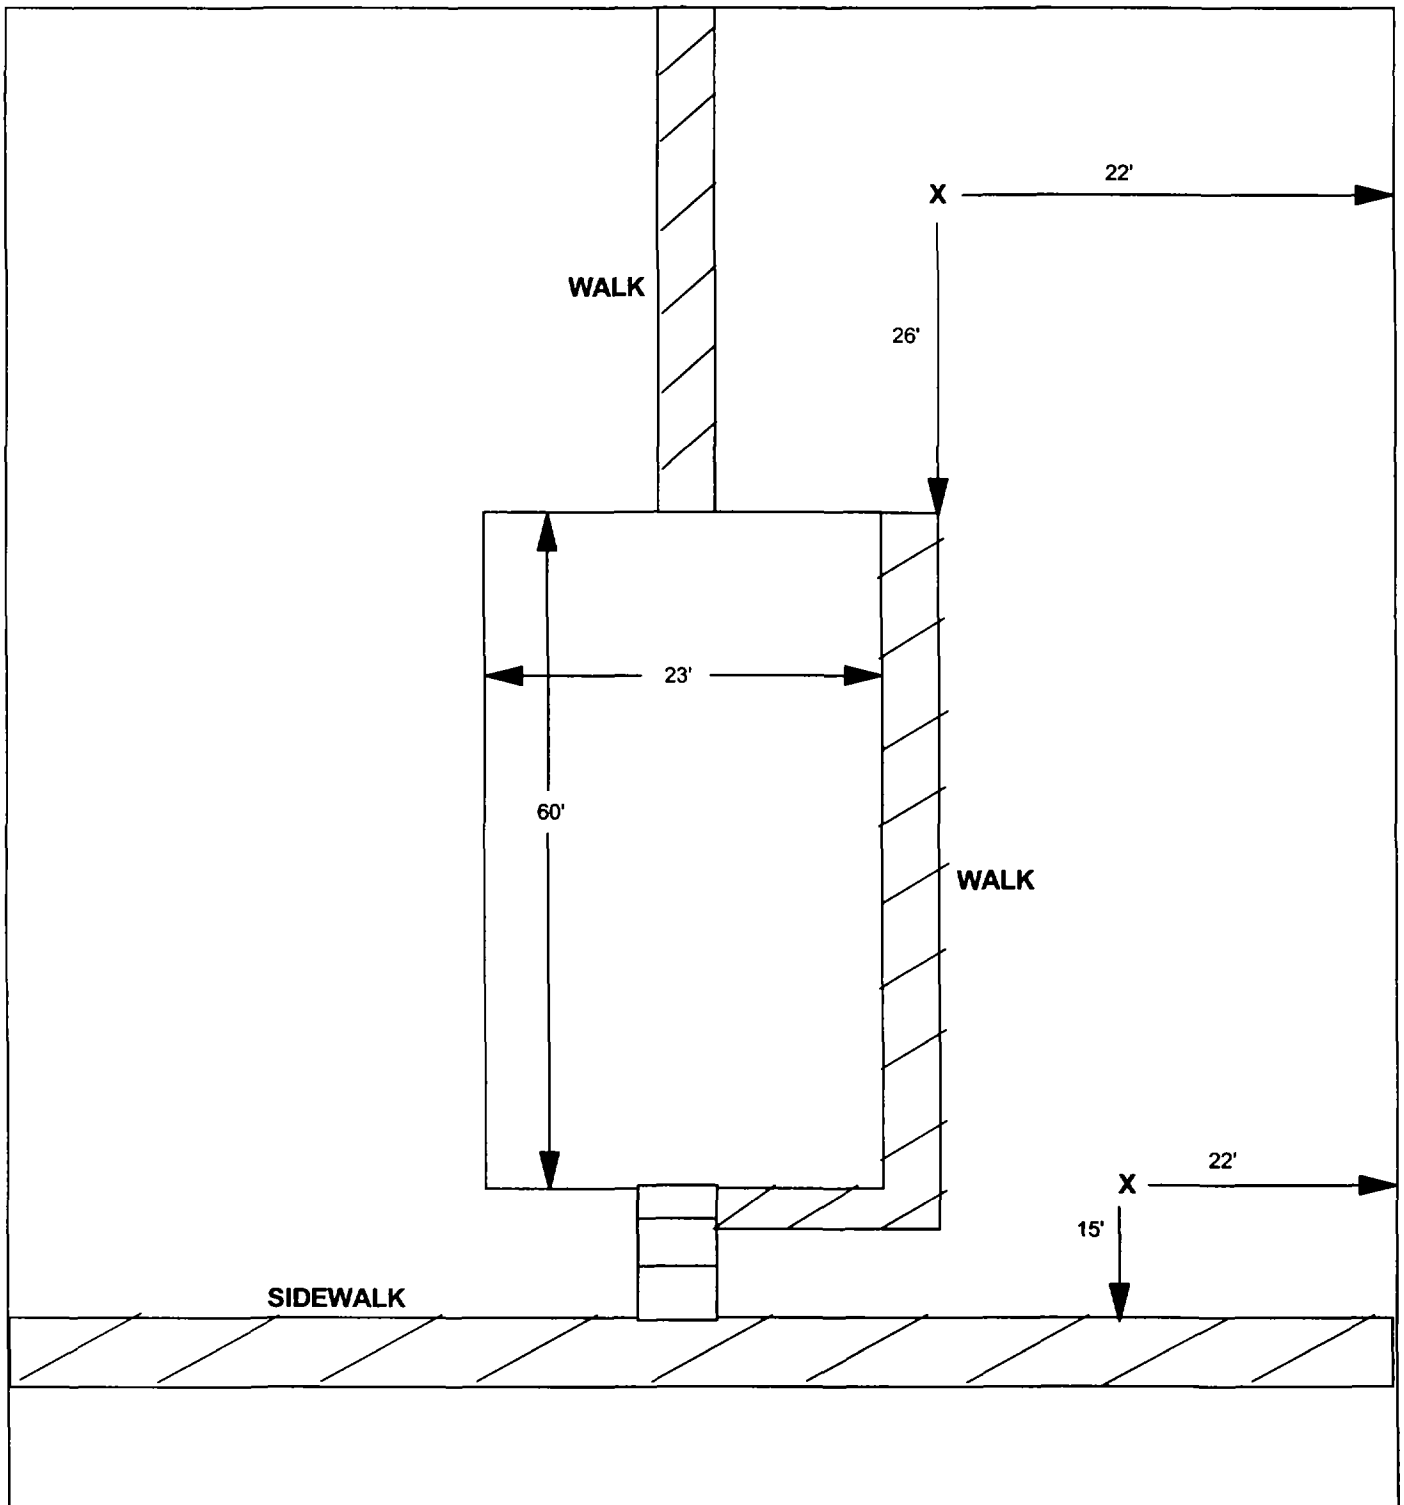

X = SAMPLE POINT

1108 GRAND

**TOTAL
DIMENSIONS
127'X79'**

OHM 
Corporation
Findlay, Ohio

Drawn By: **JG** Checked By:

Date: **8/18/98** Approved By:

Scale: **NTS** Drawing No:

1115 Grand

Action Date: 5/23/97

Loadout: 5/27/97

Restoration Begins: 5/28/97

Restoration Completed: 6/25/97

*Stack emission sites were not sampled for verification due to the fact that a pre-determined depth for excavation was given to OHM by USACE.

*An excavation depth of 12 inches was established by USACE prior to work commencing.

*The excavation of special waste yielded a total of 96.50 cubic yards, which was shipped to WMI-Milam for disposal.

*Equipment utilized during excavation:

*TL-26

*TCM

*X331

*17-KW

*Subcontractors:

*WMI-landfill

*B. Garcia-trucking

*Granthum-trucking

*Schneider Turf Farm

OHM CORPORATION
 PROJECT 19531
 GRANITE CITY, IL

QUANTITY SUMMARY FOR 1115 Grand

SPECIAL WASTE (TONS)	BACKFILL (LOADS)	TOPSOIL (TONS)	CA-6 (TONS)	CA-7 (TONS)	SAND (TONS)	SOD CU.YDS.	CONCRETE	OTHER
125.45	9	136				635		

**Sampling Analysis
Project #19531**

Street/Number Address	0 - 3" Front and Back				3 - 6" Front and Back				6 - 12" Front and Back				Depth Excav. (inch)
	A	A	A	A	B	B	B	B	C	C	C	C	
	PPM	PPM	PPM	PPM	PPM	PPM	PPM	PPM	PPM	PPM	PPM	PPM	
	No.	No.	No.	No.	No.	No.	No.	No.	No.	No.	No.	No.	
1115 Grand	389	681			326	792			418	758			12


202004

GR1115

GR1111

GR1107

GR0907

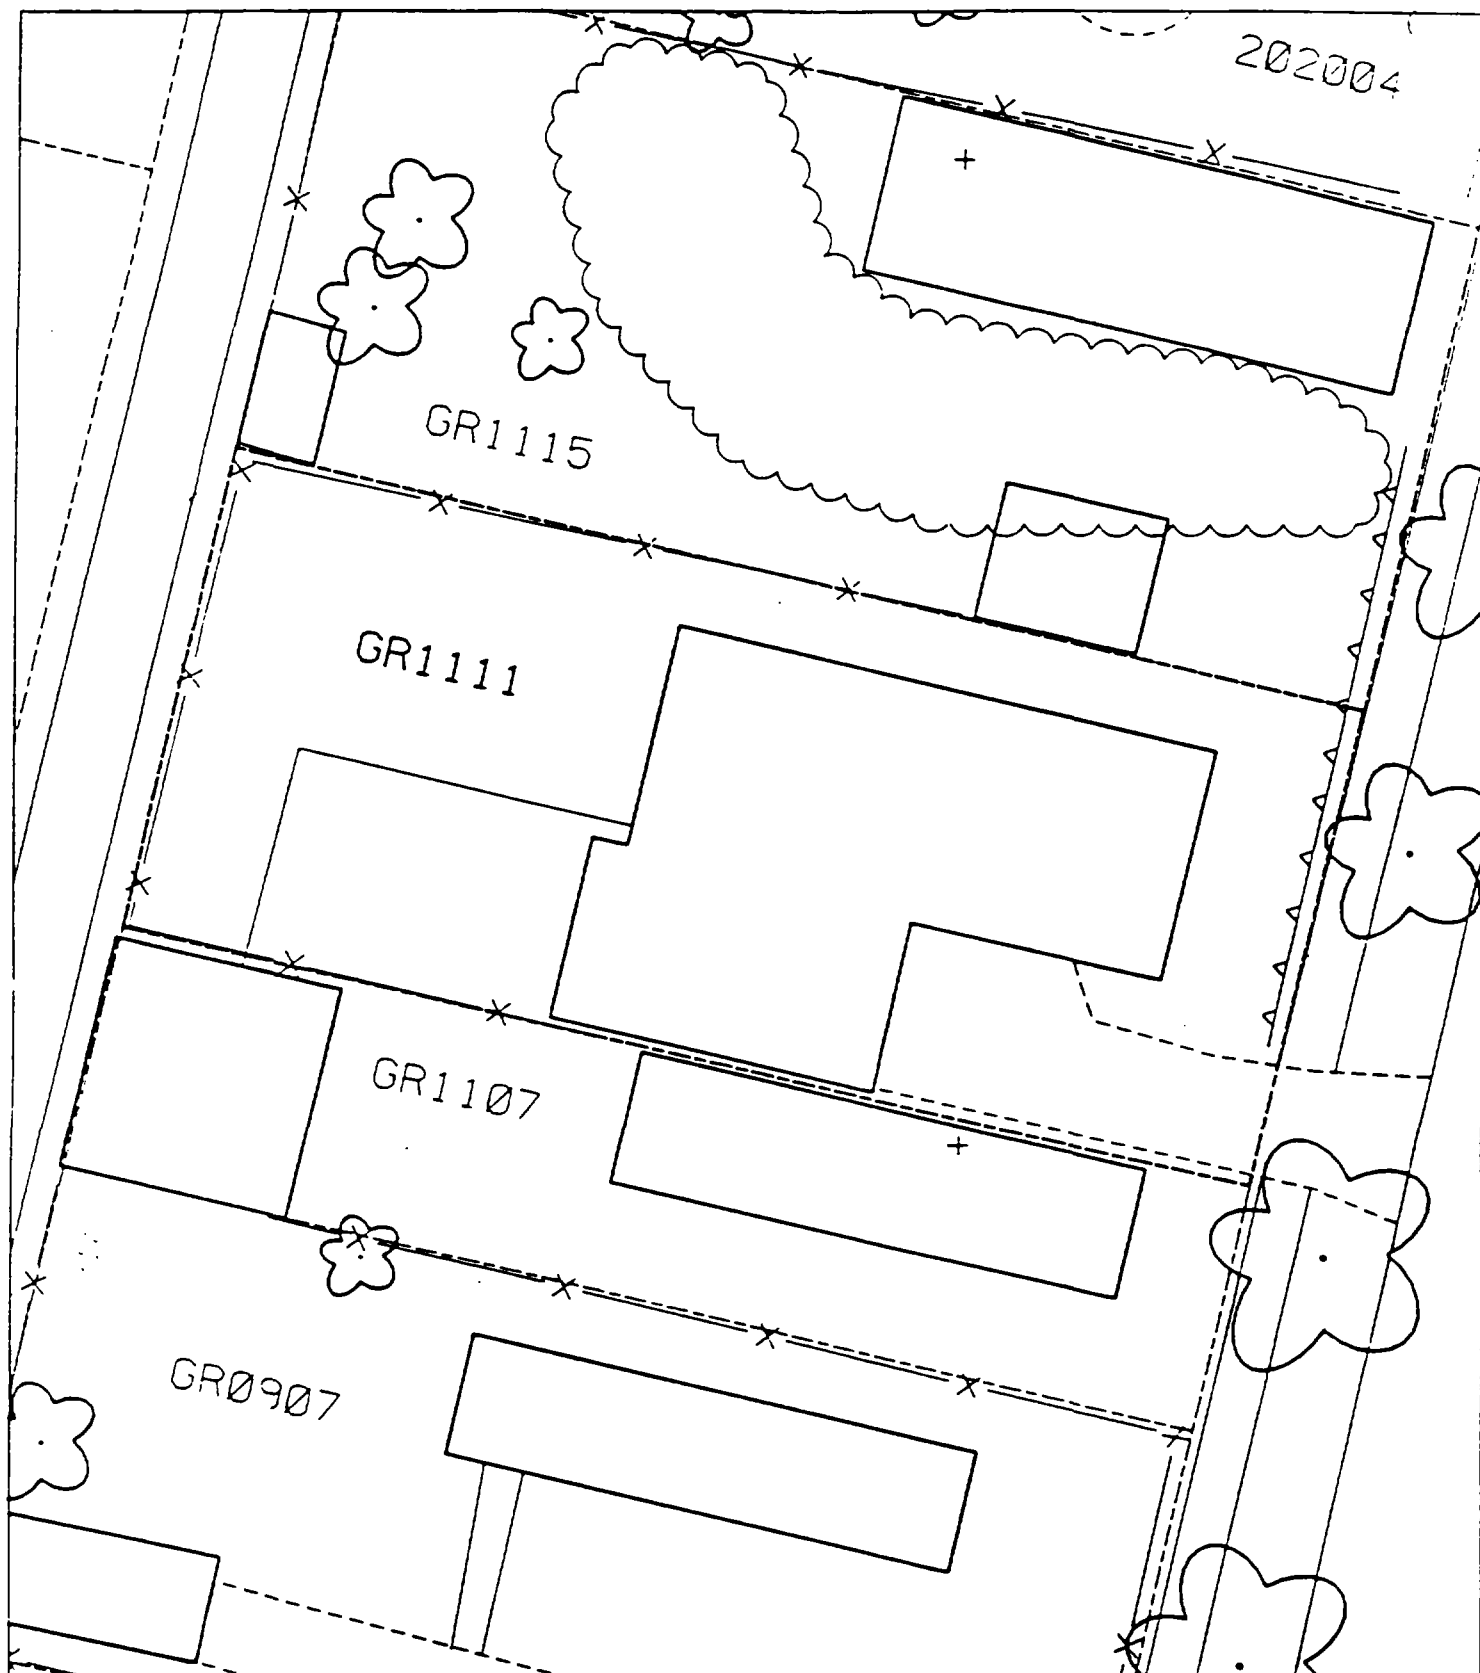

1

2

3

1125 Grand

Action Date: 5/21/97

Loadout: 5/22/97

Restoration Begins: 5/22/97

Restoration Completed: 6/7/97

*Stack emission sites were not sampled for verification due to the fact that a pre-determined depth for excavation was given to OHM by USACE.

*An excavation depth of 12 inches was established by USACE prior to work commencing.

*The excavation of special waste yielded a total of 48.63 cubic yards, which was shipped to WMI-Milam for disposal.

*Equipment utilized during excavation:

- *TL-26

- *X331

- *17-KW

*Subcontractors:

- *WMI-landfill

- *B. Garcia-trucking

- *Grantham-trucking

- *Schneider-turf farm

**OHM CORPORATION
PROJECT 19531
GRANITE CITY, IL**

QUANTITY SUMMARY FOR

1125 Grand

SPECIAL WASTE (TONS)	BACKFILL (LOADS)	TOPSOIL (TONS)	CA-6 (TONS)	CA-7 (TONS)	SAND (TONS)	SOD CU.YDS.	CONCRETE	OTHER
63.22	6	32.55				254		

Sampling Analysis
Project #19531

0 - 3" Front and Back				
Street/Number Address	A	A	A	A
	PPM	PPM	PPM	PPM
	No.	No.	No.	No.

1125 Grand 1360 1280

3 - 6" Front and Back				
B	B	B	B	B
	PPM	PPM	PPM	PPM
	No.	No.	No.	No.

735 117

6 - 12" Front and Back				
C	C	C	C	C
	PPM	PPM	PPM	PPM
	No.	No.	No.	No.

549 827

Depth Excav. (inch)

12

STREET


N 73625

GR1125

GR1123

GR1121

P

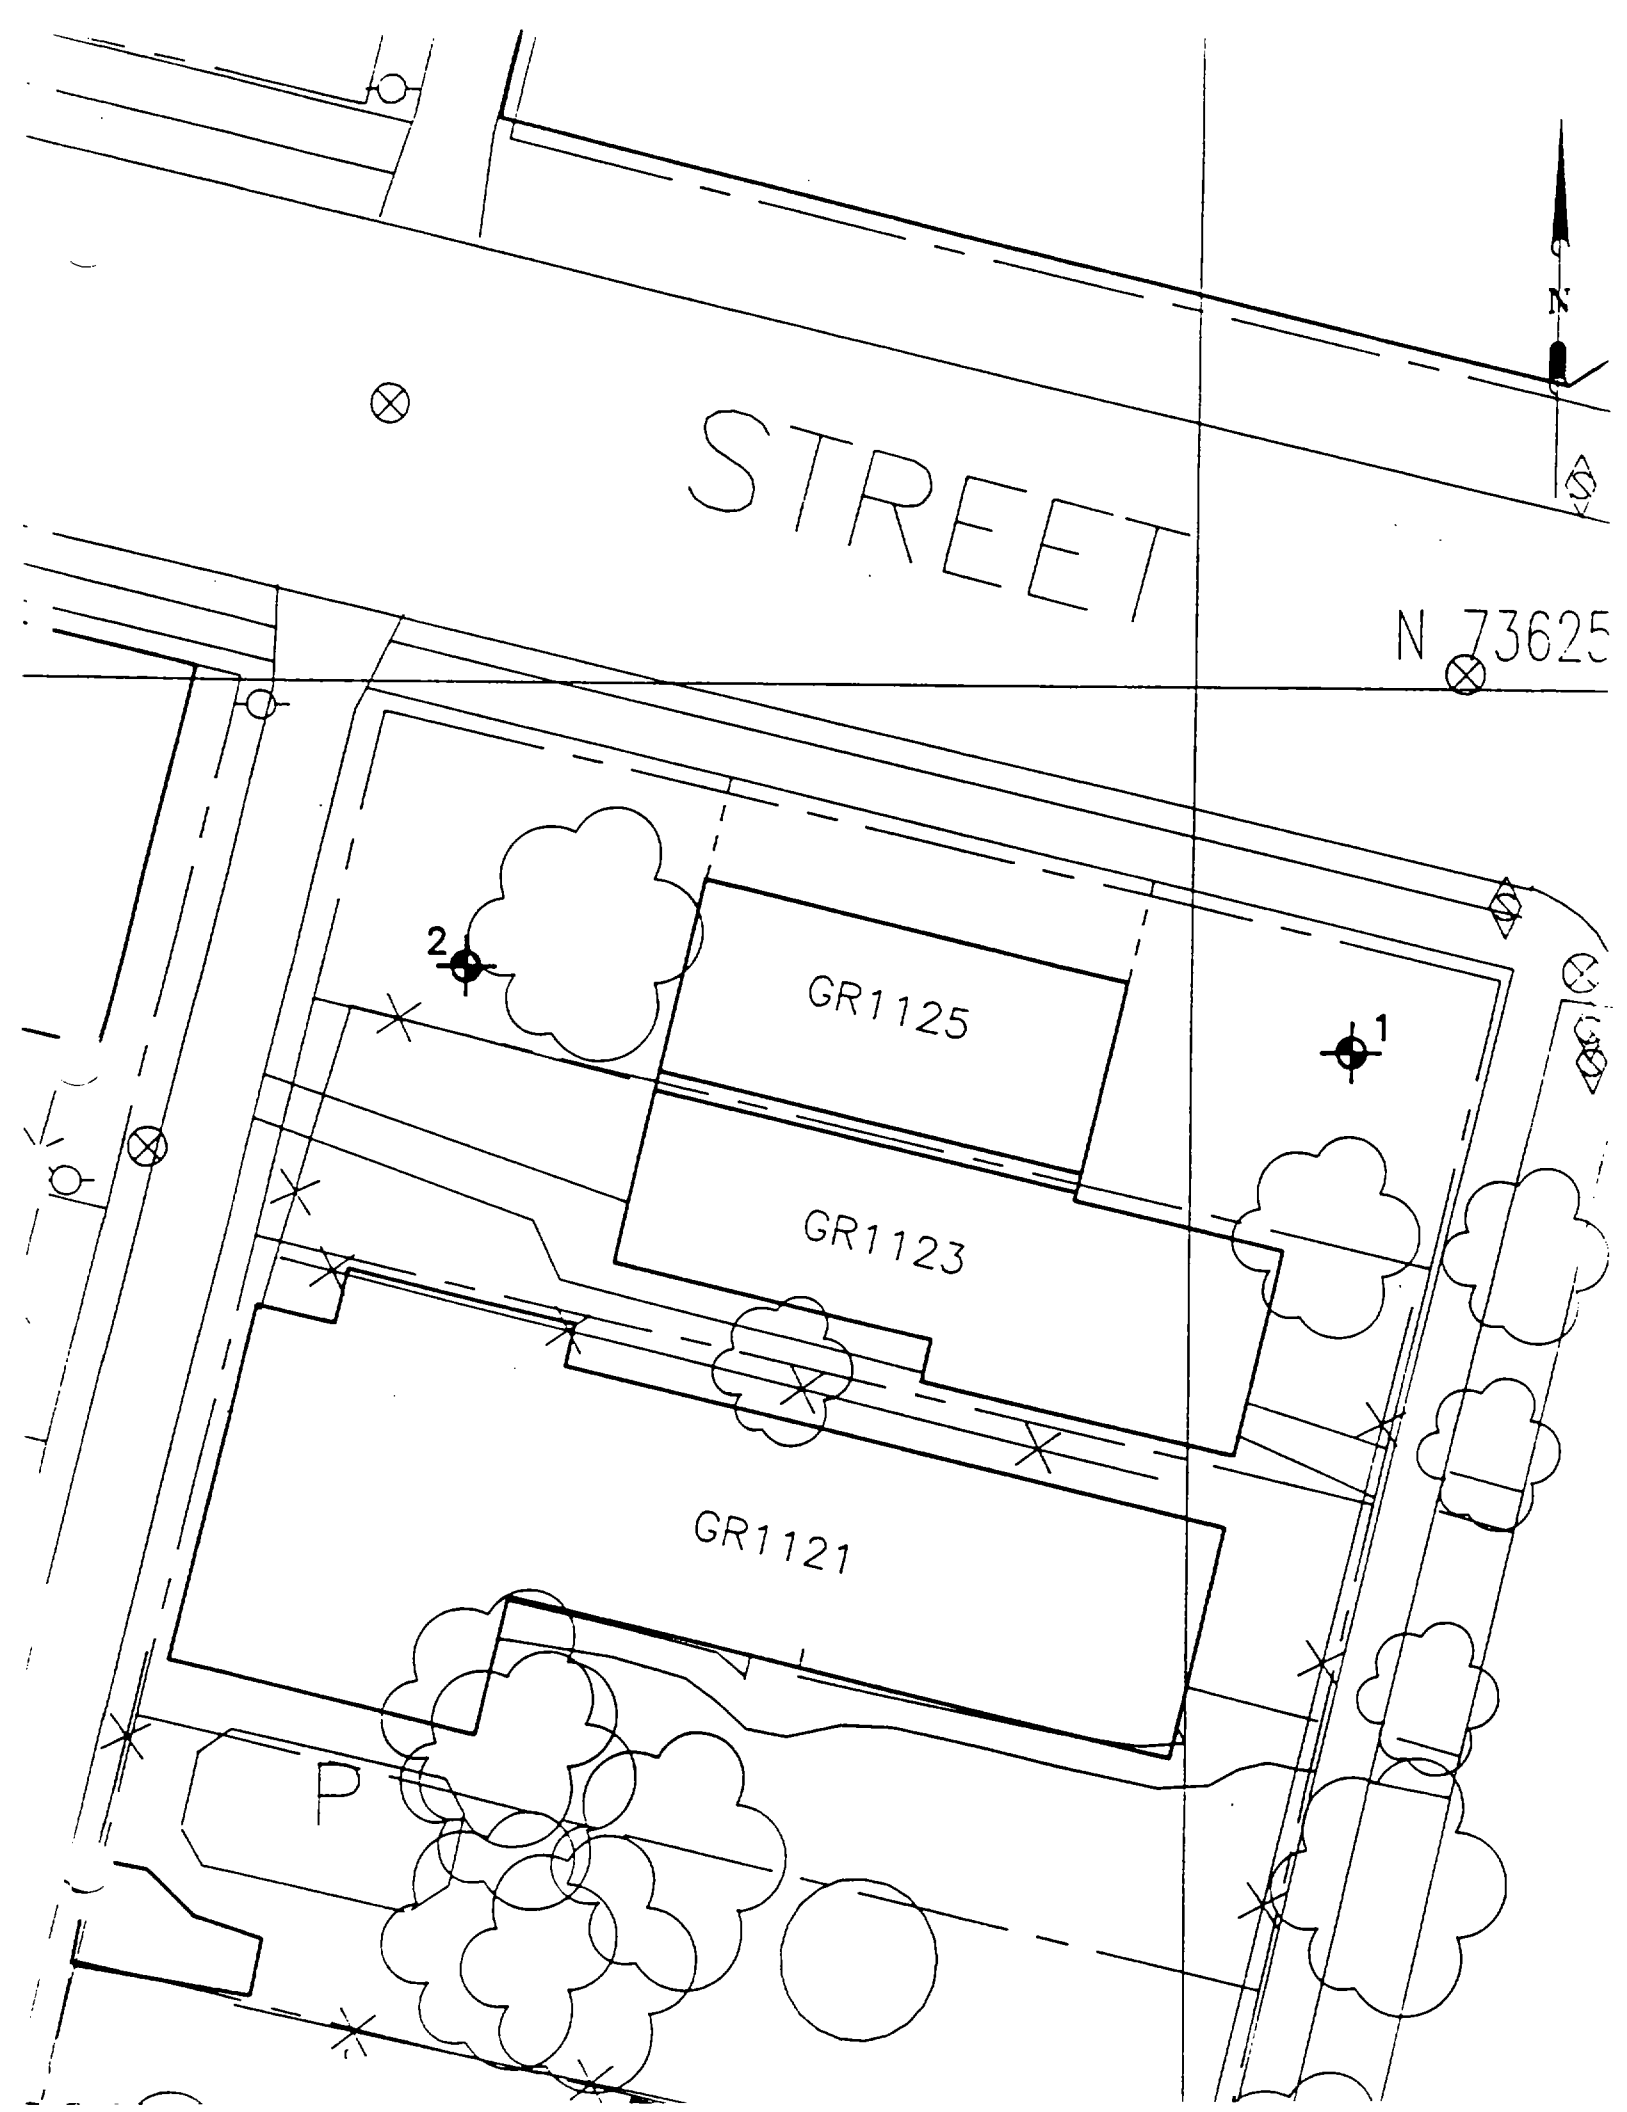

2

3

4

1222 Grand

Action Date: 5/7/97

Loadout: 5/8/97

Restoration Begins: 5/8/97

Restoration Completed: 5/21/97

*Stack emission sites were not sampled for verification due to the fact that a pre-determined depth for excavation was given to OHM by USACE.

*An excavation depth of 3 inches was established by USACE prior to work commencing.

*The excavation of special waste yielded a total of 35.73 cubic yards, which was shipped to WMI-Milam for disposal.

*Equipment utilized during excavation:

*TL-26

*TCM

*X331

*17-KW

*Subcontractors:

*WMI-landfill

*B. Garcia-trucking

*Granthum-trucking

*Schneider Turf Farm

OHM CORPORATION
PROJECT 19531
GRANITE CITY, IL

QUANTITY SUMMARY FOR 1222 Grand

SPECIAL WASTE (TONS)	BACKFILL (LOADS)	TOPSOIL (TONS)	CA-6 (TONS)	CA-7 (TONS)	SAND (TONS)	SOD CU.YDS.	CONCRETE	OTHER
46.45		52		13.5		441		

Sampling Analysis
Project #19531

0 - 3" Front and Back

Street/Number Address	A		A	
	PPM	No.	PPM	No.
	PPM	No.	PPM	No.

1222 Grand 562 205 495
452 67

3 - 6" Front and Back

	B		B	
	PPM	No.	PPM	No.
	PPM	No.	PPM	No.

505 192 241
310 56
263 258


6 - 12" Front and Back

	C		C	
	PPM	No.	PPM	No.
	PPM	No.	PPM	No.

306 145

Depth
Excav.
(inch)

3

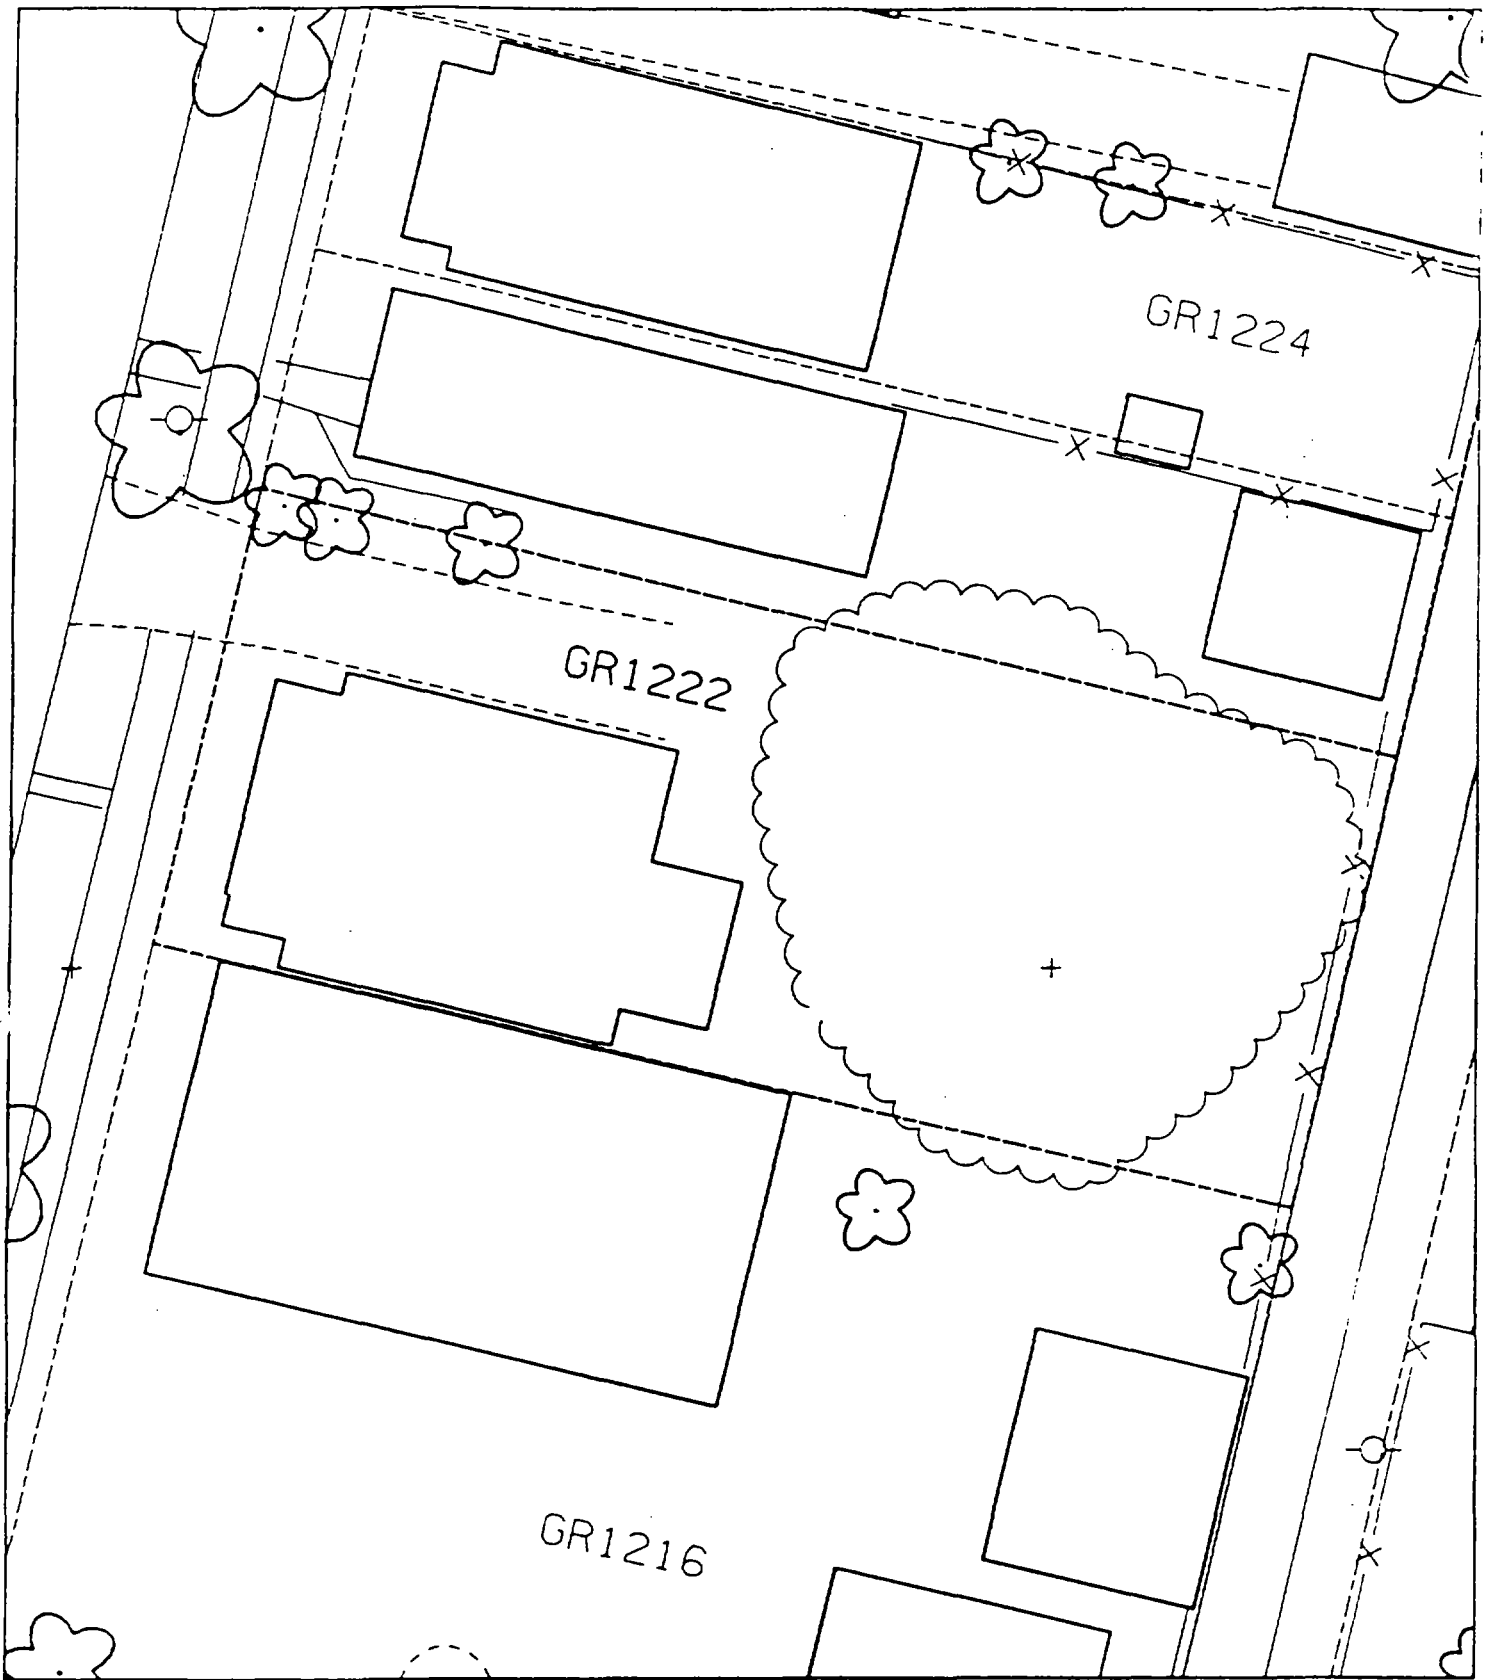

—

—

—

1224 Grand

Action Date: 5/8/97

Loadout: 5/8/97

Restoration Begins: 5/8/97

Restoration Completed: 5/21/97

*Stack emission sites were not sampled for verification due to the fact that a pre-determined depth for excavation was given to OHM by USACE.

*An excavation depth of 6 inches was established by USACE prior to work commencing.

*The excavation of special waste yielded a total of 26.59 cubic yards, which was shipped to WMI-Milam for disposal.

*Equipment utilized during excavation:

*TL-26

*TCM

*X331

*17-KW

*Subcontractors:

*WMI-landfill

*B. Garcia-trucking

*Granthum-trucking

*Schneider Turf Farm

OHM CORPORATION
PROJECT 19531
GRANITE CITY, IL

QUANTITY SUMMARY FOR 1224 Grand

SPECIAL WASTE (TONS)	BACKFILL (LOADS)	TOPSOIL (TONS)	CA-6 (TONS)	CA-7 (TONS)	SAND (TONS)	SOD CU.YDS.	CONCRETE	OTHER
34.57	1	30.73		14.25		127		

Sampling Analysis
Project #19531

Street/Number Address	0 - 3" Front and Back			
	A		A	
	PPM	No.	PPM	No.

1224 Grand 380 990
120 480

	3 - 6" Front and Back			
	B		B	
	PPM	No.	PPM	No.


340 790
270 550

	6 - 12" Front and Back			
	C		C	
	PPM	No.	PPM	No.

180 1100
55 370

Depth	
Excav.	
(inch)	

6

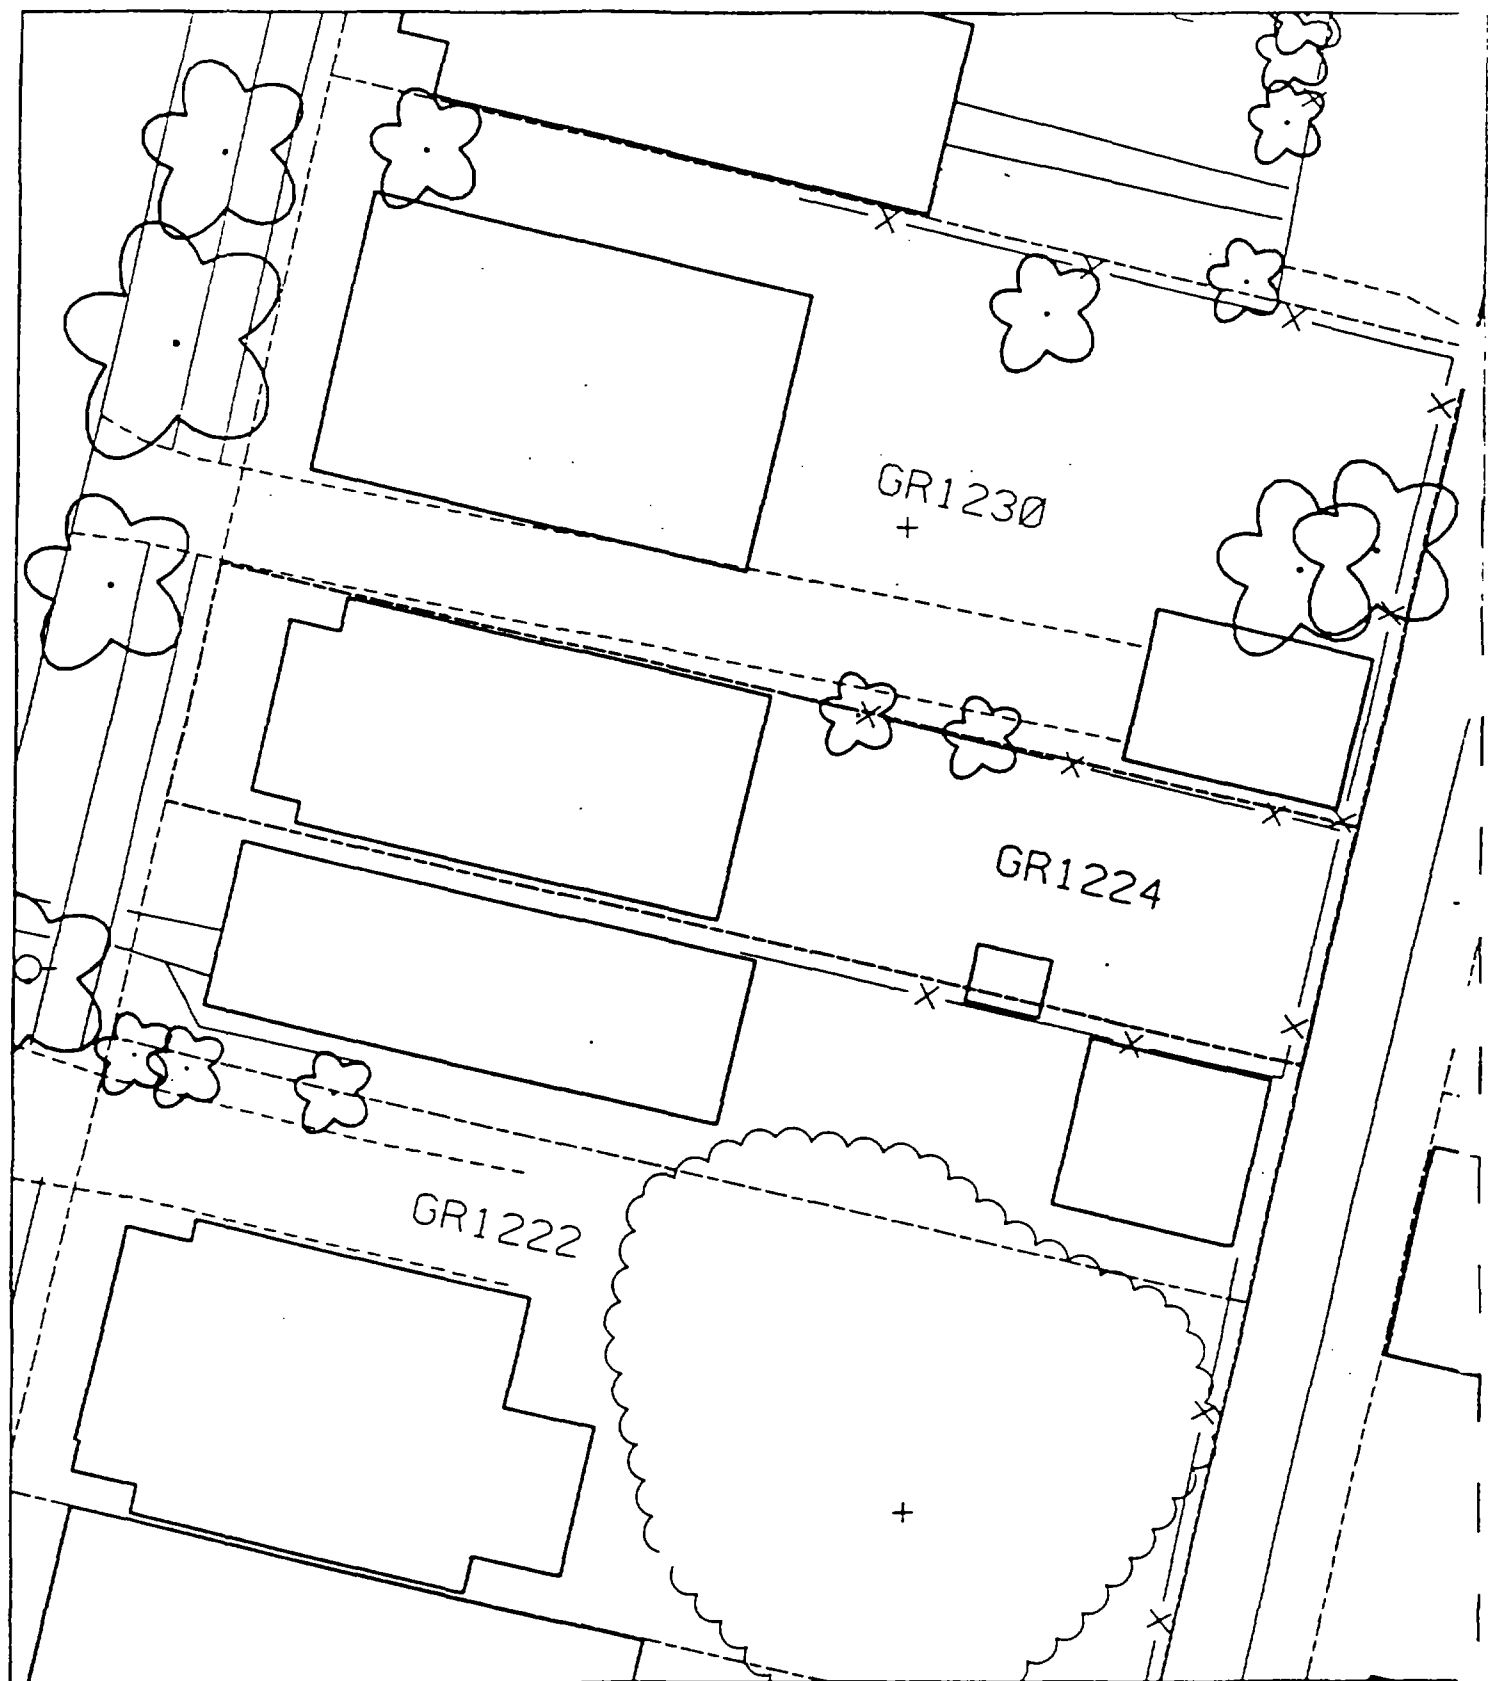

1233 Grand

Action Date: 4/9/97

Loadout: 4/16/97

Restoration Begins: 4/16/97

Restoration Completed: 5/7/97

*Stack emission sites were not sampled for verification due to the fact that a pre-determined depth for excavation was given to OHM by USACE.

*An excavation depth of 12 inches was established by USACE prior to work commencing.

*The excavation of special waste yielded a total of 335.79 cubic yards, which was shipped to WMI-Milam for disposal.

*Equipment utilized during excavation:

*TL-26

*TCM

*X331

*17-KW

*Subcontractors:

*WMI-landfill

*B. Garcia-trucking

*Granthum-trucking

*Schneider Turf Farm

OHM CORPORATION
 PROJECT 19531
 GRANITE CITY, IL

QUANTITY SUMMARY FOR 1233 Grand

SPECIAL WASTE (TONS)	BACKFILL (LOADS)	TOPSOIL (TONS)	CA-6 (TONS)	CA-7 (TONS)	SAND (TONS)	SOD CU.YDS.	CONCRETE	OTHER
436.53	29	237.94		43.4		1323		

Sampling Analysis
Project #19531

0 - 3" Front and Back

Street/Number Address	A		A	
	PPM	No.	PPM	No.
1233 Grand	655		824	

3 - 6" Front and Back

	B		B	
	PPM	No.	PPM	No.
	378		482	

6 - 12" Front and Back

	C		C	
	PPM	No.	PPM	No.
	12339		815	

Depth Excav. (inch)
12

GR1233

N 736750

GR1231

Action Date: 4/24/97

Loadout: 4/25/97

Restoration Begins: 4/26/97

Restoration Completed: 5/15/97

*Stack emission sites were not sampled for verification due to the fact that a pre-determined depth for excavation was given to OHM by USACE.

*An excavation depth of 12 inches was established by USACE prior to work commencing.

*The excavation of special waste yielded a total of 204.96 cubic yards, which was shipped to WMI-Milam for disposal.

*Equipment utilized during excavation:

*TL-26

*TCM

*X331

*17-KW

*Subcontractors:

*WMI-landfill

*B. Garcia-trucking

*Granthum-trucking

*Schneider Turf Farm

OHM CORPORATION
PROJECT 19531
GRANITE CITY, IL

QUANTITY SUMMARY FOR 1240/42 Grand

SPECIAL WASTE (TONS)	BACKFILL (LOADS)	TOPSOIL (TONS)	CA-6 (TONS)	CA-7 (TONS)	SAND (TONS)	SOD CU.YDS.	CONCRETE	OTHER
266.46	16	352.88		28.45		850.5		

Sampling Analysis
Project #19531

0 - 3" Front and Back

	A	A	A
Street/Number	PPM	PPM	PPM
Address	No.	No.	No.

1240/42 Grand 193 126
1048

3 - 6" Front and Back

B	B	B
PPM	PPM	PPM
No.	No.	No.

187 465
830


6 - 12" Front and Back

C	C	C
PPM	PPM	PPM
No.	No.	No.

173 428
1129

Depth
Excav.
(inch)

12

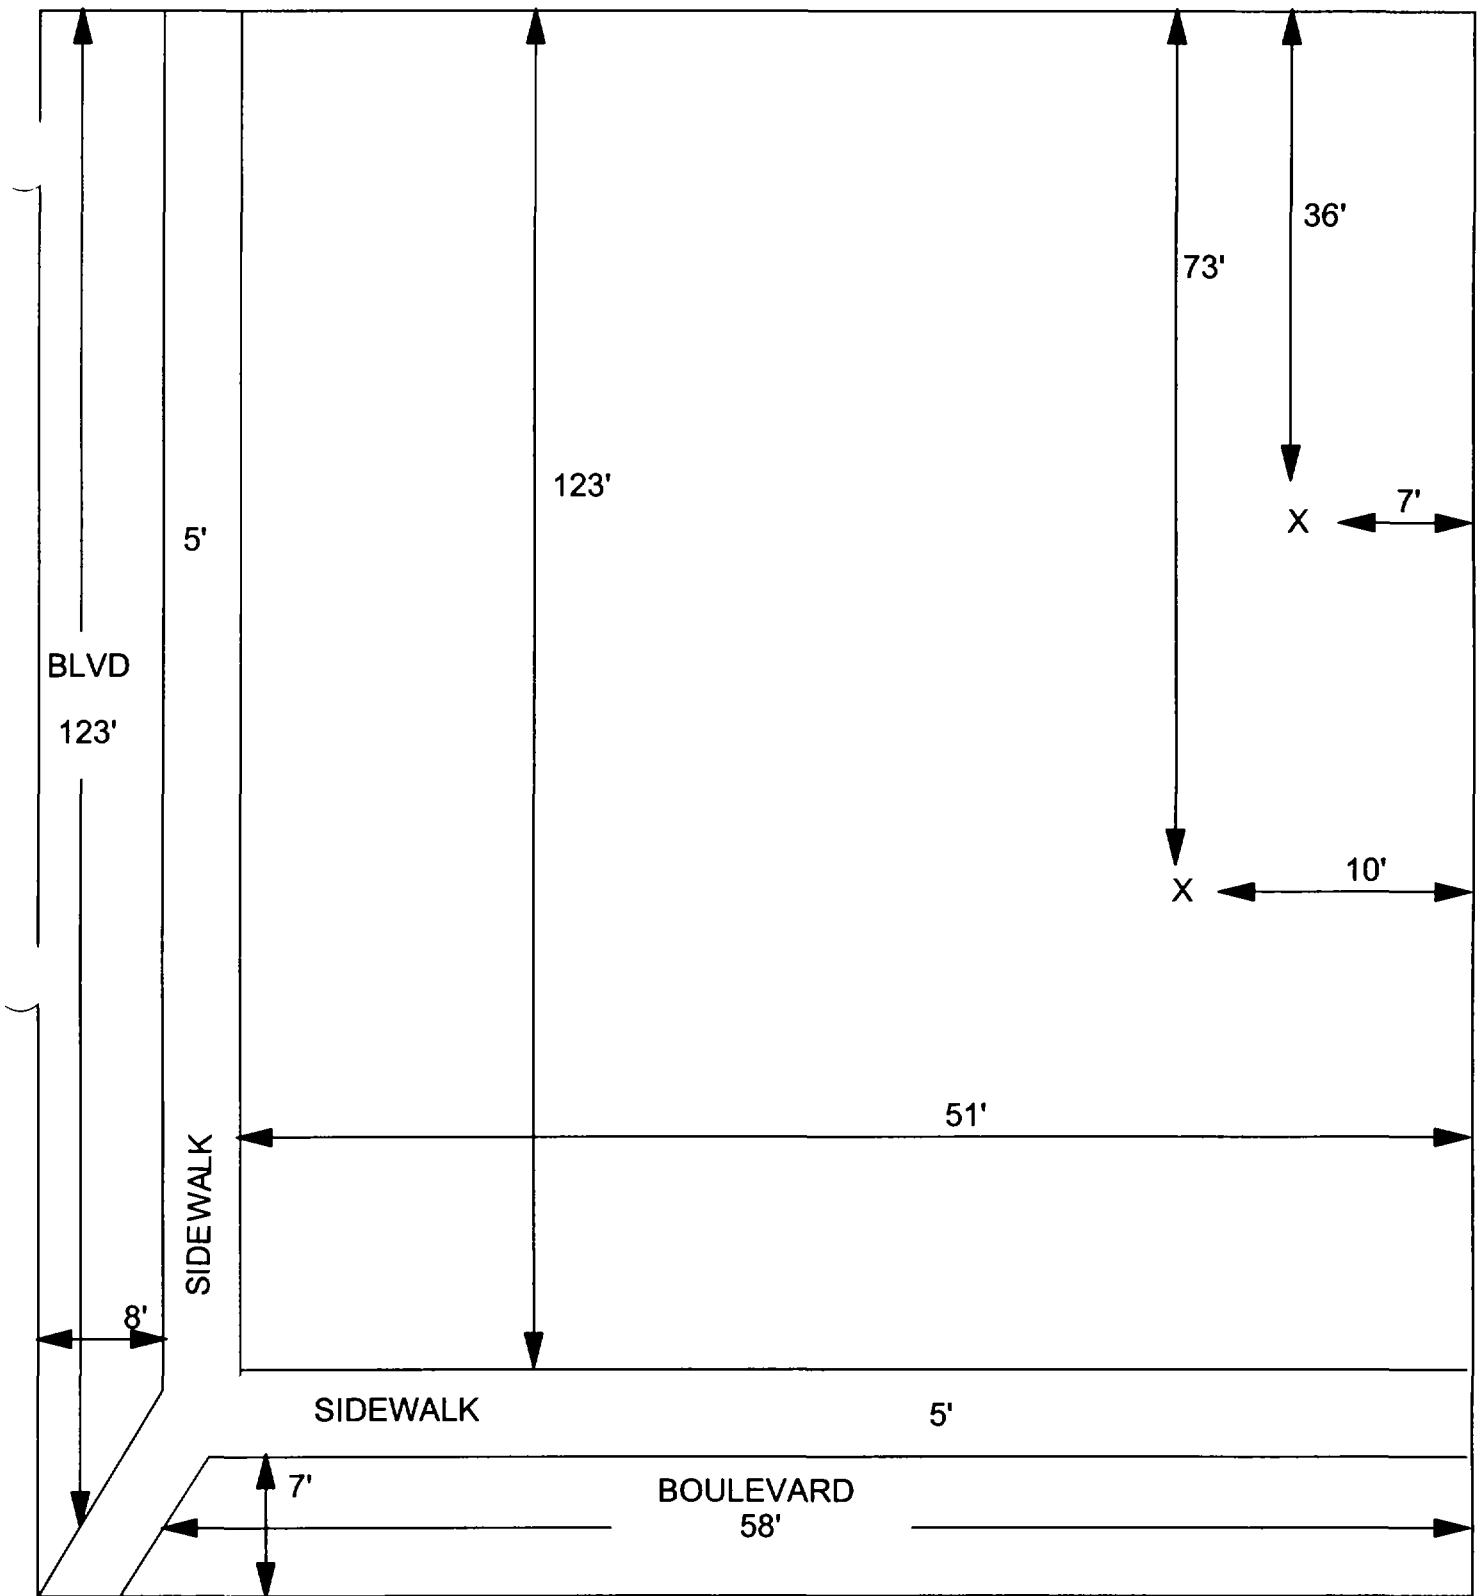

X = SAMPLE POINT

1240/42 GRAND

TOTAL
DIMENSIONS
123' X 51'

**OHM
CORPORATION**
Findlay, Ohio

Drawn By:

Checked By:

Date

Approved By:

Scale

Drawing No:

1300 Grand

Action Date: 5/12/97

Loadout: 5/14/97

Restoration Begins: 5/14/97

Restoration Completed: 5/15/97

*Stack emission sites were not sampled for verification due to the fact that a pre-determined depth for excavation was given to OHM by USACE.

*An excavation depth of 12 inches was established by USACE prior to work commencing.

*The excavation of special waste yielded a total of 79.71 cubic yards, which was shipped to WMI-Milam for disposal.

*Equipment utilized during excavation:

*TL-26

*TCM

*X331

*17-KW

*Subcontractors:

*WMI-landfill

*B. Garcia-trucking

*Granthum-trucking

*Schneider Turf Farm

OHM CORPORATION
PROJECT 19531
GRANITE CITY, IL

QUANTITY SUMMARY FOR 1300 Grand

SPECIAL WASTE (TONS)	BACKFILL (LOADS)	TOPSOIL (TONS)	CA-6 (TONS)	CA-7 (TONS)	SAND (TONS)	SOD CU.YDS.	CONCRETE	OTHER
103.63	4	30.86	13.95	13.95		220.5		

**Sampling Analysis
Project #19531**


0 - 3" Front and Back				
Street/Number Address	A		A	
	PPM	No.	PPM	No.
	No.		No.	

3 - 6" Front and Back				
	B		B	
	PPM	No.	PPM	No.
	No.		No.	

6 - 12" Front and Back				
	C		C	
	PPM	No.	PPM	No.
	No.		No.	

Depth Excav. (inch)

1300 Grand	232	679	94	865	12
	929	365	214	815	

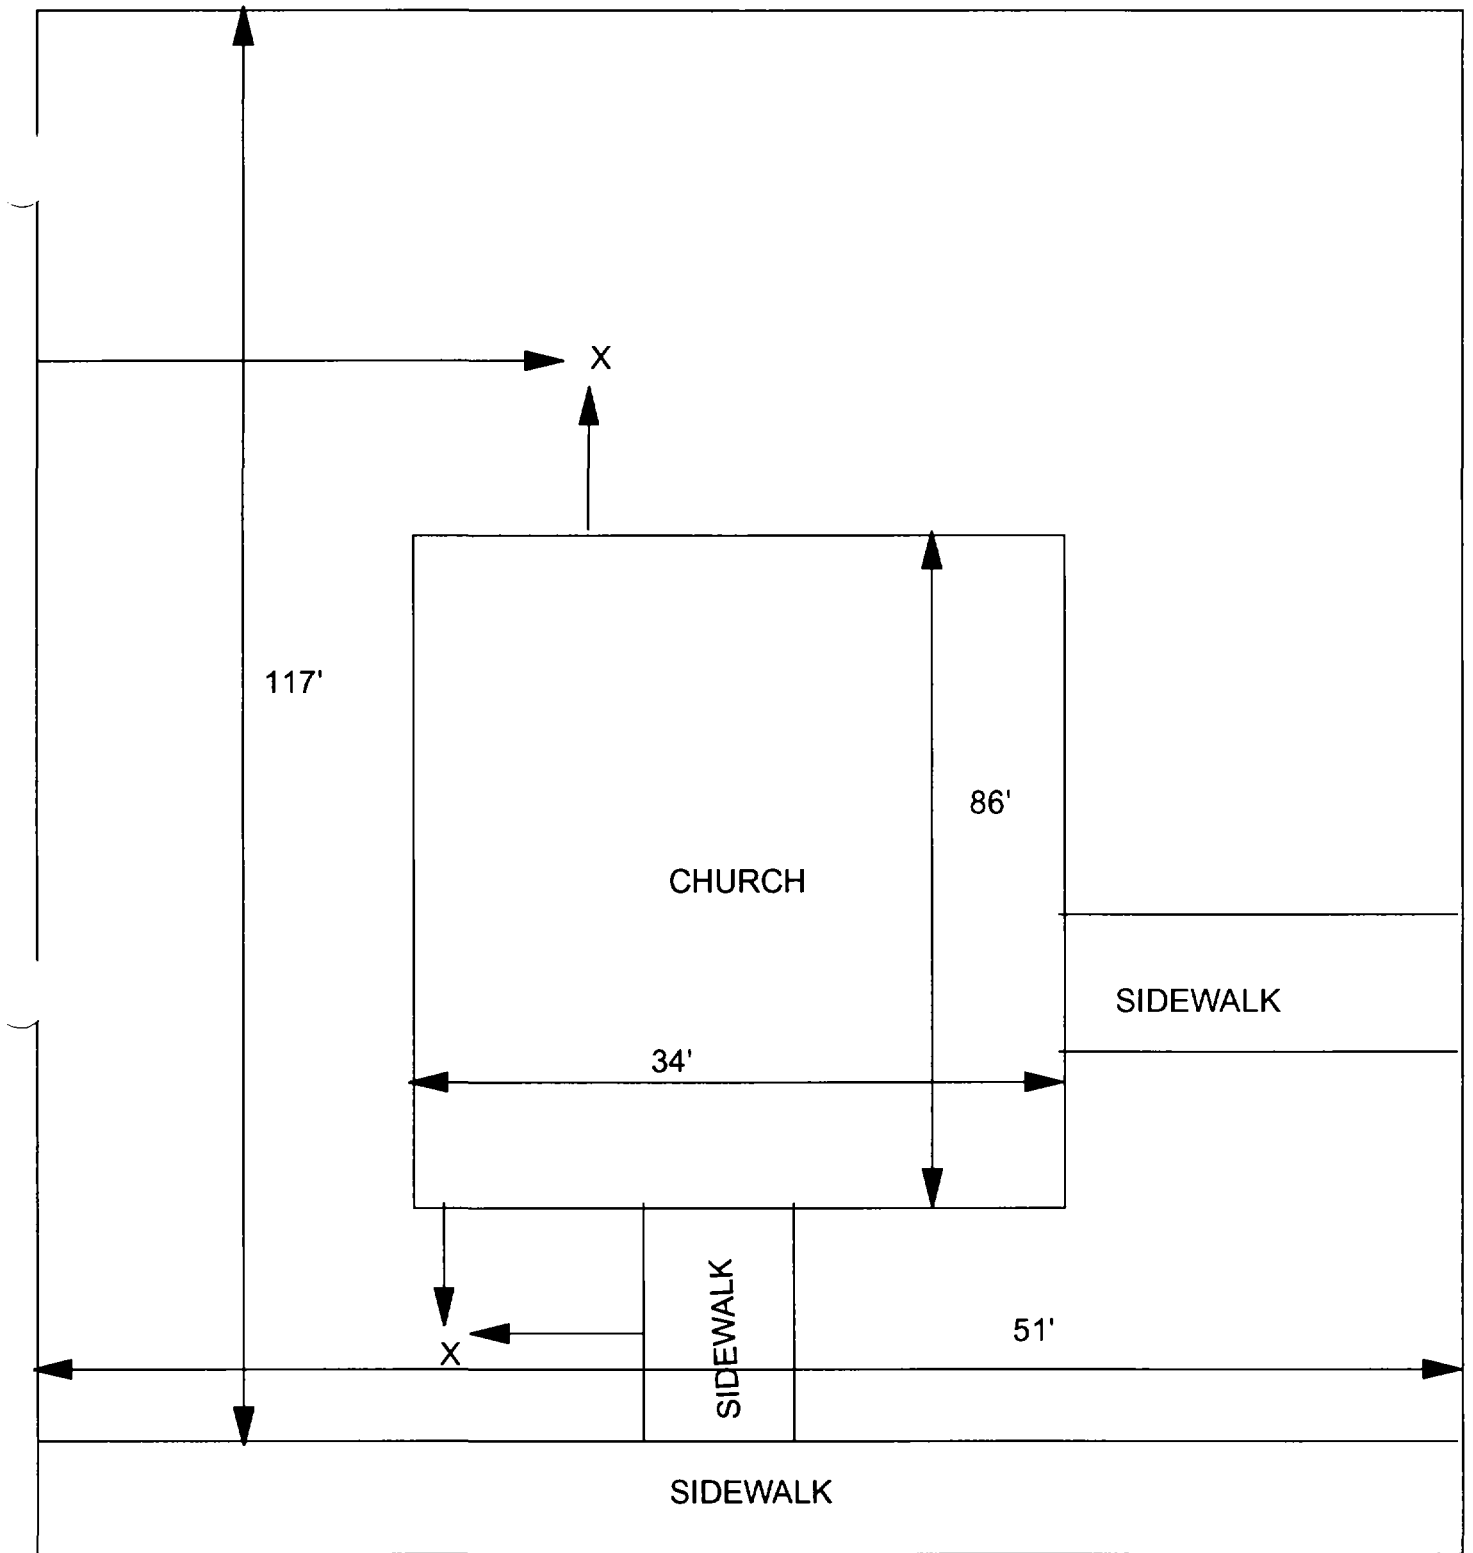

X = SAMPLE POINT

1300 GRAND
51' X 117'

OHM 
Corporation
Findlay Ohio

Drawn By: **EDJ** : Checked By:

Date: **7/28/98** : Approved By:

Scale: **NTS** : Drawing No:

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1303 Grand

Action Date: 4/28/97

✓ Loadout: 4/30/97

Restoration Begins: 4/30/97

Restoration Completed: 5/16/97

*Stack emission sites were not sampled for verification due to the fact that a pre-determined depth for excavation was given to OHM by USACE.

*An excavation depth of 12 inches was established by USACE prior to work commencing.

*The excavation of special waste yielded a total of 98.73 cubic yards, which was shipped to WMI-Milam for disposal.

*Equipment utilized during excavation:

*TL-26

*TCM

*X331

*17-KW

*Subcontractors:

*WMI-landfill

*B. Garcia-trucking

*Granthum-trucking

*Schneider Turf Farm

OHM CORPORATION
PROJECT 19531
GRANITE CITY, IL

QUANTITY SUMMARY FOR 1303 Grand

SPECIAL WASTE (TONS)	BACKFILL (LOADS)	TOPSOIL (TONS)	CA-6 (TONS)	CA-7 (TONS)	SAND (TONS)	SOD CU.YDS.	CONCRETE	OTHER
128.36	7	30.86	40.8			346.5		

**Sampling Analysis
Project #19531**

0 - 3" Front and Back

	A		A	
Street/Number	PPM	No.	PPM	No.
Address	No.	No.	No.	No.

3 - 6" Front and Back

	B		B	
PPM	PPM	No.	PPM	No.
No.	No.	No.	No.	No.

6 - 12" Front and Back

	C		C	
PPM	PPM	No.	PPM	No.
No.	No.	No.	No.	No.

Depth
Excav.
(inch)


1303 Grand

970 640

560 1100

570 550

12

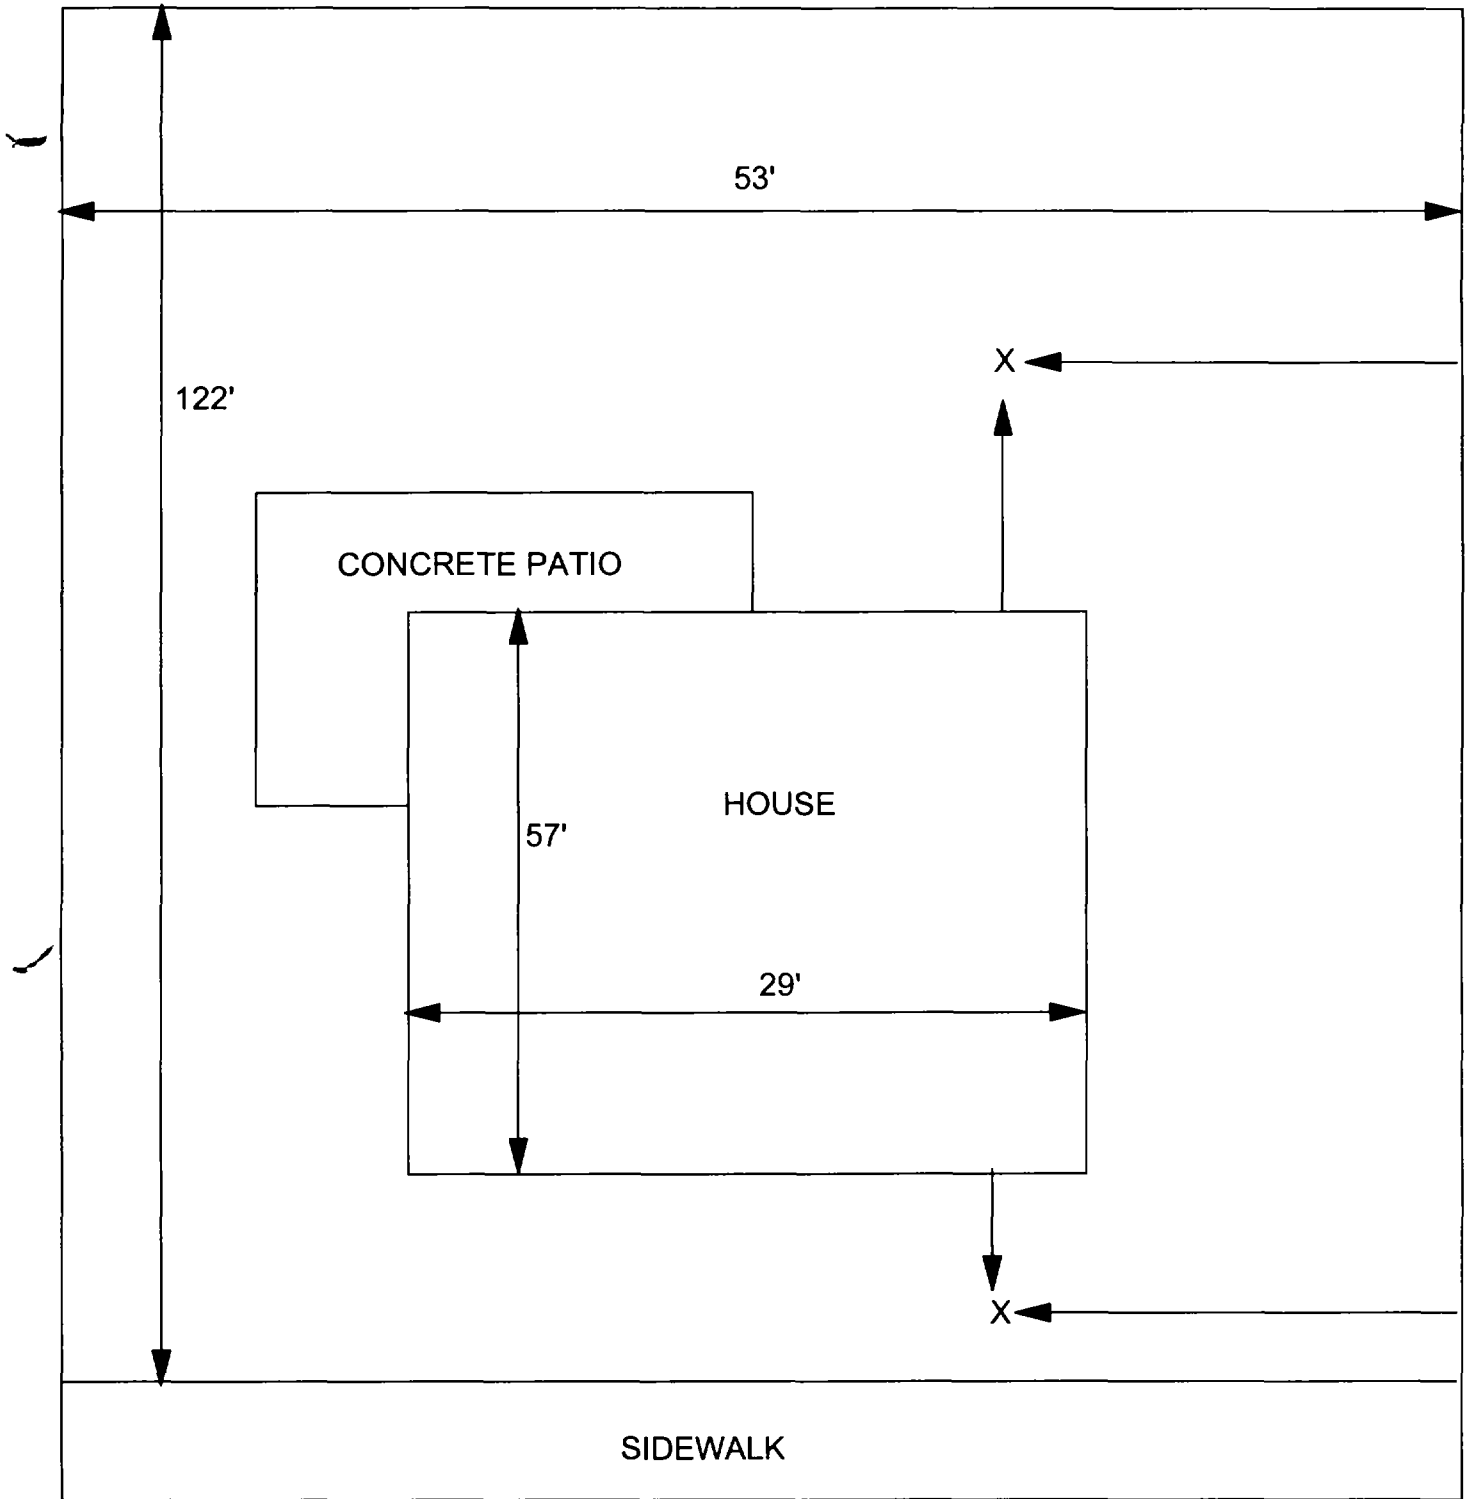

X = SAMPLE POINT

1303 GRAND
53' X 122'

**OHM
CORPORATION**
Findlay, Ohio

Drawn By	EDJ	Checked By	
Date	8/25/98	Approved By	
Scale	NTS	Drawing No.	

-
)

)

-
)

1307 Grand

Action Date: 5/15/97

Loadout: 5/16/97

Restoration Begins: 5/20/97

Restoration Completed: 6/2/97

*Stack emission sites were not sampled for verification due to the fact that a pre-determined depth for excavation was given to OHM by USACE.

*An excavation depth of 6 inches was established by USACE prior to work commencing.

*The excavation of special waste yielded a total of 83.46 cubic yards, which was shipped to WMI-Milam for disposal.

*Equipment utilized during excavation:

*TL-26

*TCM

*X331

*17-KW

*Subcontractors:

*WMI-landfill

*B. Garcia-trucking

*Grantham-trucking

*Schneider-turf farm

**OHM CORPORATION
PROJECT 19531
GRANITE CITY, IL**

QUANTITY SUMMARY FOR

1307 Grand

SPECIAL WASTE (TONS)	BACKFILL (LOADS)	TOPSOIL (TONS)	CA-6 (TONS)	CA-7 (TONS)	SAND (TONS)	SOD CU.YDS.	CONCRETE	OTHER
108.51		49.88		49.75		381		

**Sampling Analysis
Project #19531**

0 - 3" Front and Back

Street/Number Address	A		A	
	PPM	No.	PPM	No.
1307 Grand	660		560	


3 - 6" Front and Back

	B		B	
	PPM	No.	PPM	No.
	537	327		
	450	397		

6 - 12" Front and Back

	C		C	
	PPM	No.	PPM	No.
	463	263		

Depth Excav. (inch)
6

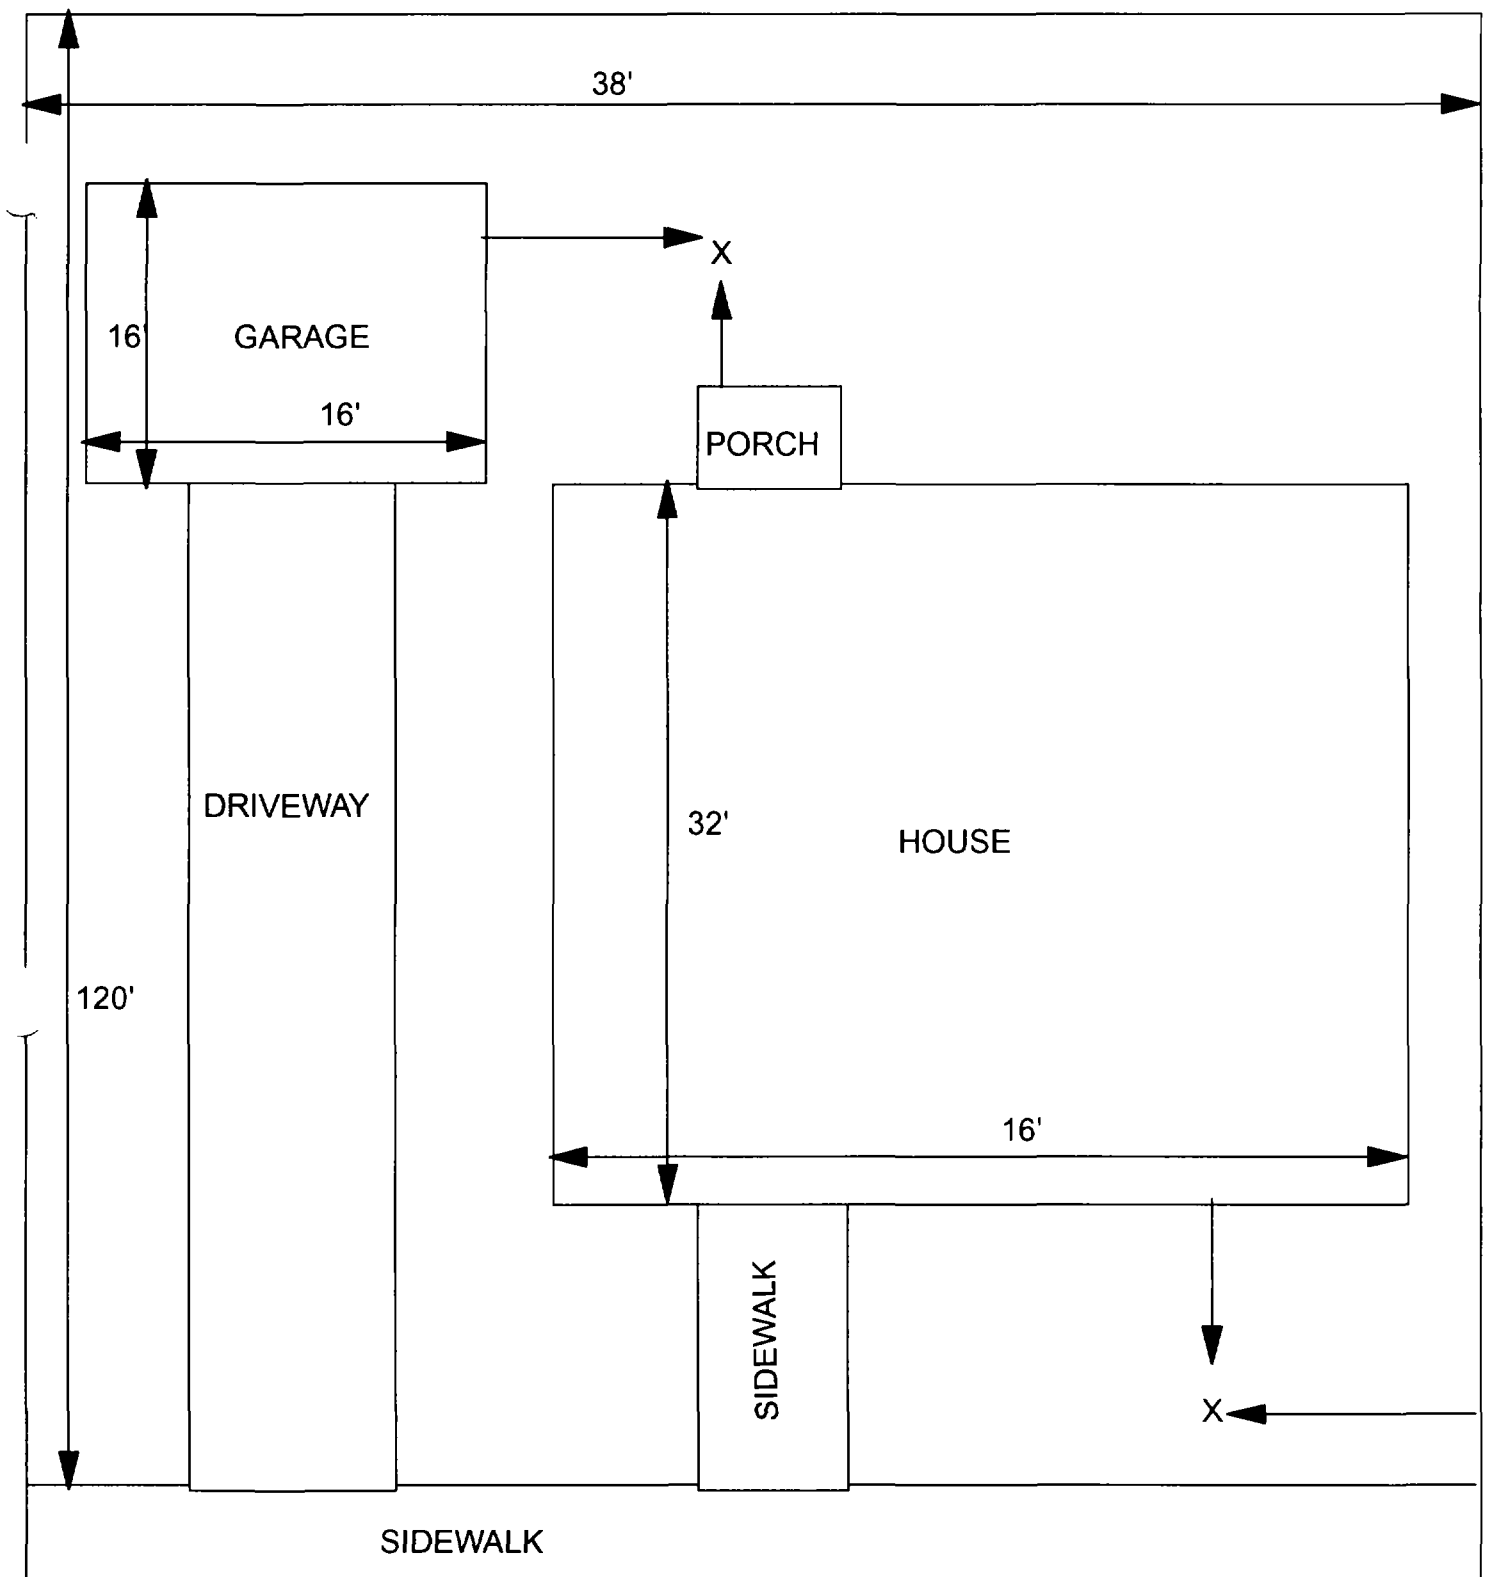

X = SAMPLE POINT

1307 GRAND
38' X 120'

OHM 
Corporation
Findlay, Ohio

Drawn By: **EDJ** Checked By:

Date: **7/29/98** Approved By:

Scale: **NTS** Drawing No:

1

2

3

4

5

1309 Grand

Action Date: 5/16/97

Loadout: 5/19/97

Restoration Begins: 5/19/97

Restoration Completed: 6/2/97

*Stack emission sites were not sampled for verification due to the fact that a pre-determined depth for excavation was given to OHM by USACE.

*An excavation depth of 6 inches was established by USACE prior to work commencing.

*The excavation of special waste yielded a total of 67.14 cubic yards, which was shipped to WMI-Milam for disposal.

*Equipment utilized during excavation:

*TL-26

*TCM

*X331

*17-KW

*Subcontractors:

*WMI-landfill

*B. Garcia-trucking

*Granthum-trucking

*Schneider Turf Farm

OHM CORPORATION
PROJECT 19531
GRANITE CITY, IL

QUANTITY SUMMARY FOR 1309 Grand

SPECIAL WASTE (TONS)	BACKFILL (LOADS)	TOPSOIL (TONS)	CA-6 (TONS)	CA-7 (TONS)	SAND (TONS)	SOD CU.YDS.	CONCRETE	OTHER
87.29	3	64.26		31.9		381		

**Sampling Analysis
Project #19531**

0 - 3" Front and Back				
Street/Number Address	A	A	A	
	PPM	PPM	PPM	
	No.	No.	No.	

1309 Grand **630** 391
237 454

3 - 6" Front and Back				
	B	B	B	
	PPM	PPM	PPM	
	No.	No.	No.	


333 **535**
392 296
318 434

6 - 12" Front and Back				
	C	C	C	
	PPM	PPM	PPM	
	No.	No.	No.	

135 458

Depth
Excav.
(inch)

6

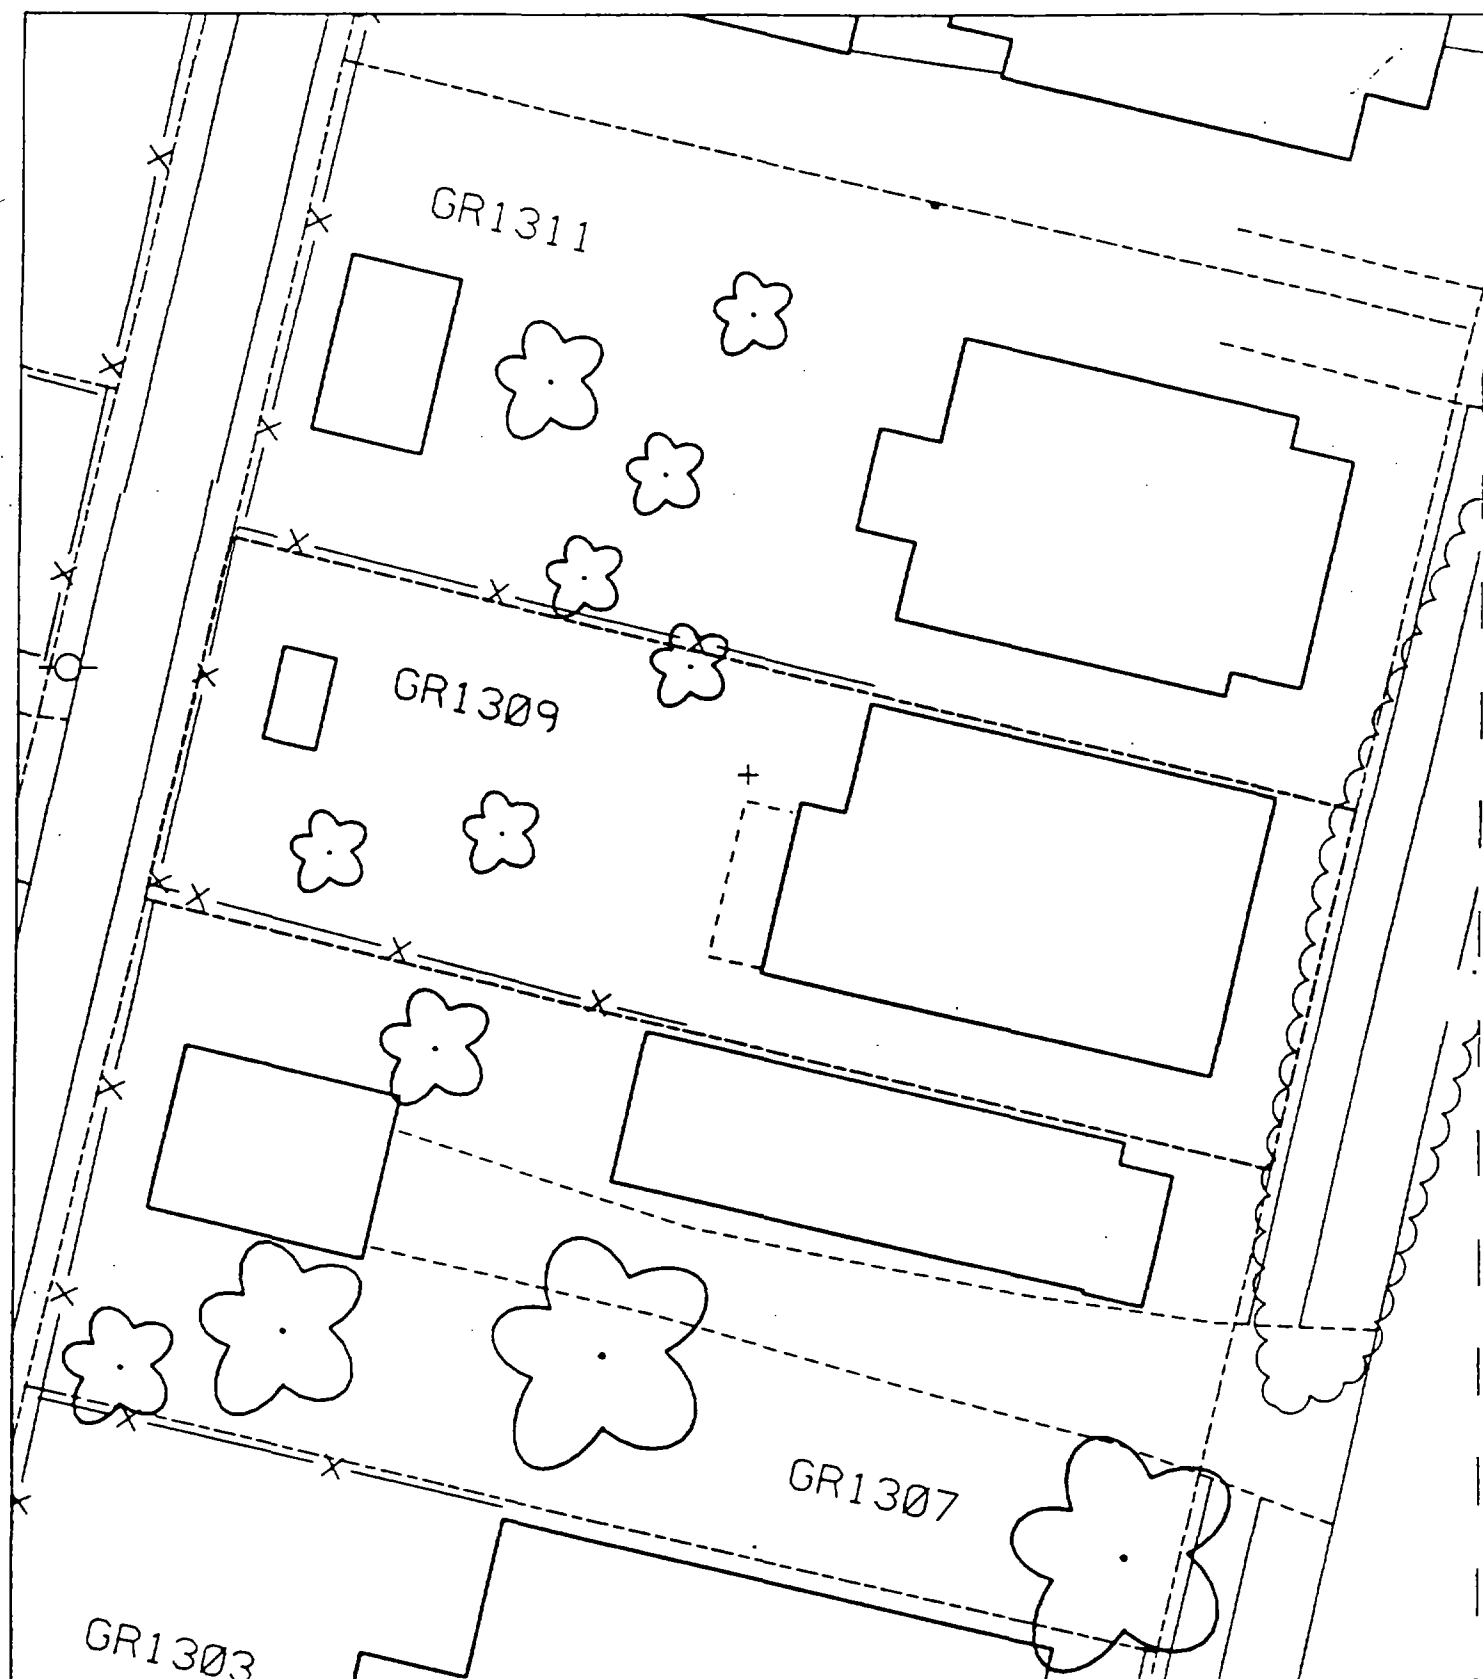

1311 Grand

Action Date: 4/4/97

Loadout: 4/8/97

Restoration Begins: 4/8/97

Restoration Completed: 4/25/97

*Stack emission sites were not sampled for verification due to the fact that a pre-determined depth for excavation was given to OHM by USACE.

*An excavation depth of 6 inches was established by USACE prior to work commencing.

*The excavation of special waste yielded a total of 68.53 cubic yards, which was shipped to WMI-Milam for disposal.

*Equipment utilized during excavation:

*TL-26

*TCM

*X331

*17-KW

*Subcontractors:

*WMI-landfill

*B. Garcia-trucking

*Granthum-trucking

*Schneider Turf Farm

OHM CORPORATION
 PROJECT 19531
 GRANITE CITY, IL

QUANTITY SUMMARY FOR 1311 Grand

SPECIAL WASTE (TONS)	BACKFILL (LOADS)	TOPSOIL (TONS)	CA-6 (TONS)	CA-7 (TONS)	SAND (TONS)	SOD CU.YDS.	CONCRETE	OTHER
89.1	3	70.43		28.75		360		

**Sampling Analysis
Project #19531**

0 - 3" Front and Back

	A		A	
Street/Number	PPM	No.	PPM	No.
1311 Grand	1020	339		
	1160	1120		

3 - 6" Front and Back


	B		B	
PPM	PPM	PPM	PPM	PPM
No.	No.	No.	No.	No.
903	376			
494	754			

6 - 12" Front and Back

	C		C	
PPM	PPM	PPM	PPM	PPM
No.	No.	No.	No.	No.
546	357			
126	336			

Depth	
Excav.	
(inch)	

6

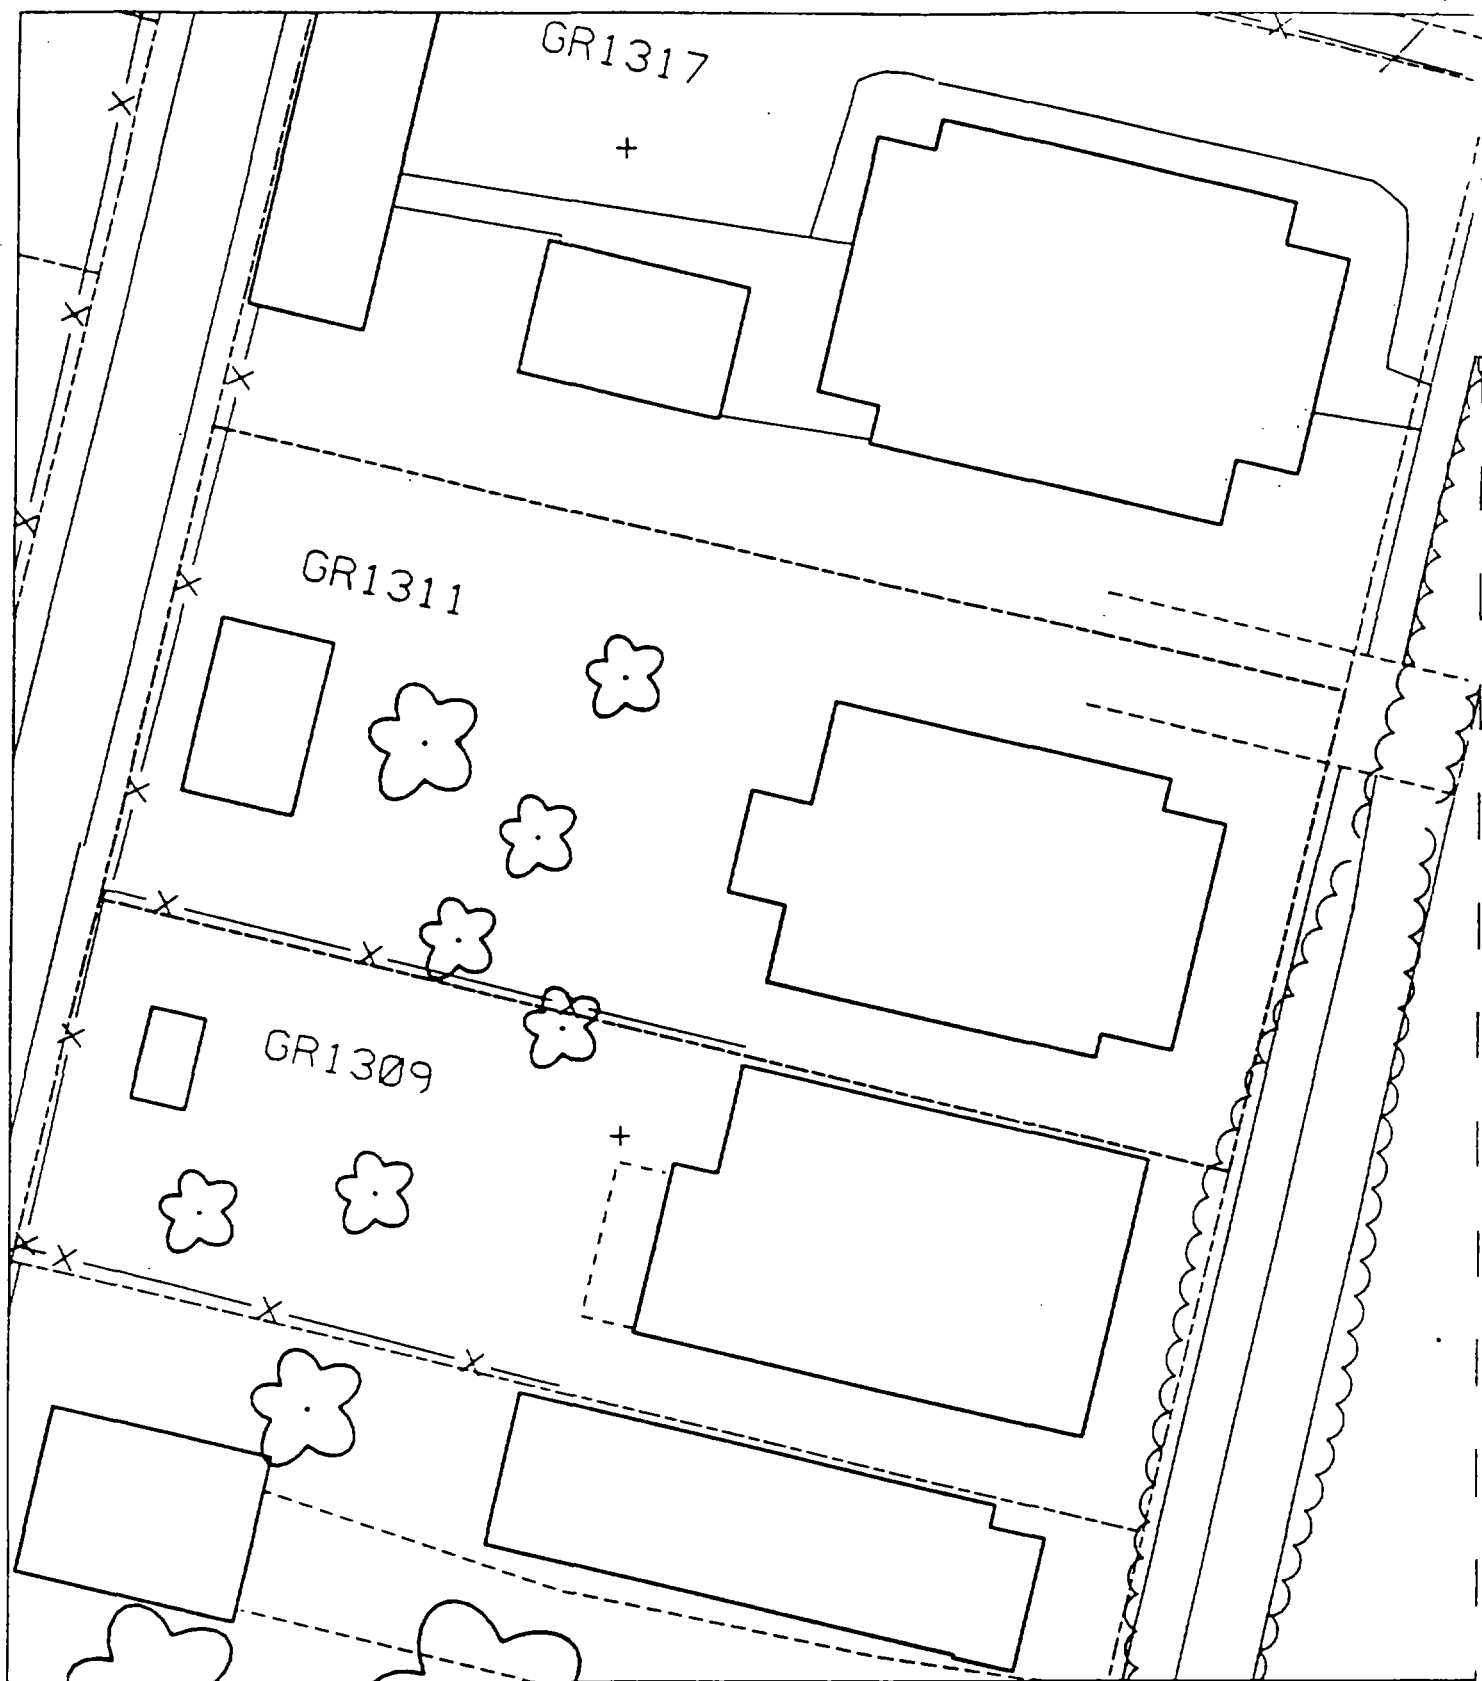

1317 Grand

Action Date: 11/15/97

Loadout: 11/17/97

Restoration Begins: 11/17/97

Restoration Completed: 11/24/97

*Stack emission sites were not sampled for verification due to the fact that a pre-determined depth for excavation was given to OHM by USACE.

*An excavation depth of 6 inches was established by USACE prior to work commencing.

*The excavation of special waste yielded a total of 100.04 cubic yards, which was shipped to WMI-Milam for disposal.

*Equipment utilized during excavation:

*TL-26

*TCM

*X331

*17-KW

*Subcontractors:

*WMI-landfill

*B. Garcia-trucking

*Grantham-trucking

*Emerald-turf farm

**OHM CORPORATION
PROJECT 19531
GRANITE CITY, IL**

QUANTITY SUMMARY FOR

1317 Grand

SPECIAL WASTE (TONS)	BACKFILL (LOADS)	TOPSOIL (TONS)	CA-6 (TONS)	CA-7 (TONS)	SAND (TONS)	SOD CU.YDS.	CONCRETE	OTHER
130.06	10	50.36		13.2		540		

**Sampling Analysis
Project #19531**

0 - 3" Front and Back

Street/Number Address	A		A	
	PPM	No.	PPM	No.
	PPM	No.	PPM	No.

1317 Grand 455 651

3 - 6" Front and Back

	B		B	
	PPM	No.	PPM	No.
	PPM	No.	PPM	No.

334 724
336 850


6 - 12" Front and Back

	C		C	
	PPM	No.	PPM	No.
	PPM	No.	PPM	No.

232 226

	Depth	
	Excav.	(inch)

6

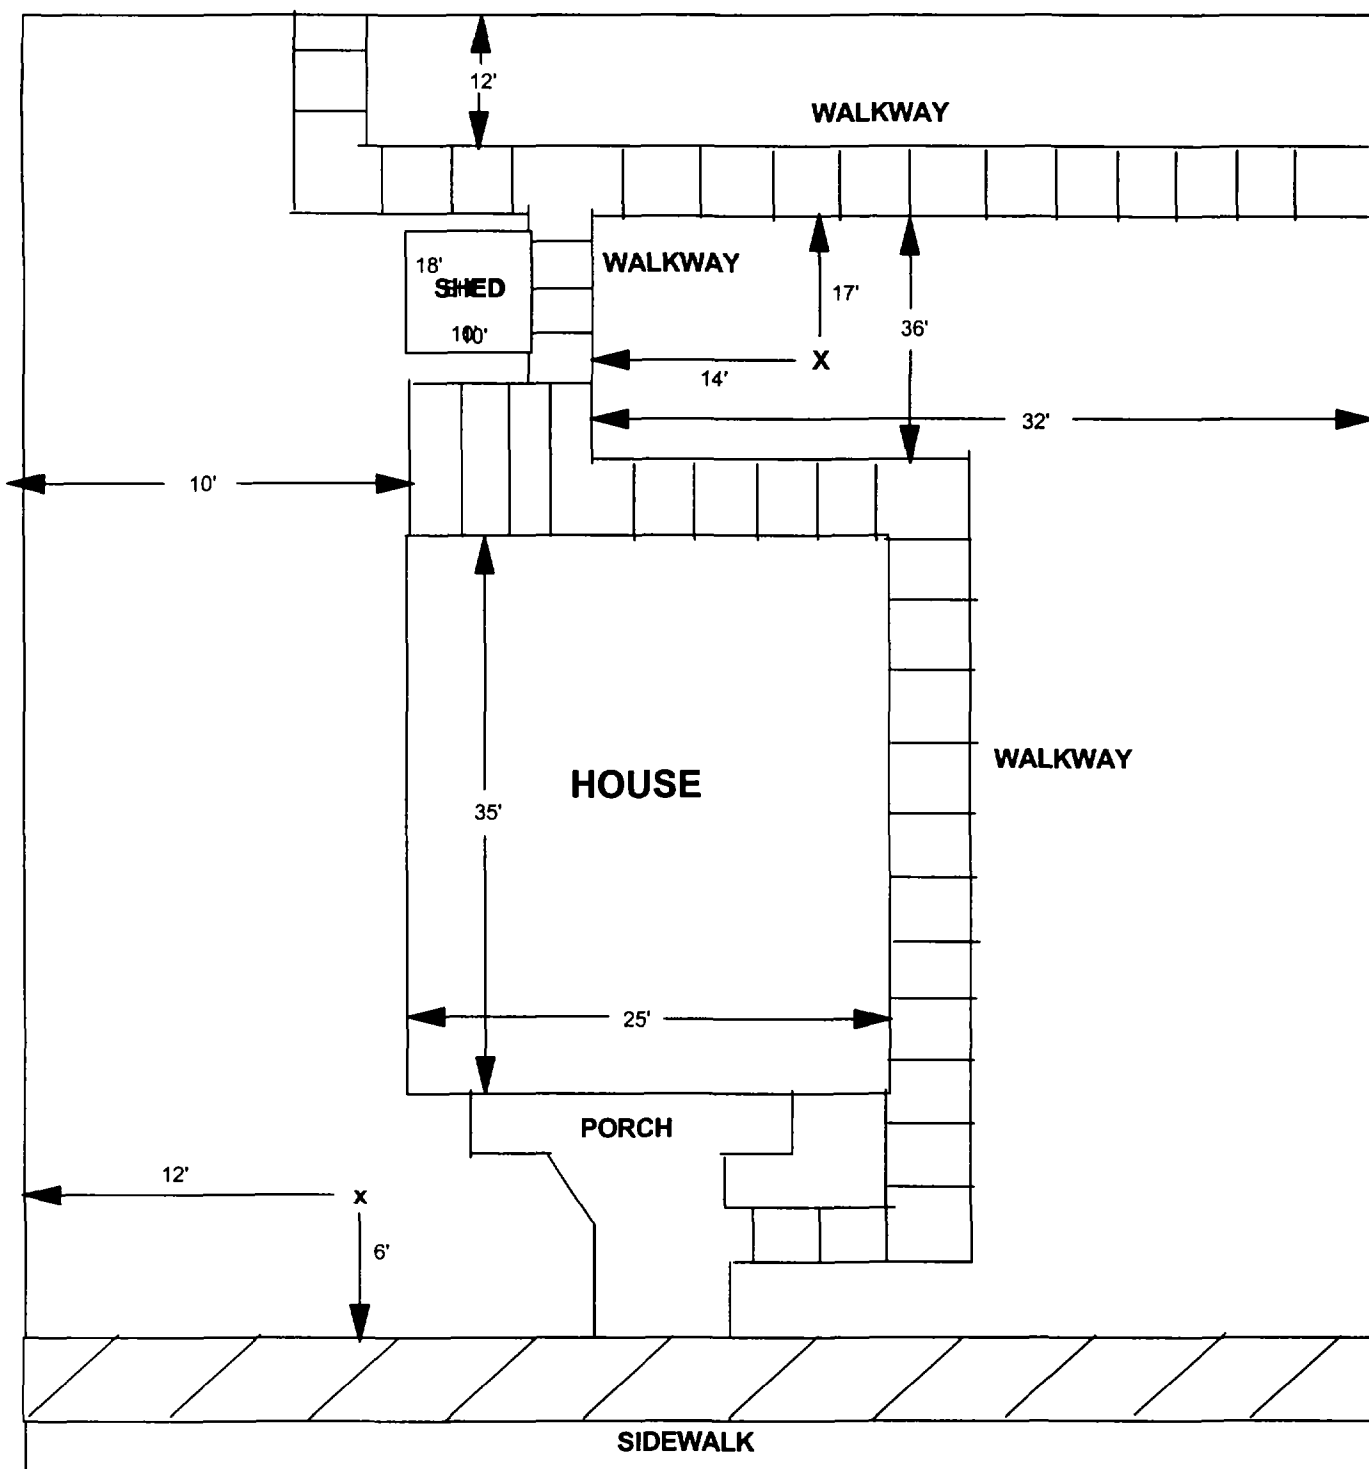

X = SAMPLE POINT

1317 GRAND

**TOTAL
DIMENSIONS
99'X55'**

OHM 
Corporation
Findlay, Ohio

Drawn By: JG	Checked By:
Date: 8/19/98	Approved By:
Scale: NTS	Drawing No:

1323 Grand

Action Date: 3/12/97

Loadout: 3/17/97

Restoration Begins: 3/20/97

Restoration Completed: 3/22/97

*Stack emission sites were not sampled for verification due to the fact that a pre-determined depth for excavation was given to OHM by USACE.

*An excavation depth of 3 inches was established by USACE prior to work commencing.

*The excavation of special waste yielded a total of 35.78 cubic yards, which was shipped to WMI-Milam for disposal.

*Equipment utilized during excavation:

*TL-26

*X331

*17-KW

*Subcontractors:

*WMI-landfill

*B. Garcia-trucking

*Granthum-trucking

*Petago Sod Farm

OHM CORPORATION
PROJECT 19531
GRANITE CITY, IL

QUANTITY SUMMARY FOR

1323 Grand

SPECIAL WASTE (TONS)	BACKFILL (LOADS)	TOPSOIL (TONS)	CA-6 (TONS)	CA-7 (TONS)	SAND (TONS)	SOD CU.YDS.	CONCRETE	OTHER
46.52		29.5		29.5		157.5		

Sampling Analysis
Project #19531

0 - 3" Front and Back				
Street/Number Address	A	A	A	A
	PPM	PPM	PPM	PPM
	No.	No.	No.	No.

1323 Grand 425 594

3 - 6" Front and Back				
B	B	B	B	B
	PPM	PPM	PPM	PPM
	No.	No.	No.	No.


298 496

6 - 12" Front and Back				
C	C	C	C	C
	PPM	PPM	PPM	PPM
	No.	No.	No.	No.

224 440

Depth Excav. (inch)

3

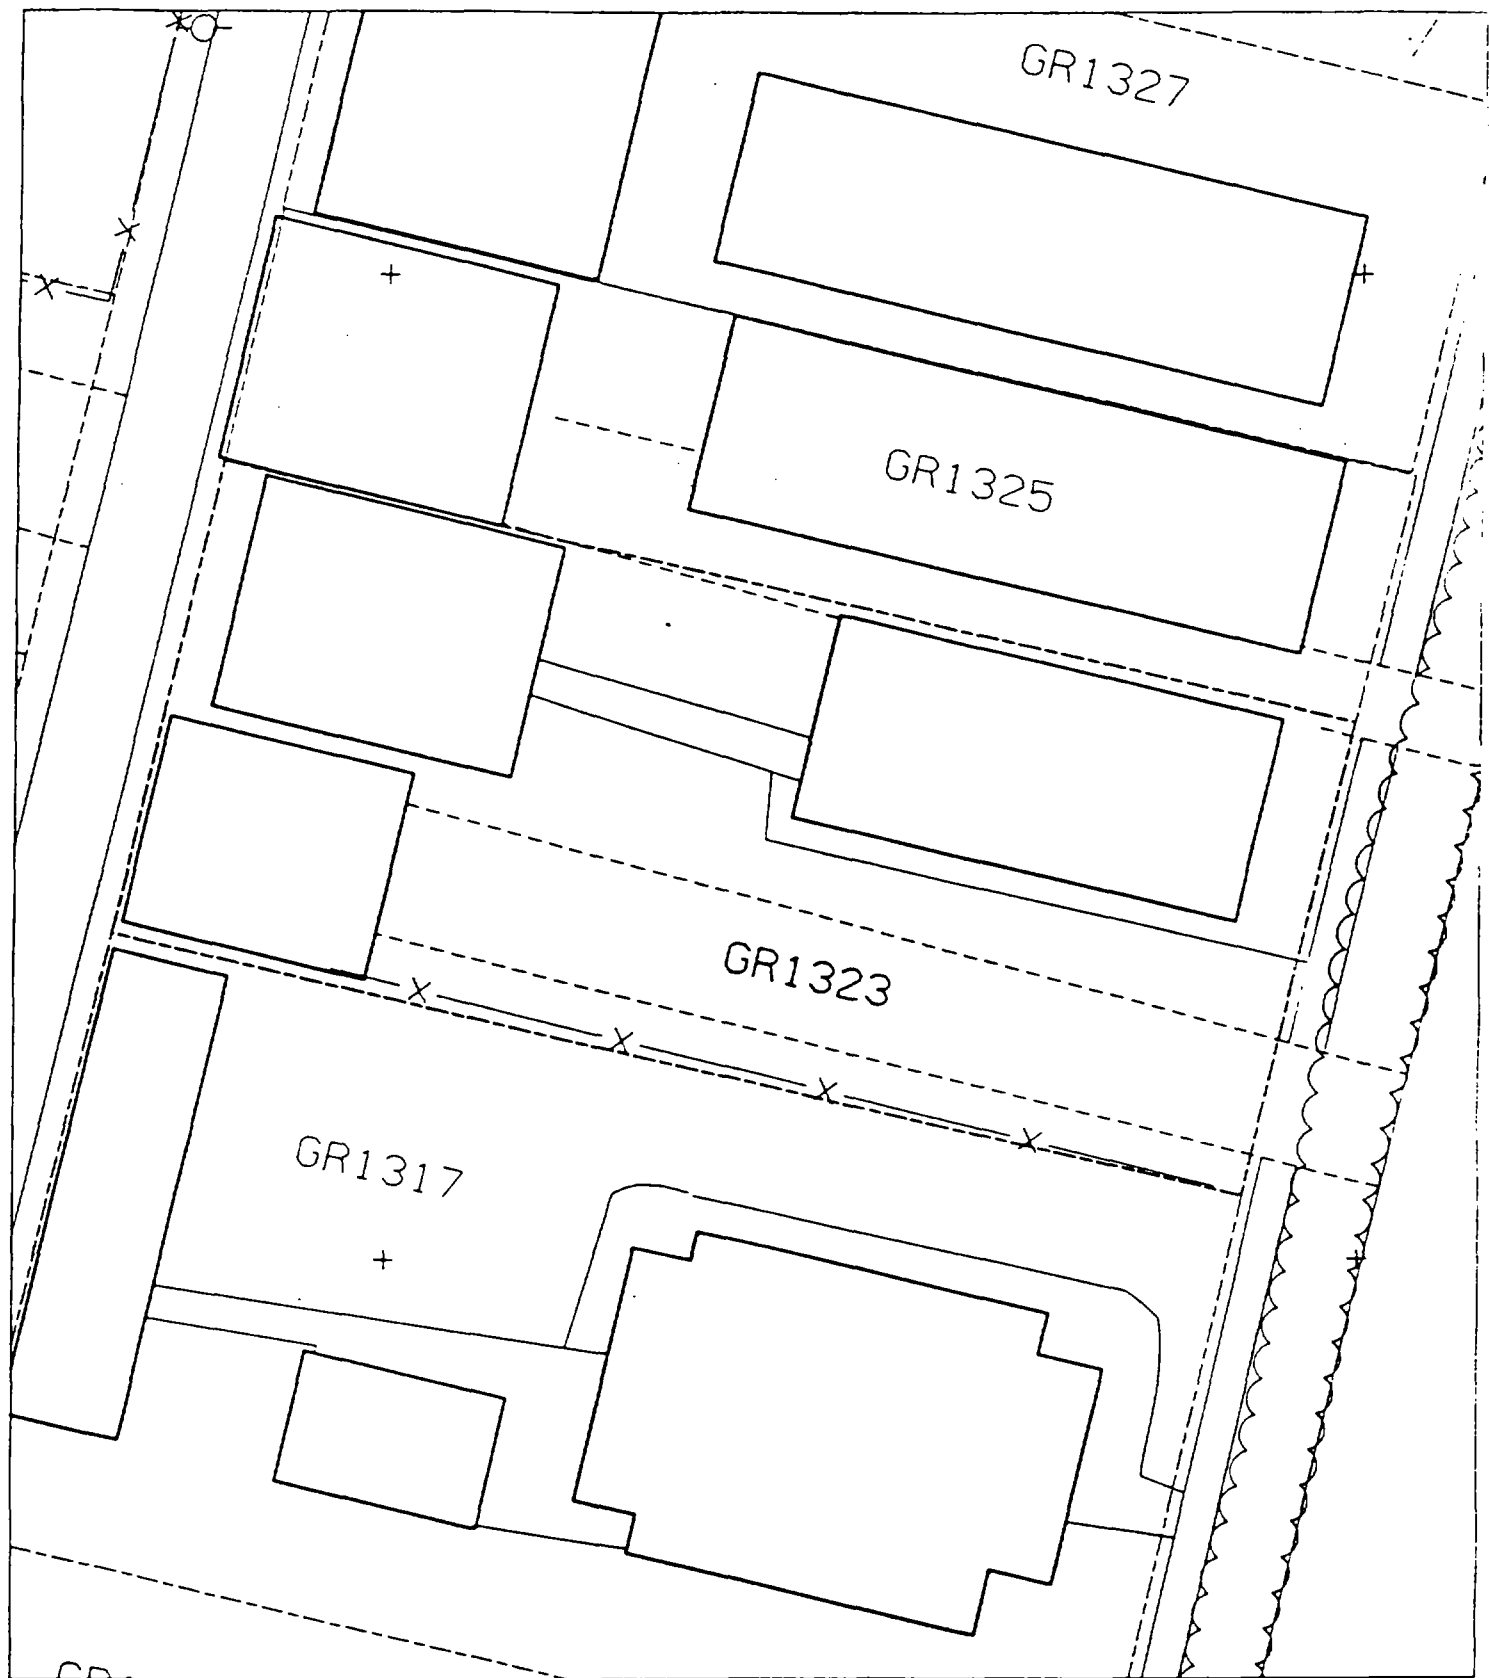

1

2

3

1325 Grand

Action Date: 11/19/97

Loadout: 11/20/97

Restoration Begins: 11/21/97

Restoration Completed: 11/24/97

*Stack emission sites were not sampled for verification due to the fact that a pre-determined depth for excavation was given to OHM by USACE.

*An excavation depth of 6 inches was established by USACE prior to work commencing.

*The excavation of special waste yielded a total of 16.62 cubic yards, which was shipped to WMI-Milam for disposal.

*Equipment utilized during excavation:

*TL-26

*TCM

*X331

*17-KW

*Subcontractors:

*WMI-landfill

*B. Garcia-trucking

*Grantham-trucking

*Emerald-turf farm

Sampling Analysis
Project #19531

0 - 3" Front and Back

	A	A	A
Street/Number	PPM	PPM	PPM
Address	No.	No.	No.

1325 Grand 1520 613

3 - 6" Front and Back

B	B	B
PPM	PPM	PPM
No.	No.	No.

944 867

6 - 12" Front and Back

C	C	C
PPM	PPM	PPM
No.	No.	No.

402 282

Depth
Excav.
(inch)

6

OHM CORPORATION
PROJECT 19531
GRANITE CITY, IL

QUANTITY SUMMARY FOR 1325 Grand

SPECIAL WASTE (TONS)	BACKFILL (LOADS)	TOPSOIL (TONS)	CA-6 (TONS)	CA-7 (TONS)	SAND (TONS)	SOD CU.YDS.	CONCRETE	OTHER
21.61	1		14.95			60		

GR1329

GR1327

GR1325

GR1323

GR1317

,

,

,
)

Action Date: 4/1/97

— Loadout: 4/2/97

Restoration Begins: 4/3/97

Restoration Completed: 4/4/97

*Stack emission sites were not sampled for verification due to the fact that a pre-determined depth for excavation was given to OHM by USACE.

*An excavation depth of 6 inches was established by USACE prior to work commencing.

*The excavation of special waste yielded a total of 189.72 cubic yards, which was shipped to WMI-Milam for disposal.

*Equipment utilized during excavation:

*TL-26 *Roller

*X331

*17-KW

*Subcontractors:

*WMI-landfill

*B. Garcia-trucking

*Granthum-trucking

OHM CORPORATION
PROJECT 19531
GRANITE CITY, IL

QUANTITY SUMMARY FOR 1330/32 Grand

SPECIAL WASTE (TONS)	BACKFILL (LOADS)	TOPSOIL (TONS)	CA-6 (TONS)	CA-7 (TONS)	SAND (TONS)	SOD CU.YDS.	CONCRETE	OTHER
246.64		15	358.75			30		

**Sampling Analysis
Project #19531**

0 - 3" Front and Back			
A	A	A	A
Street/Number	PPM	PPM	PPM
Address	No.	No.	No.

3 - 6" Front and Back			
B	B	B	B
PPM	PPM	PPM	PPM
No.	No.	No.	No.

6 - 12" Front and Back			
C	C	C	C
PPM	PPM	PPM	PPM
No.	No.	No.	No.


Depth
Excav.
(inch)

1330/32 Grand **3858**

536

170

6

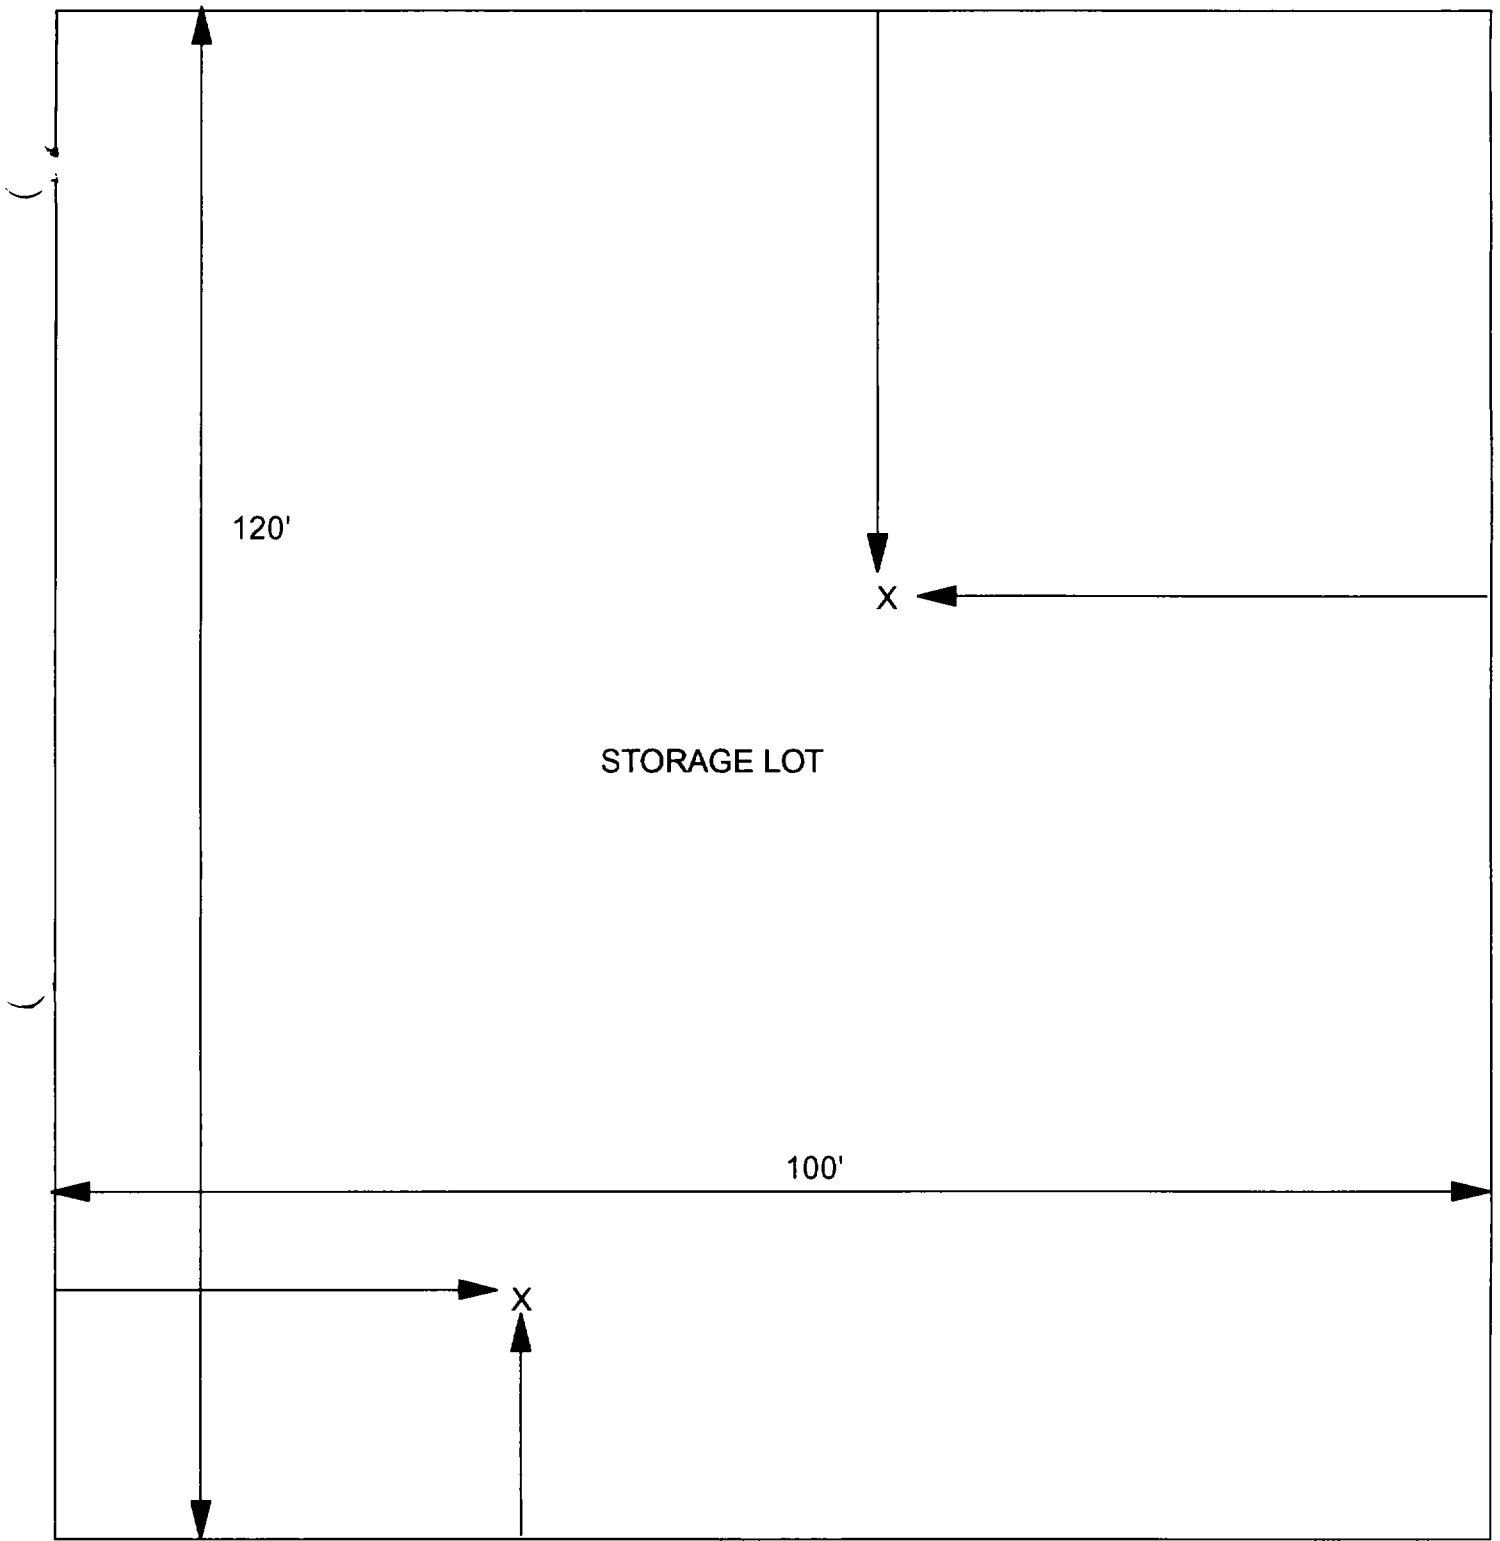

X = SAMPLE POINT

1330/32 GRAND
100' X 200'

OHM 
Corporation
Findlay Ohio

Drawn By: **EDJ** Checked By:

Date: **7/29/98** Approved By:

Scale: **NTS** Drawing No:

1

2

3

1413 Grand

Action Date: 4/8/97

Loadout: 4/14/97

Restoration Begins: 4/14/97

Restoration Completed: 4/25/97

*Stack emission sites were not sampled for verification due to the fact that a pre-determined depth for excavation was given to OHM by USACE.

*An excavation depth of 12 inches was established by USACE prior to work commencing.

*The excavation of special waste yielded a total of 58.58 cubic yards, which was shipped to WMI-Milam for disposal.

*Equipment utilized during excavation:

*TL-26 *TCM

*X331

*17-KW

*Subcontractors:

*WMI-landfill

*B. Garcia-trucking

*Granthum-trucking

*Schneider Turf Farm

EASEMENT INFORMATION

This easement was completed after the Temporary Restraining Order (TRO) was lifted.

OHM CORPORATION
PROJECT 19531
GRANITE CITY, IL

QUANTITY SUMMARY FOR 1413 Grand

SPECIAL WASTE (TONS)	BACKFILL (LOADS)	TOPSOIL (TONS)	CA-6 (TONS)	CA-7 (TONS)	SAND (TONS)	SOD CU.YDS.	CONCRETE	OTHER
76.16	4	15.48	10.92			180		

**Sampling Analysis
Project #19531**

0 - 3" Front and Back

Street/Number Address	A		A	
	PPM	No.	PPM	No.
	PPM	No.	PPM	No.

1413 Grand 1130 958

3 - 6" Front and Back

	B		B	
	PPM	No.	PPM	No.
	PPM	No.	PPM	No.

623 952

6 - 12" Front and Back

	C		C	
	PPM	No.	PPM	No.
	PPM	No.	PPM	No.

204 1260

	Depth	
	Excav.	(inch)


12

GR1415

GR1413

GR1405

GR1401

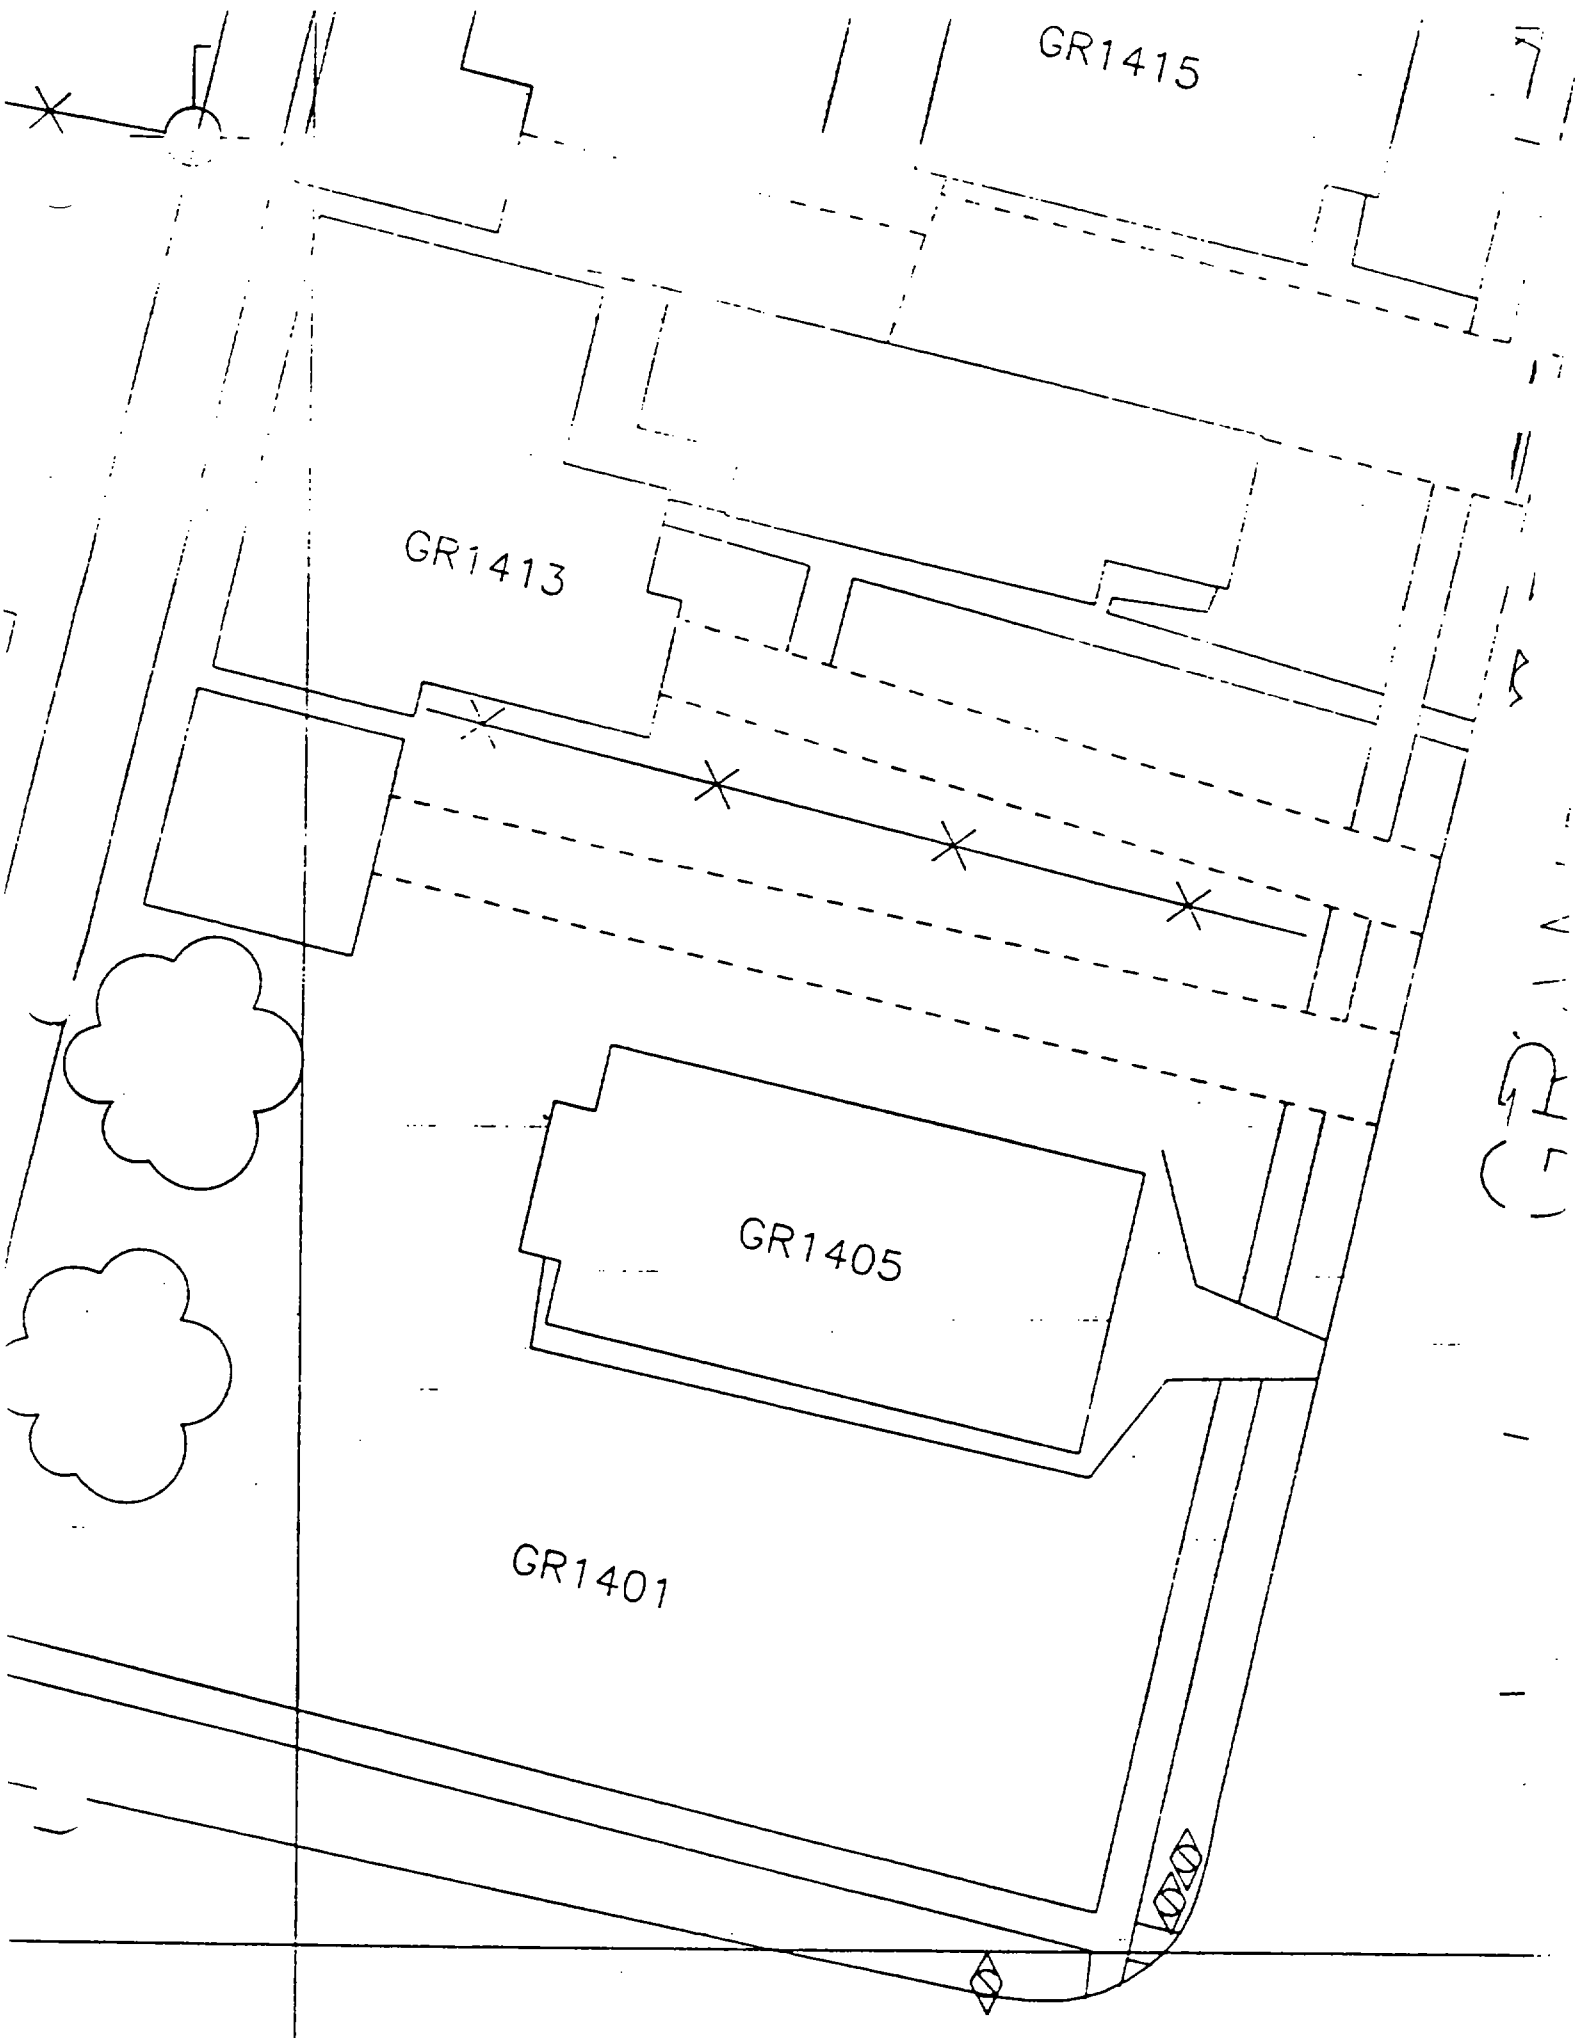

1

2

3

4

1417 Grand

Action Date: 11/12/97

Loadout: 11/14/97

Restoration Begins: 11/14/97

Restoration Completed: 11/19/97

*Stack emission sites were not sampled for verification due to the fact that a pre-determined depth for excavation was given to OHM by USACE.

*An excavation depth of 12 inches was established by USACE prior to work commencing.

*The excavation of special waste yielded a total of 45.9 cubic yards, which was shipped to WMI-Milam for disposal.

*Equipment utilized during excavation:

*TL-26

*TCM

*X331

*17-KW

*Subcontractors:

*WMI-landfill

*B. Garcia-trucking

*Grantham-trucking

*Emerald-turf farm

**OHM CORPORATION
PROJECT 1953I
GRANITE CITY, IL**

QUANTITY SUMMARY FOR

1417 Grand

SPECIAL WASTE (TONS)	BACKFILL (LOADS)	TOPSOIL (TONS)	CA-6 (TONS)	CA-7 (TONS)	SAND (TONS)	SOD CU.YDS.	CONCRETE	OTHER
59.67	4					180		

Sampling Analysis
Project #19531

0 - 3" Front and Back

Street/Number Address	A	
	PPM	PPM
	No.	No.

1417 Grand 1250 1070

3 - 6" Front and Back

	B	
	PPM	PPM
	No.	No.

1110 677


6 - 12" Front and Back

	C	
	PPM	PPM
	No.	No.

1070 254
708 314

Depth
Excav.
(inch)

12

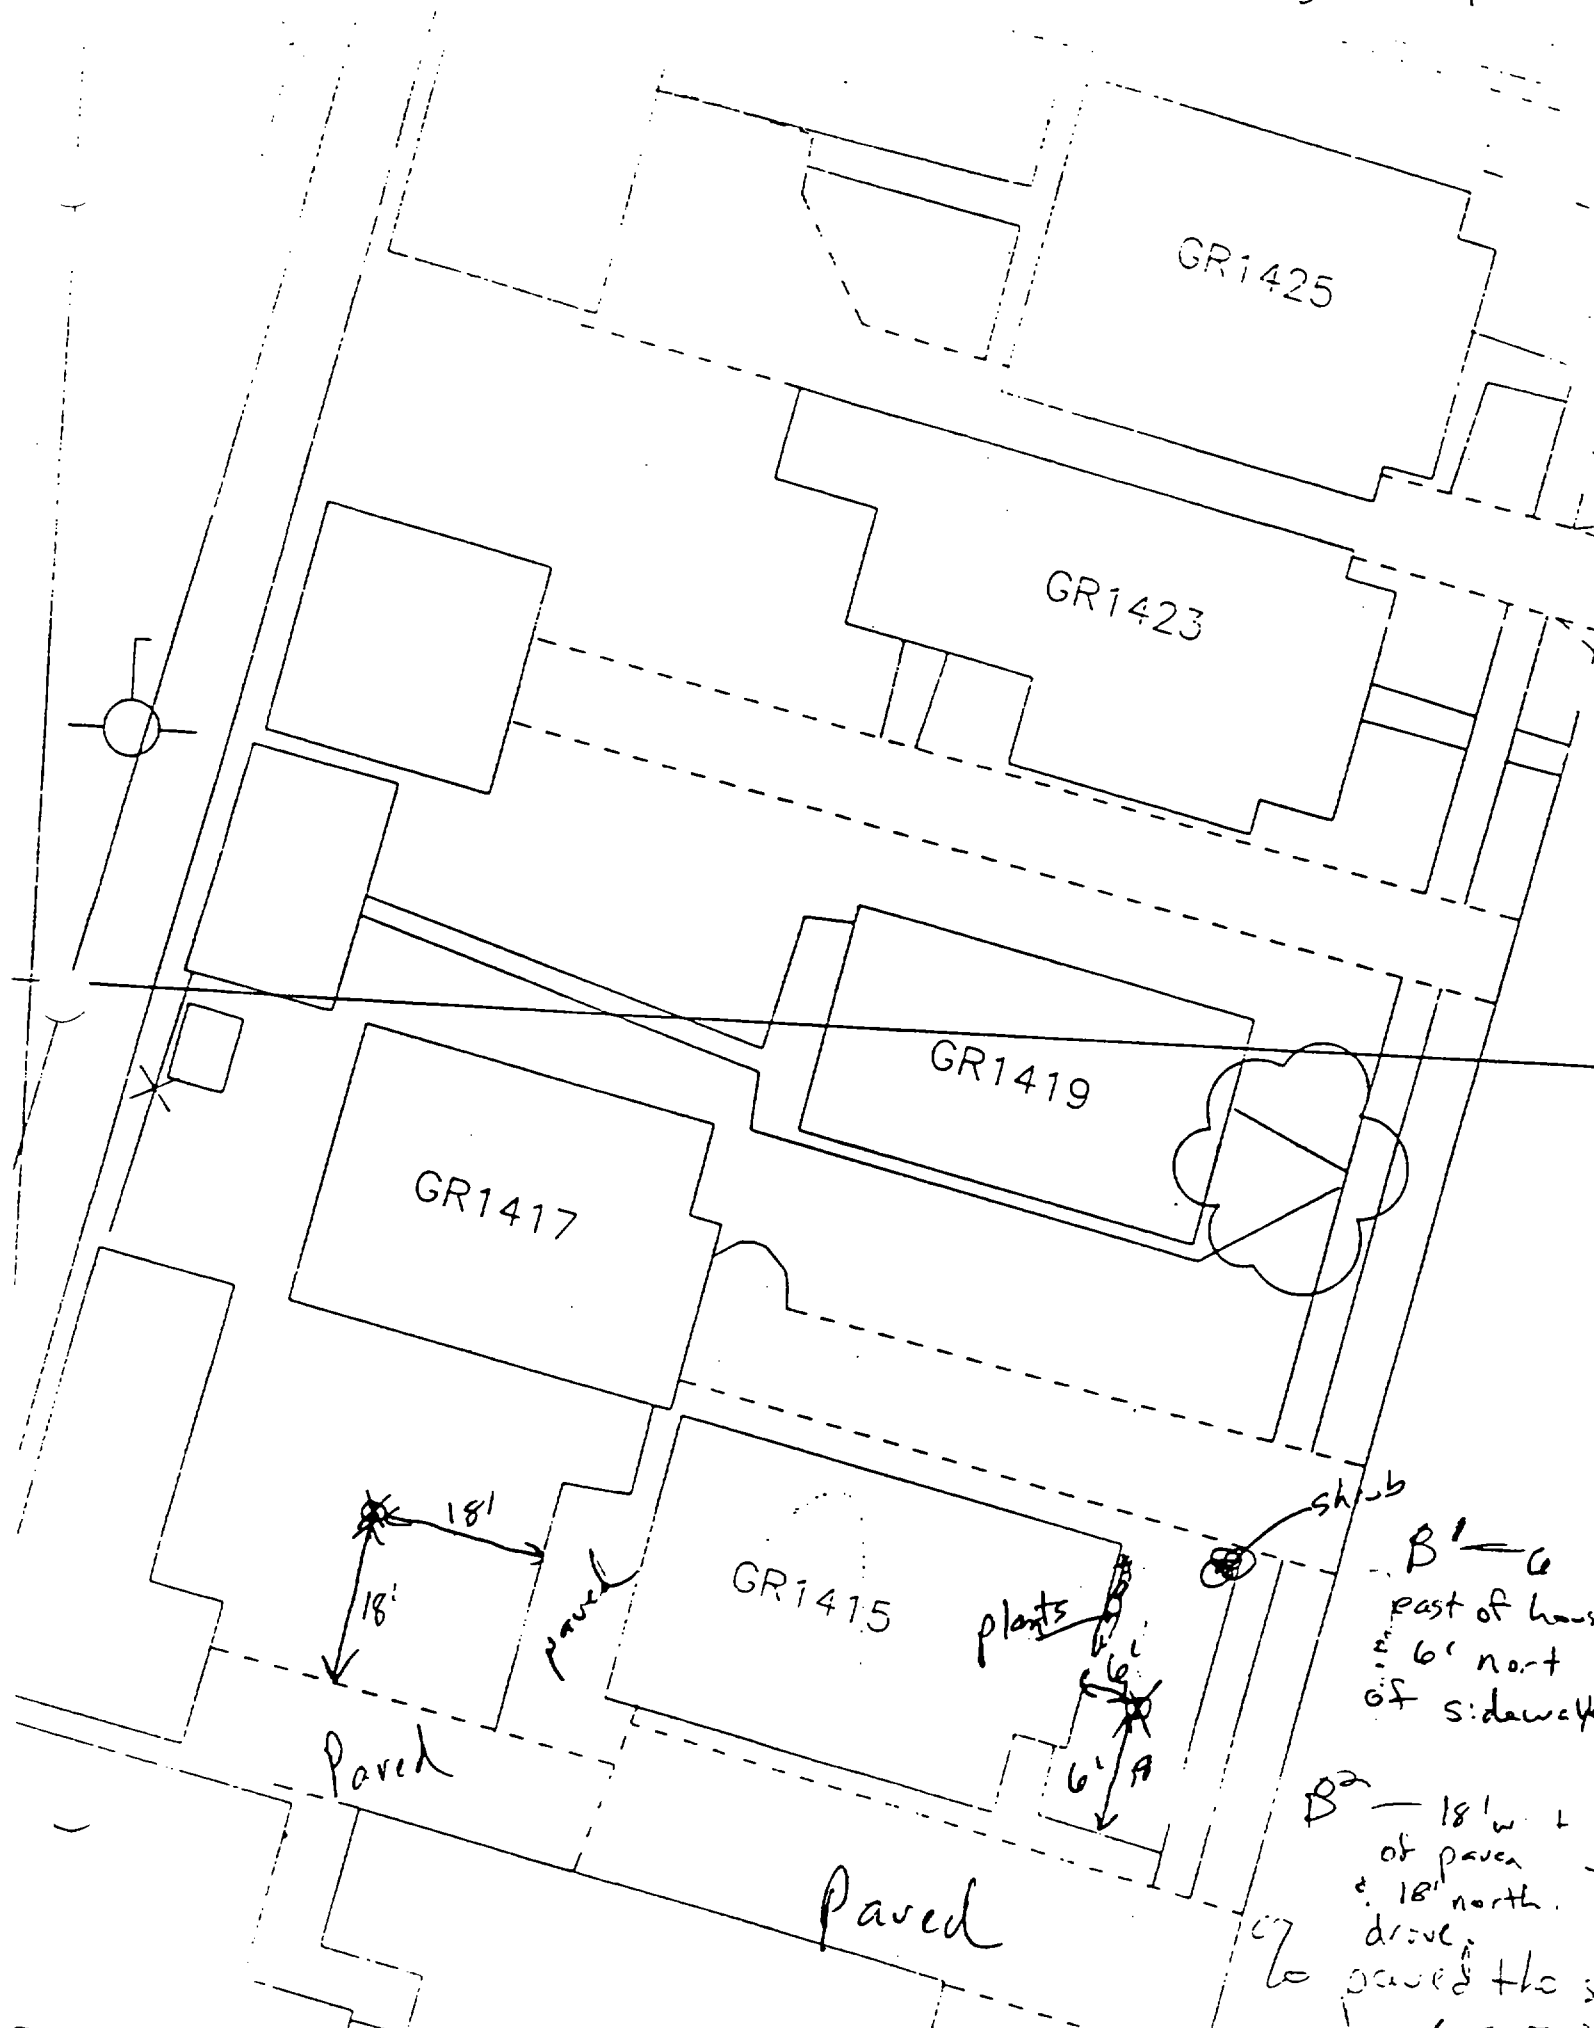

✓

✓

✓

✓

1427 Grand

Action Date: 3/20/97

Loadout: 3/21/97

Restoration Begins: 3/21/97

Restoration Completed: 4/4/97

*Stack emission sites were not sampled for verification due to the fact that a pre-determined depth for excavation was given to OHM by USACE.

*An excavation depth of 12 inches was established by USACE prior to work commencing.

*The excavation of special waste yielded a total of 27.23 cubic yards, which was shipped to WMI-Milam for disposal.

*Equipment utilized during excavation:

*TL-26 *TCM

*X331

*17-KW

*Subcontractors:

*WMI-landfill

*B. Garcia-trucking

*Granthum-trucking

*Pedigo Sod Farm

OHM CORPORATION
PROJECT 19531
GRANITE CITY, IL

QUANTITY SUMMARY FOR 1427 Grand

SPECIAL WASTE (TONS)	BACKFILL (LOADS)	TOPSOIL (TONS)	CA-6 (TONS)	CA-7 (TONS)	SAND (TONS)	SOD CU.YDS.	CONCRETE	OTHER
35.4	2		10.92			63		

Sampling Analysis
Project #19531

Street/Number Address	0 - 3" Front and Back			3 - 6" Front and Back			6 - 12" Front and Back			Depth	
	A		A	B		B	C		C	Excav. (inch)	
	PPM	No.	PPM	No.	PPM	No.	PPM	No.	PPM		
1427 Grand	2200	2300	6710	580	1600	1470	600	720	329	12	
	352	476	1170	409	1420	488	253	605	107		

GR1437

Boring #1
9 ft E of House
5 ft N of Drive

Boring #2
29 ft W of House
7 ft N of Sidewalk

GR1431

GR1429

GR1427

Paved Driveway

80% House & Paved

~~GR1425~~
GR1424

GR1423

Paved

#2

29'

17'

Paved Driveway

AC Units

Flower Bed

9' #1
15'

Paved Driveway

1447 Grand

Action Date: 3/22/97

Loadout: 3/24/97

Restoration Begins: 3/24/97

Restoration Completed: 4/4/97

*Stack emission sites were not sampled for verification due to the fact that a pre-determined depth for excavation was given to OHM by USACE.

*An excavation depth of 12 inches was established by USACE prior to work commencing.

*The excavation of special waste yielded a total of 249.69 cubic yards, which was shipped to WMI-Milam for disposal.

*Equipment utilized during excavation:

*TL-26

*X331

*17-KW

*Subcontractors:

*WMI-landfill

*B. Garcia-trucking

*Granthum-trucking

*Pedigo Sod Farm

EASEMENT INFORMATION

This easement was completed after the Temporary Restraining Order (TRO) was lifted.

OHM CORPORATION
PROJECT 19531
GRANITE CITY, IL

QUANTITY SUMMARY FOR 1447 Grand

SPECIAL WASTE (TONS)	BACKFILL (LOADS)	TOPSOIL (TONS)	CA-6 (TONS)	CA-7 (TONS)	SAND (TONS)	SOD CU.YDS.	CONCRETE	OTHER
324.6	17	121.35	14.69	58.66		945		

**Sampling Analysis
Project #19531**

0 - 3" Front and Back

Street/Number Address	A	
	PPM	PPM
	No.	No.

3 - 6" Front and Back

	B	
	PPM	PPM
	No.	No.

6 - 12" Front and Back

	C	
	PPM	PPM
	No.	No.

Depth Excav. (inch)

1447 Grand 1400 1600

910 1500


550 1600

12

1 VTH

GR1447

GR1443

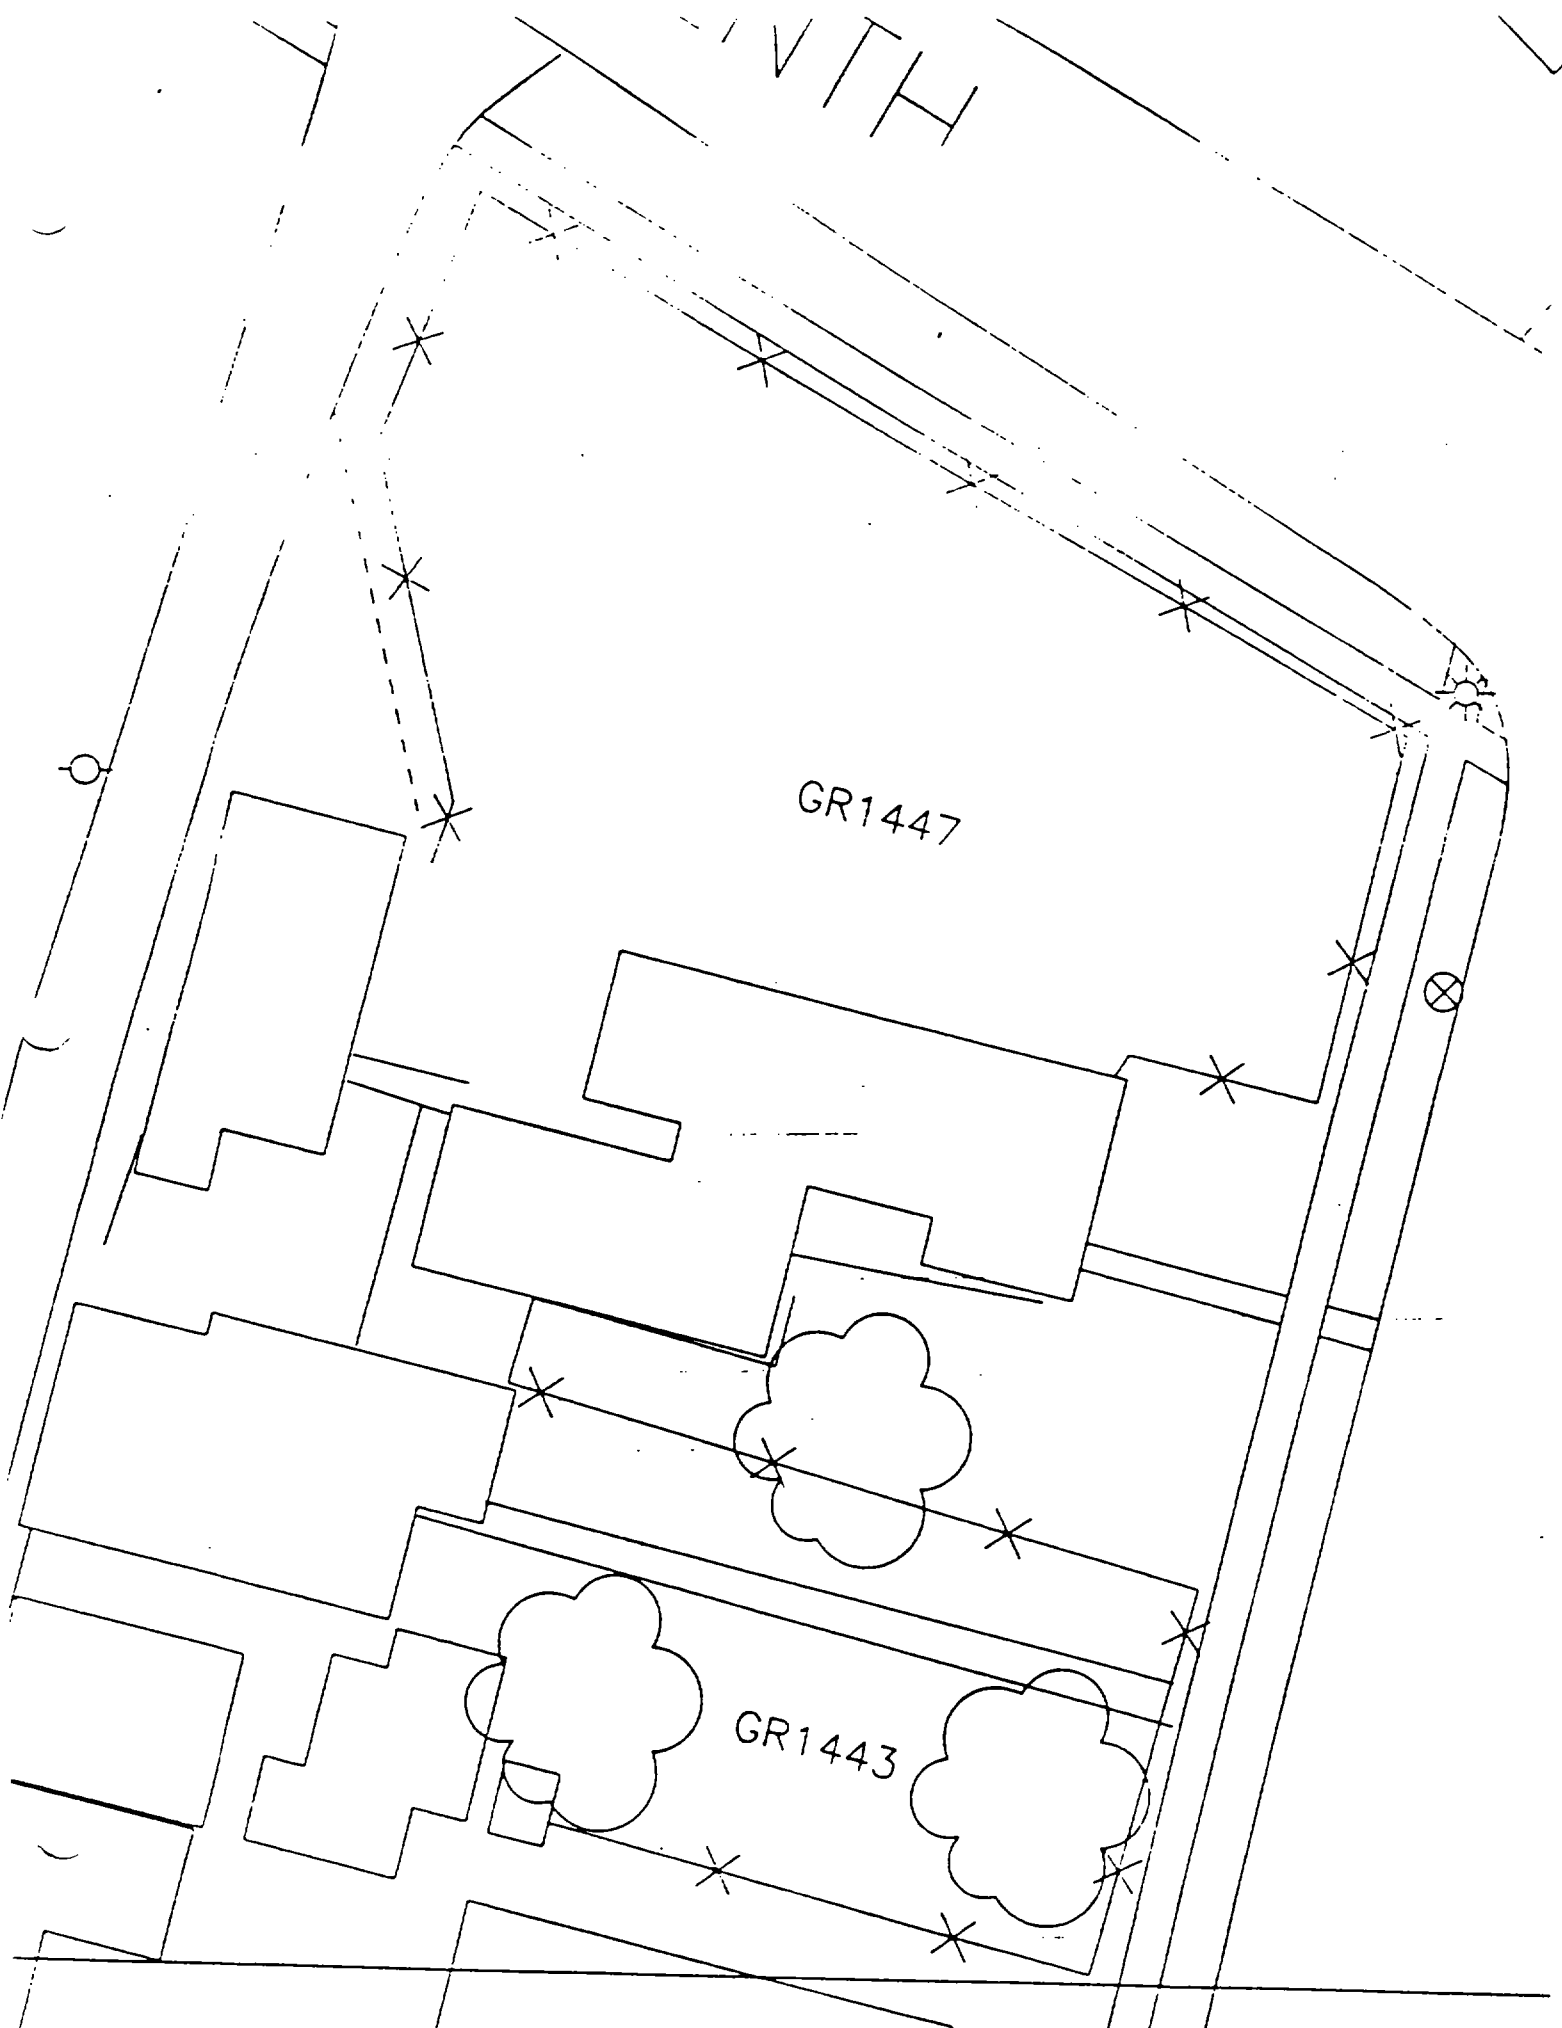

✓

✓

✓

Action Date: 6/30/97

✓ Loadout: 7/1/97

Restoration Begins: 7/2/97

Restoration Completed: 7/25/97

*Stack emission sites were not sampled for verification due to the fact that a pre-determined depth for excavation was given to OHM by USACE.

*An excavation depth of 12 inches was established by USACE prior to work commencing.

*The excavation of special waste yielded a total of 122.98 cubic yards, which was shipped to WMI-Milam for disposal.

*Equipment utilized during excavation:

*TL-26

*TCM

*X331

*17-KW

*Subcontractors:

*WMI-landfill

*B. Garcia-trucking

*Grantham-trucking

*Schneider-turf farm

**OHM CORPORATION
PROJECT 19531
GRANITE CITY, IL**

QUANTITY SUMMARY FOR

1728/30 Grand

SPECIAL WASTE (TONS)	BACKFILL (LOADS)	TOPSOIL (TONS)	CA-6 (TONS)	CA-7 (TONS)	SAND (TONS)	SOD CU.YDS.	CONCRETE	OTHER
159.88	10	47.6	14.8			444.5		

Sampling Analysis
Project #19531


0 - 3" Front and Back			
A	A	A	A
Street/Number	PPM	PPM	PPM
Address	No.	No.	No.

3 - 6" Front and Back			
B	B	B	B
PPM	PPM	PPM	PPM
No.	No.	No.	No.

6 - 12" Front and Back			
C	C	C	C
PPM	PPM	PPM	PPM
No.	No.	No.	No.

Depth
Excav.
(inch)

1728 Grand 1778 2892 2319 279 1155 1331 12

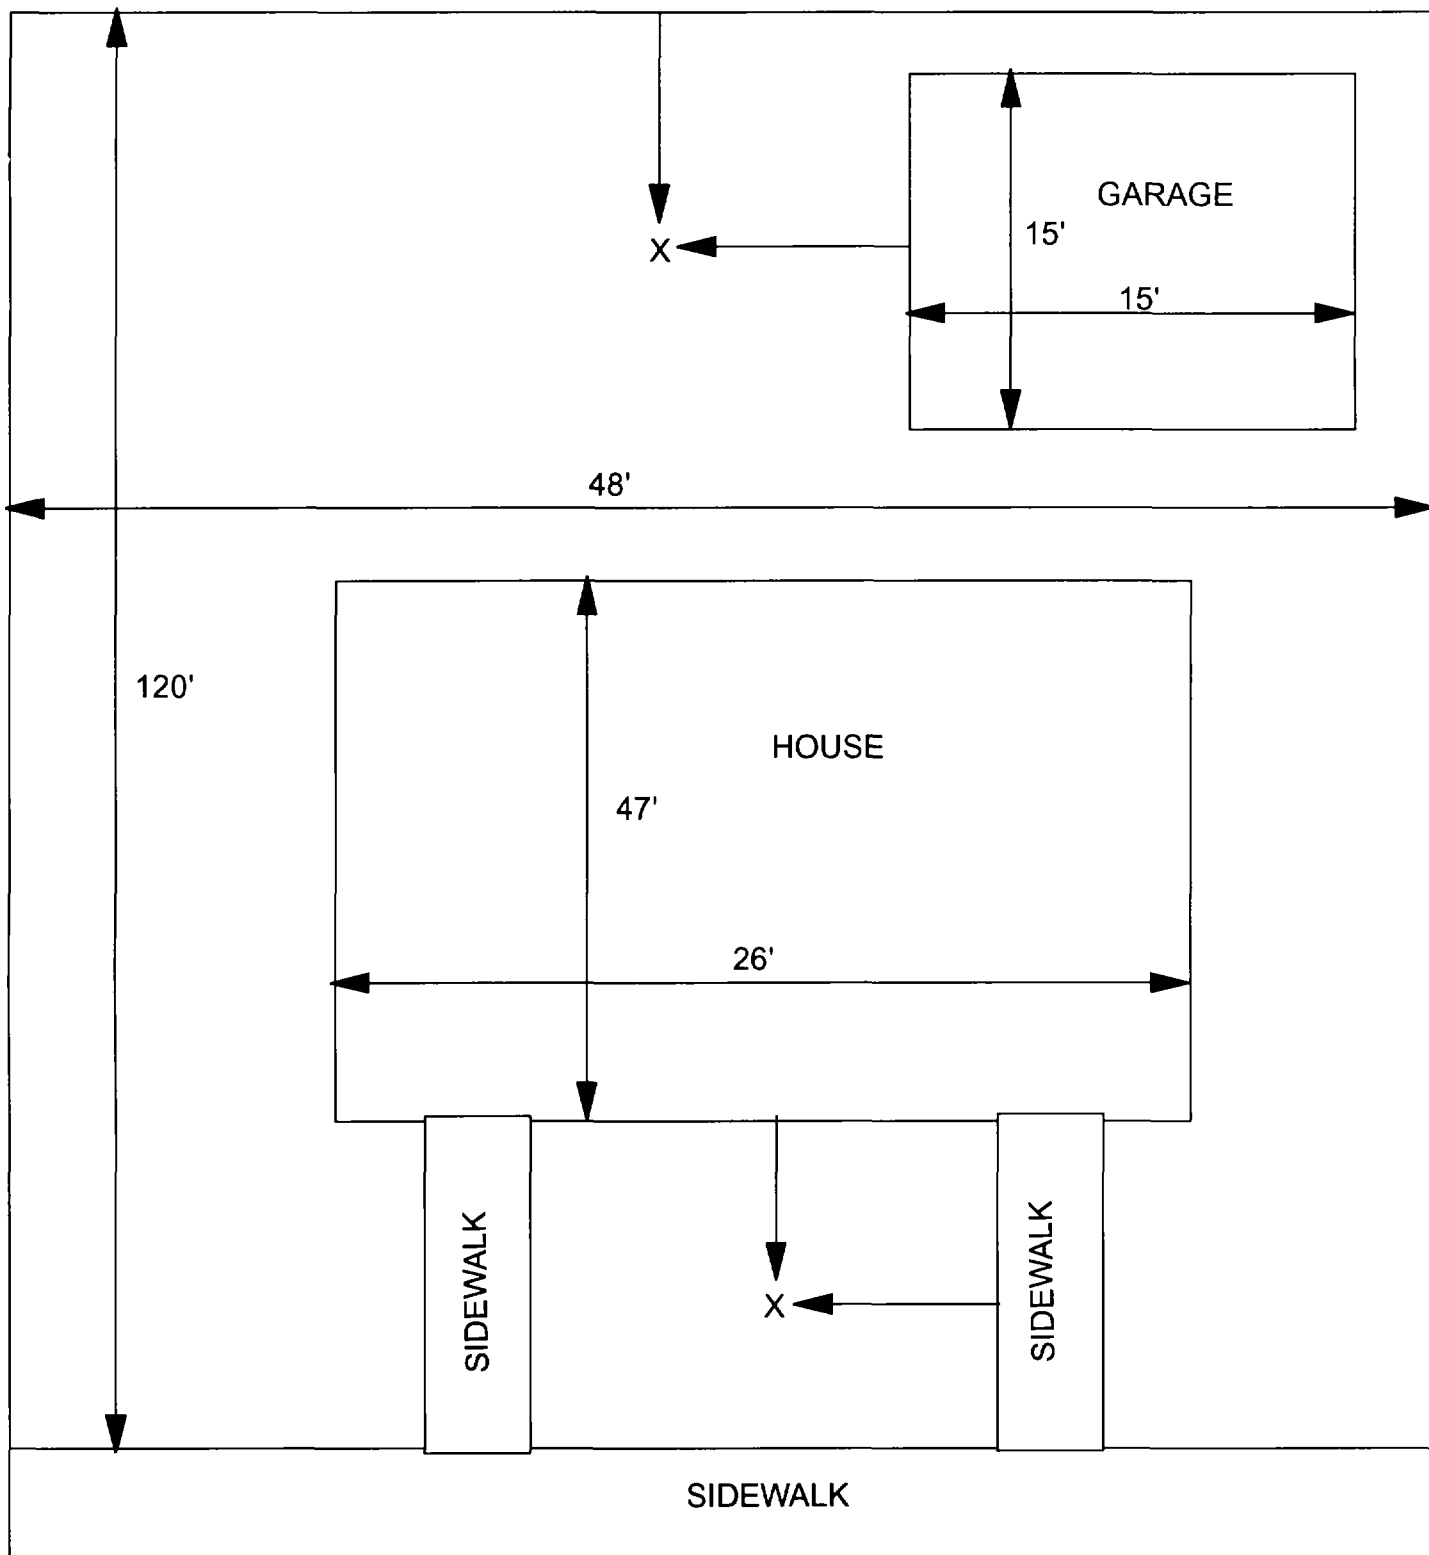

X = SAMPLE POINT

1728/30 GRAND
48' X 120'

OHM 
Corporation
Findlay, Ohio

Drawn By: **EDJ**

Checked By:

Date: **7/29/98**

Approved By:

Scale: **NTS**

Drawing No:

✓

✓

✓

1734 Grand

Action Date: 7/7/97

Loadout: 7/9/97

Restoration Begins: 7/9/97

Restoration Completed: 7/28/97

*Stack emission sites were not sampled for verification due to the fact that a pre-determined depth for excavation was given to OHM by USACE.

*An excavation depth of 12 inches was established by USACE prior to work commencing.

*The excavation of special waste yielded a total of 140.36 cubic yards, which was shipped to WMI-Milam for disposal.

*Equipment utilized during excavation:

*TL-26

*TCM

*X331

*17-KW

*Subcontractors:

*WMI-landfill

*B. Garcia-trucking

*Grantham-trucking

*Schneider-turf farm

**OHM CORPORATION
PROJECT 19531
GRANITE CITY, IL**


QUANTITY SUMMARY FOR

1734 Grand

SPECIAL WASTE (TONS)	BACKFILL (LOADS)	TOPSOIL (TONS)	CA-6 (TONS)	CA-7 (TONS)	SAND (TONS)	SOD CU.YDS.	CONCRETE	OTHER
182.47	5	53.66	153.2	14		190.5		

**Sampling Analysis
Project #19531**

Street/Number Address	0 - 3" Front and Back				3-6" Front and Back				6-12" Front and Back				Depth Excav. (inch)
	A	A	A	A	B	B	B	B	C	C	C	C	
	PPM	PPM	PPM	PPM	PPM	PPM	PPM	PPM	PPM	PPM	PPM	PPM	
	No.	No.	No.	No.	No.	No.	No.	No.	No.	No.	No.	No.	
1734 Grand	1240	1070	814		1470	950	1250		1330	894	1110		12

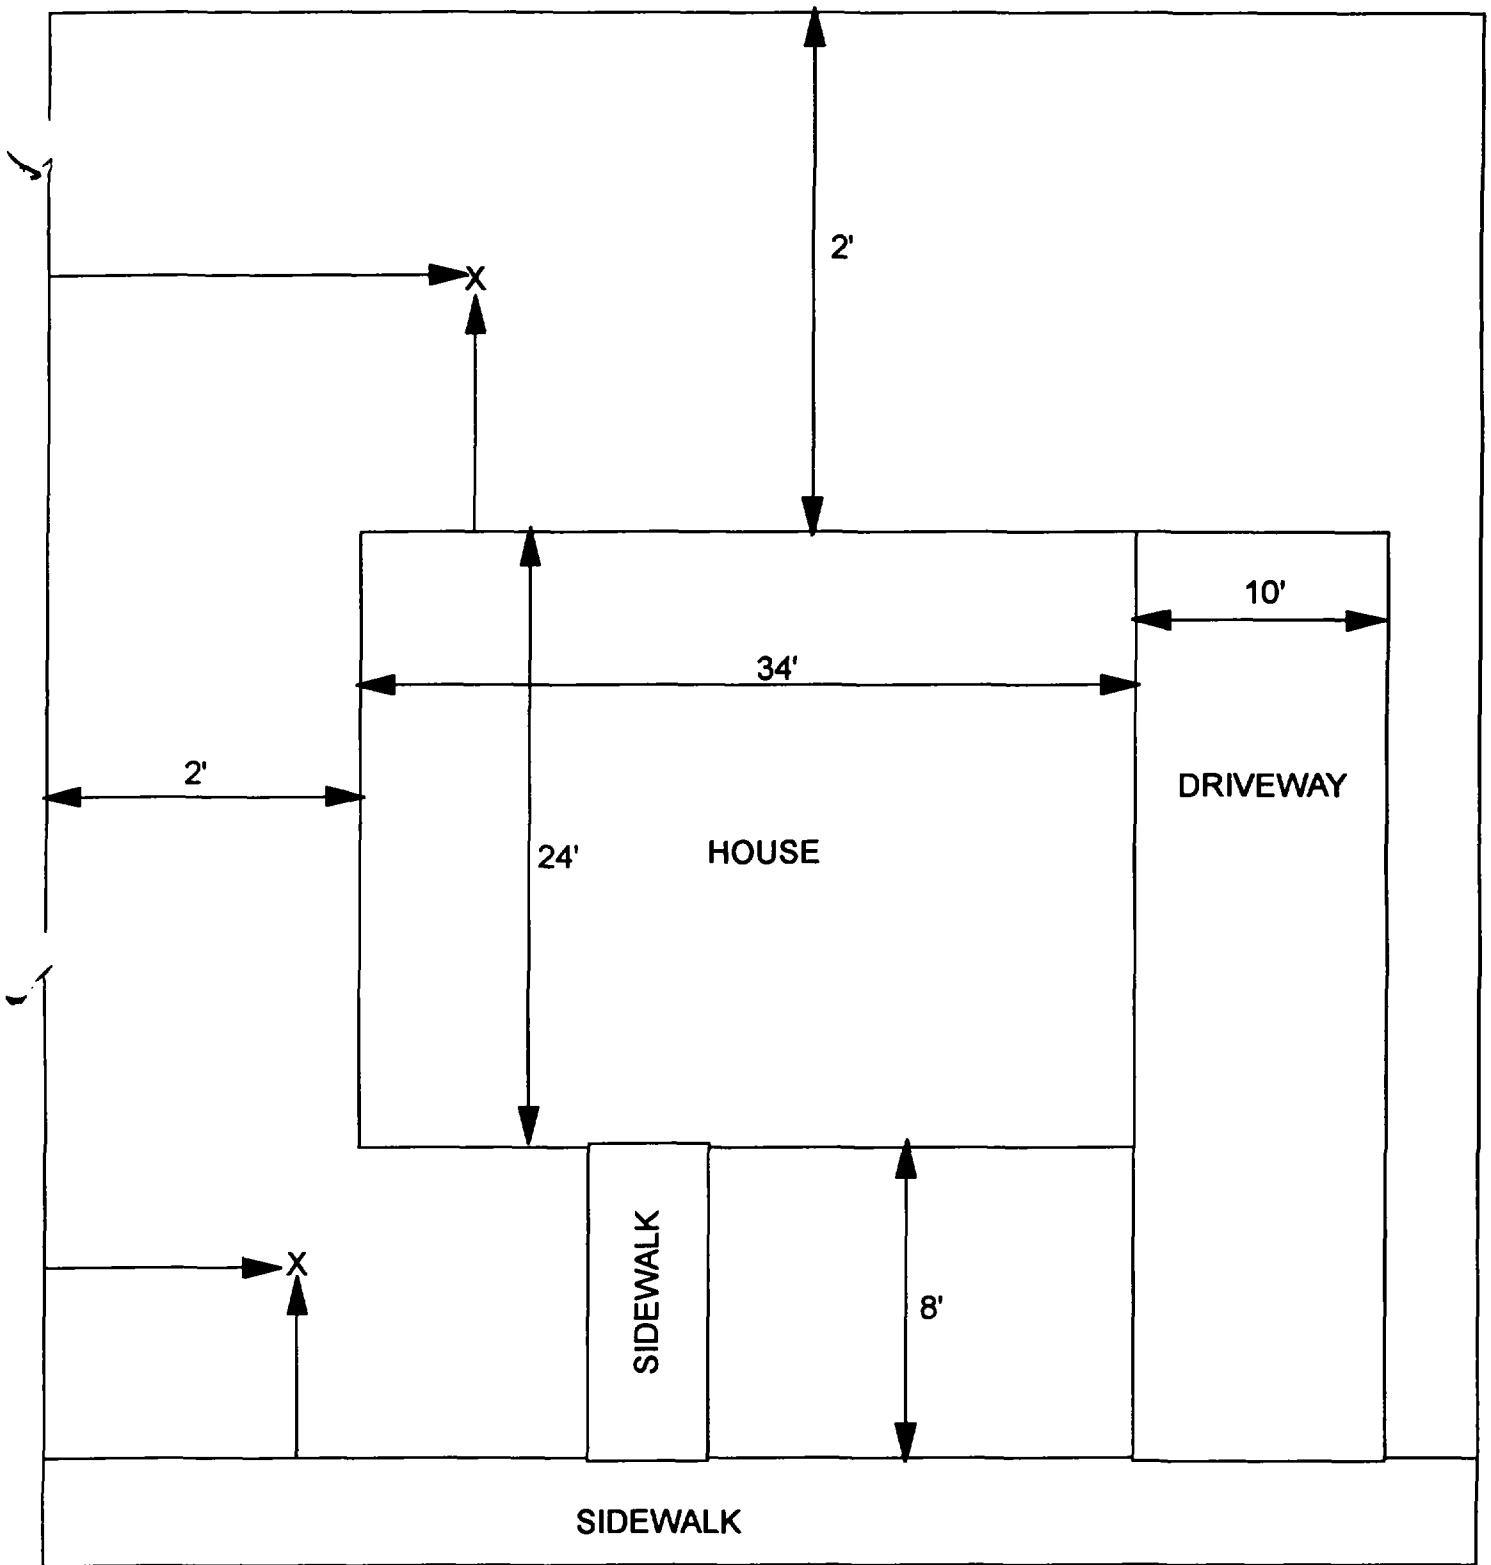

X - SAMPLE POINT

1734 GRAND
46' X 34'

OHM Corporation
Findley, Ohio

Drawn By: EDJ	Checked By:
Date: 10/14/98	Approved By:
Scale: NTS	Drawing No:

✓

✓

✓

1918/20 Grand

Action Date: 3/29/97

Loadout: 3/31/97

Restoration Begins: 4/1/97

Restoration Completed: 4/25/97

*Stack emission sites were not sampled for verification due to the fact that a pre-determined depth for excavation was given to OHM by USACE.

*An excavation depth of 6 inches was established by USACE prior to work commencing.

*The excavation of special waste yielded a total of 74.90 cubic yards, which was shipped to WMI-Milam for disposal.

*Equipment utilized during excavation:

*TL-26

*TCM

*X331

*17-KW

*Subcontractors:

*WMI-landfill

*B. Garcia-trucking

*Granthum-trucking

*Schneider Turf Farm

EASEMENT INFORMATION

This easement was completed after the Temporary Restraining Order (TRO) was lifted.

OHM CORPORATION
PROJECT 19531
GRANITE CITY, IL

QUANTITY SUMMARY FOR 1918/20 Grand

SPECIAL WASTE (TONS)	BACKFILL (LOADS)	TOPSOIL (TONS)	CA-6 (TONS)	CA-7 (TONS)	SAND (TONS)	SOD CU.YDS.	CONCRETE	OTHER
97.37	4	15.11				300		

Sampling Analysis
Project #19531

0 - 3" Front and Back

Street/Number Address	A		A	
	PPM	No.	PPM	No.

3 - 6" Front and Back

	B		B	
	PPM	No.	PPM	No.

6 - 12" Front and Back

	C		C	
	PPM	No.	PPM	No.


Depth Excav. (inch)

1918/20 Grand 628 655

419 524

219 346

6

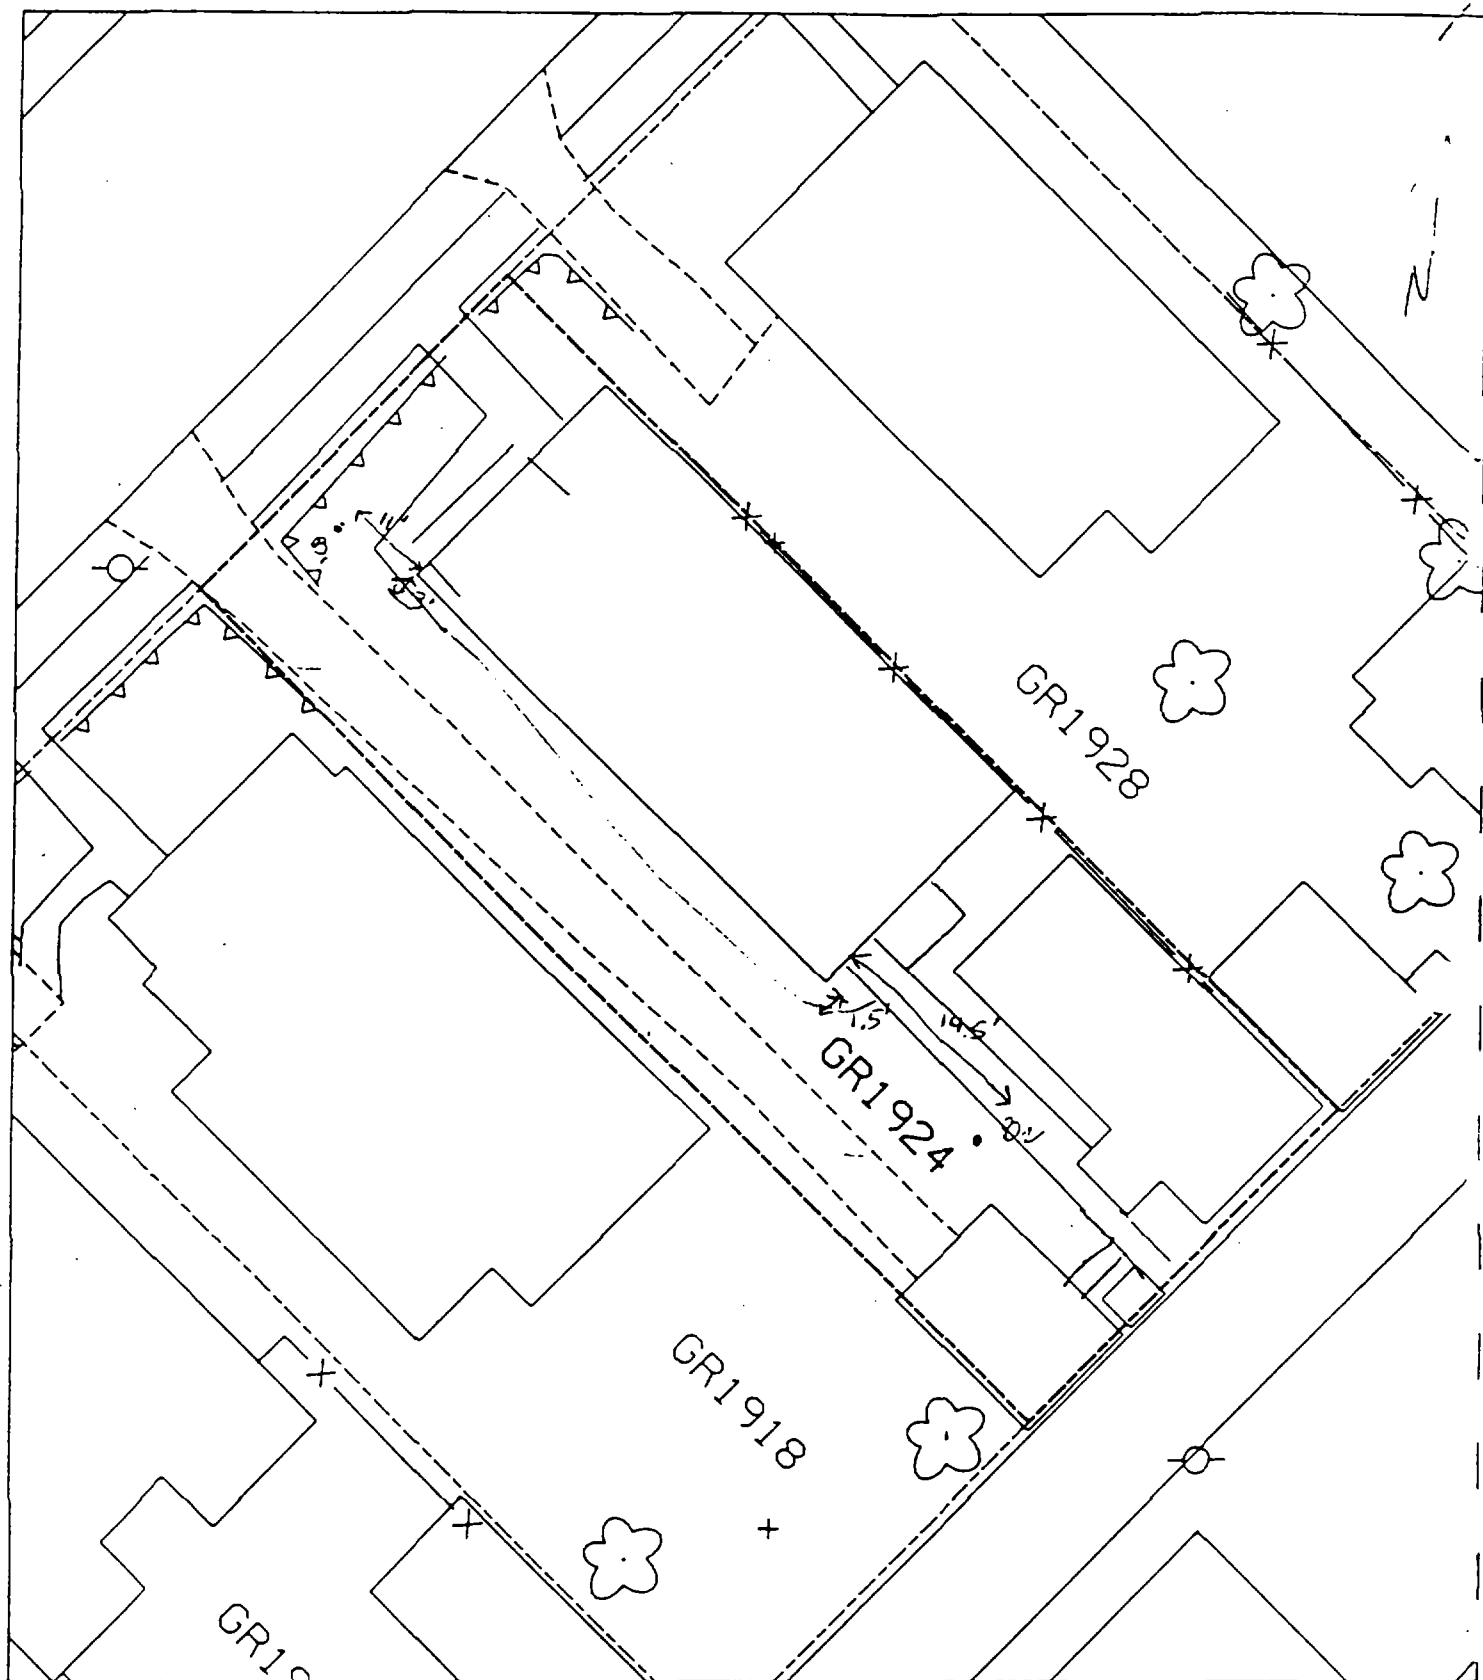

B_1 = 3 FT SOUTHWEST OF SW HOUSE CORNER
AND 11 FT NW OF SW HOUSE CORNER

B_2 IS 14.5 FT SE OF SE HOUSE CORNER
AND 1.5 FT SW OF SE HOUSE CORNER

—

—

—

1924 Grand

Action Date: 4/3/97

Loadout: 4/4/97

Restoration Begins: 4/4/97

Restoration Completed: 4/25/97

*Stack emission sites were not sampled for verification due to the fact that a pre-determined depth for excavation was given to OHM by USACE.

*An excavation depth of 3 inches was established by USACE prior to work commencing.

*The excavation of special waste yielded a total of 47.22 cubic yards, which was shipped to WMI-Milam for disposal.

*Equipment utilized during excavation:

*TL-26

*TCM

*X331

*17-KW

*Subcontractors:

*WMI-landfill

*B. Garcia-trucking

*Granthum-trucking

*Schneider Turf Farm

EASEMENT INFORMATION

This easement was completed after the Temporary Restraining Order (TRO) was lifted.

OHM CORPORATION
PROJECT 19531
GRANITE CITY, IL

QUANTITY SUMMARY FOR 1924 Grand

SPECIAL WASTE (TONS)	BACKFILL (LOADS)	TOPSOIL (TONS)	CA-6 (TONS)	CA-7 (TONS)	SAND (TONS)	SOD CU.YDS.	CONCRETE	OTHER
61.39		21.29	16.4	13.85		180		

**Sampling Analysis
Project #19531**

0 - 3" Front and Back

Street/Number Address	A		A	
	PPM	No.	PPM	No.
1924 Grand	650	993		

3 - 6" Front and Back

	B		B	
	PPM	No.	PPM	No.

6 - 12" Front and Back


	C		C	
	PPM	No.	PPM	No.

Depth	
Excav.	
(inch)	

3

243 316

498 489

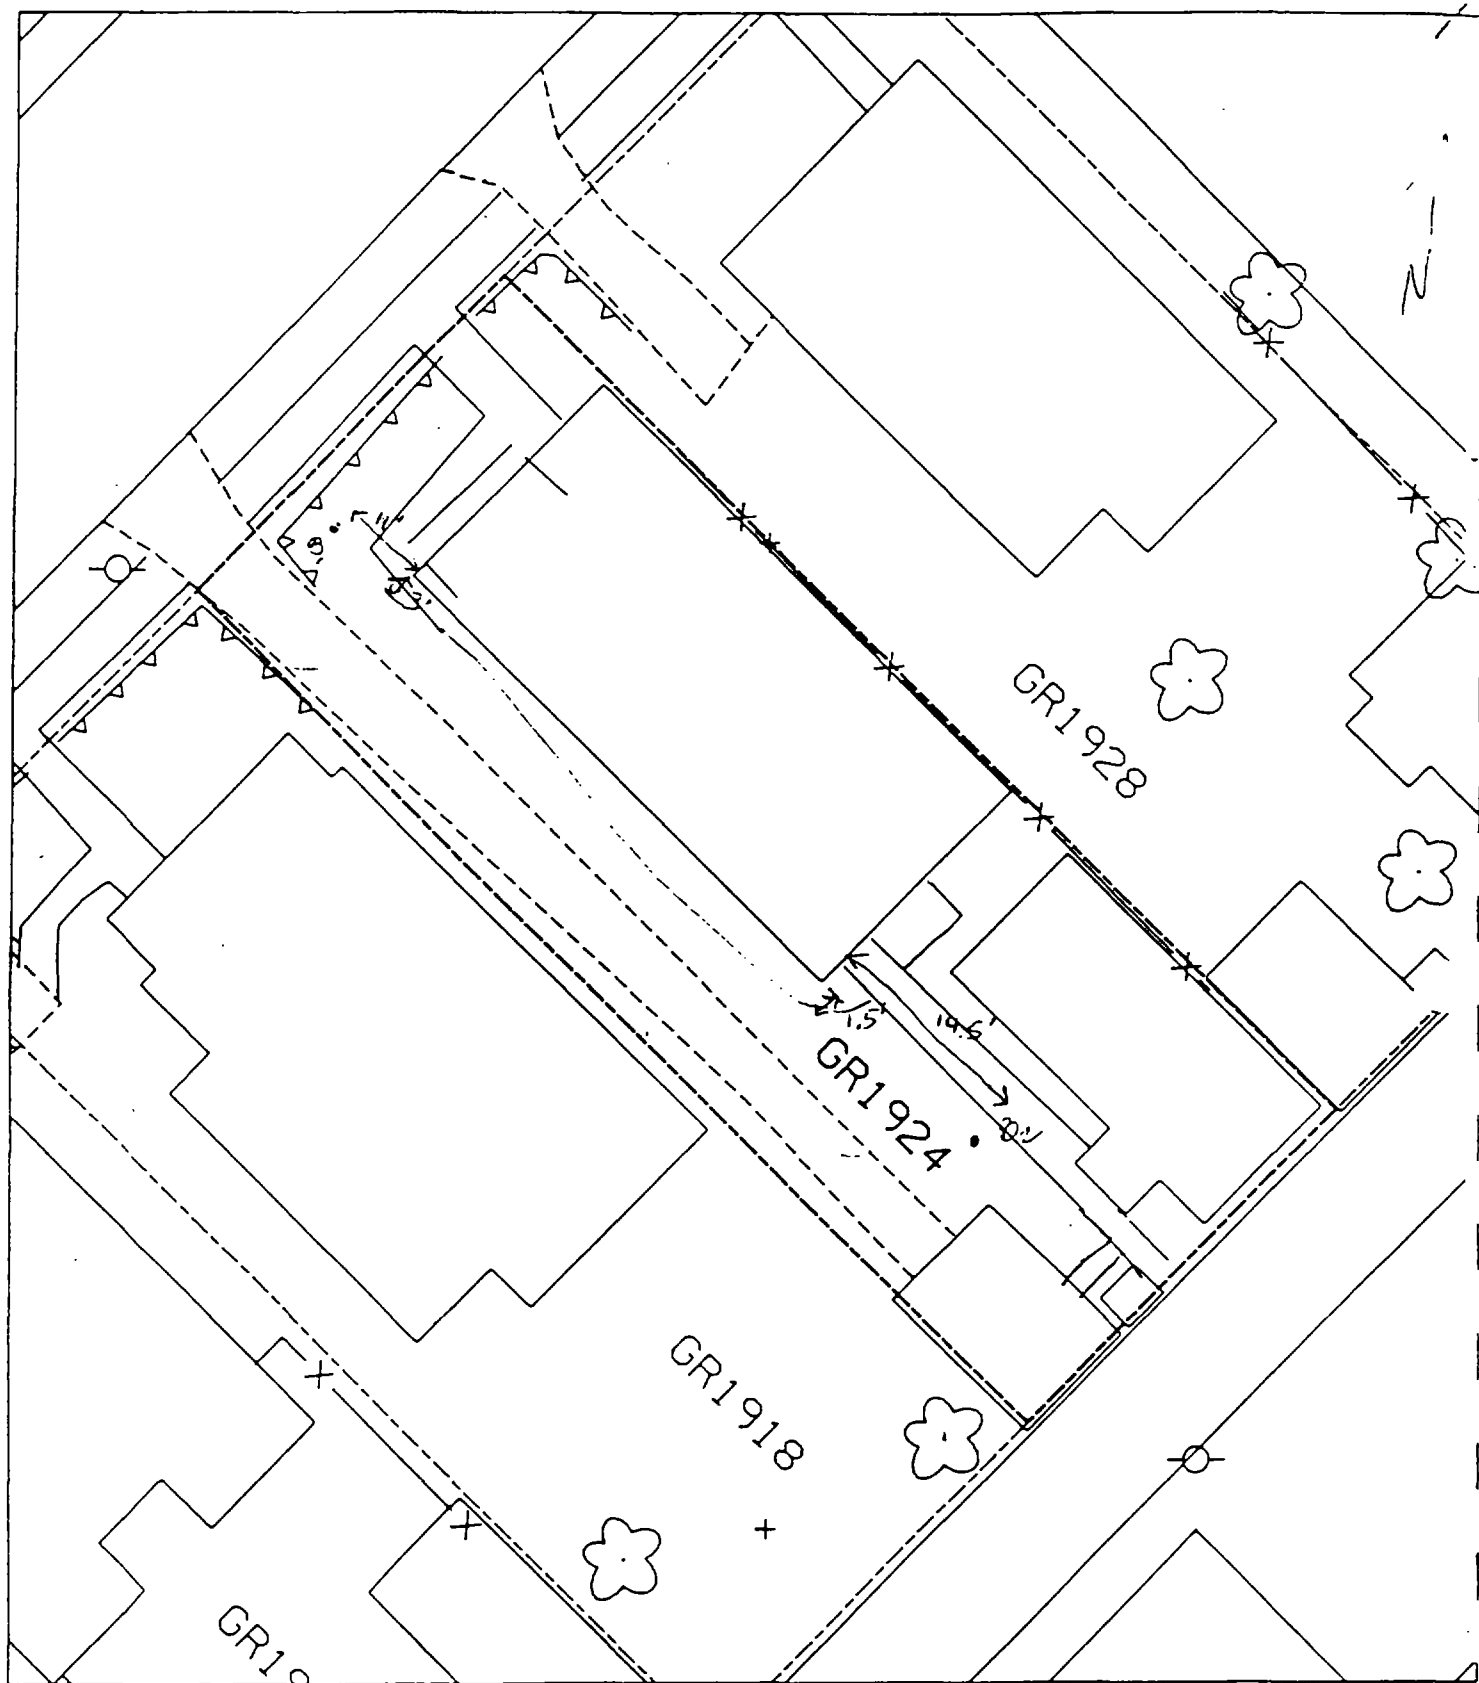

$B_1 = 3 \text{ FT SOUTH WEST OF SW HOUSE CORNER}$

AND 11 FT NW OF SW HOUSE CORNER

B_2 IS 14.5 FT SE OF SE HOUSE CORNER

AND 1.5 FT SW OF SE HOUSE CORNER

)

)

)

1928 Grand

Action Date: 12/1/97

Loadout: 12/2/97

Restoration Begins: 12/4/97

Restoration Completed: 12/20/97

*Stack emission sites were not sampled for verification due to the fact that a pre-determined depth for excavation was given to OHM by USACE.

*An excavation depth of 3 inches was established by USACE prior to work commencing.

*The excavation of special waste yielded a total of 41.23 cubic yards, which was shipped to WMI-Milam for disposal.

*Equipment utilized during excavation:

*TL-26

*TCM

*X331

*17-KW

*Subcontractors:

*WMI-landfill

*B. Garcia-trucking

*Grantham-trucking

*Emerald-turf farm

**OHM CORPORATION
PROJECT 19531
GRANITE CITY, IL**

QUANTITY SUMMARY FOR

1928 Grand

SPECIAL WASTE (TONS)	BACKFILL (LOADS)	TOPSOIL (TONS)	CA-6 (TONS)	CA-7 (TONS)	SAND (TONS)	SOD CU.YDS.	CONCRETE	OTHER
53.61	3	15.75		15.15		423		

Sampling Analysis
Project #19531

0 - 3" Front and Back

	A	A	A
Street/Number	PPM	PPM	PPM
Address	No.	No.	No.

1928 Grand 656 747

3 - 6" Front and Back

B	B	B
PPM	PPM	PPM
No.	No.	No.

302 96


6 - 12" Front and Back

C	C	C
PPM	PPM	PPM
No.	No.	No.

72 105

Depth
Excav.
(inch)

3

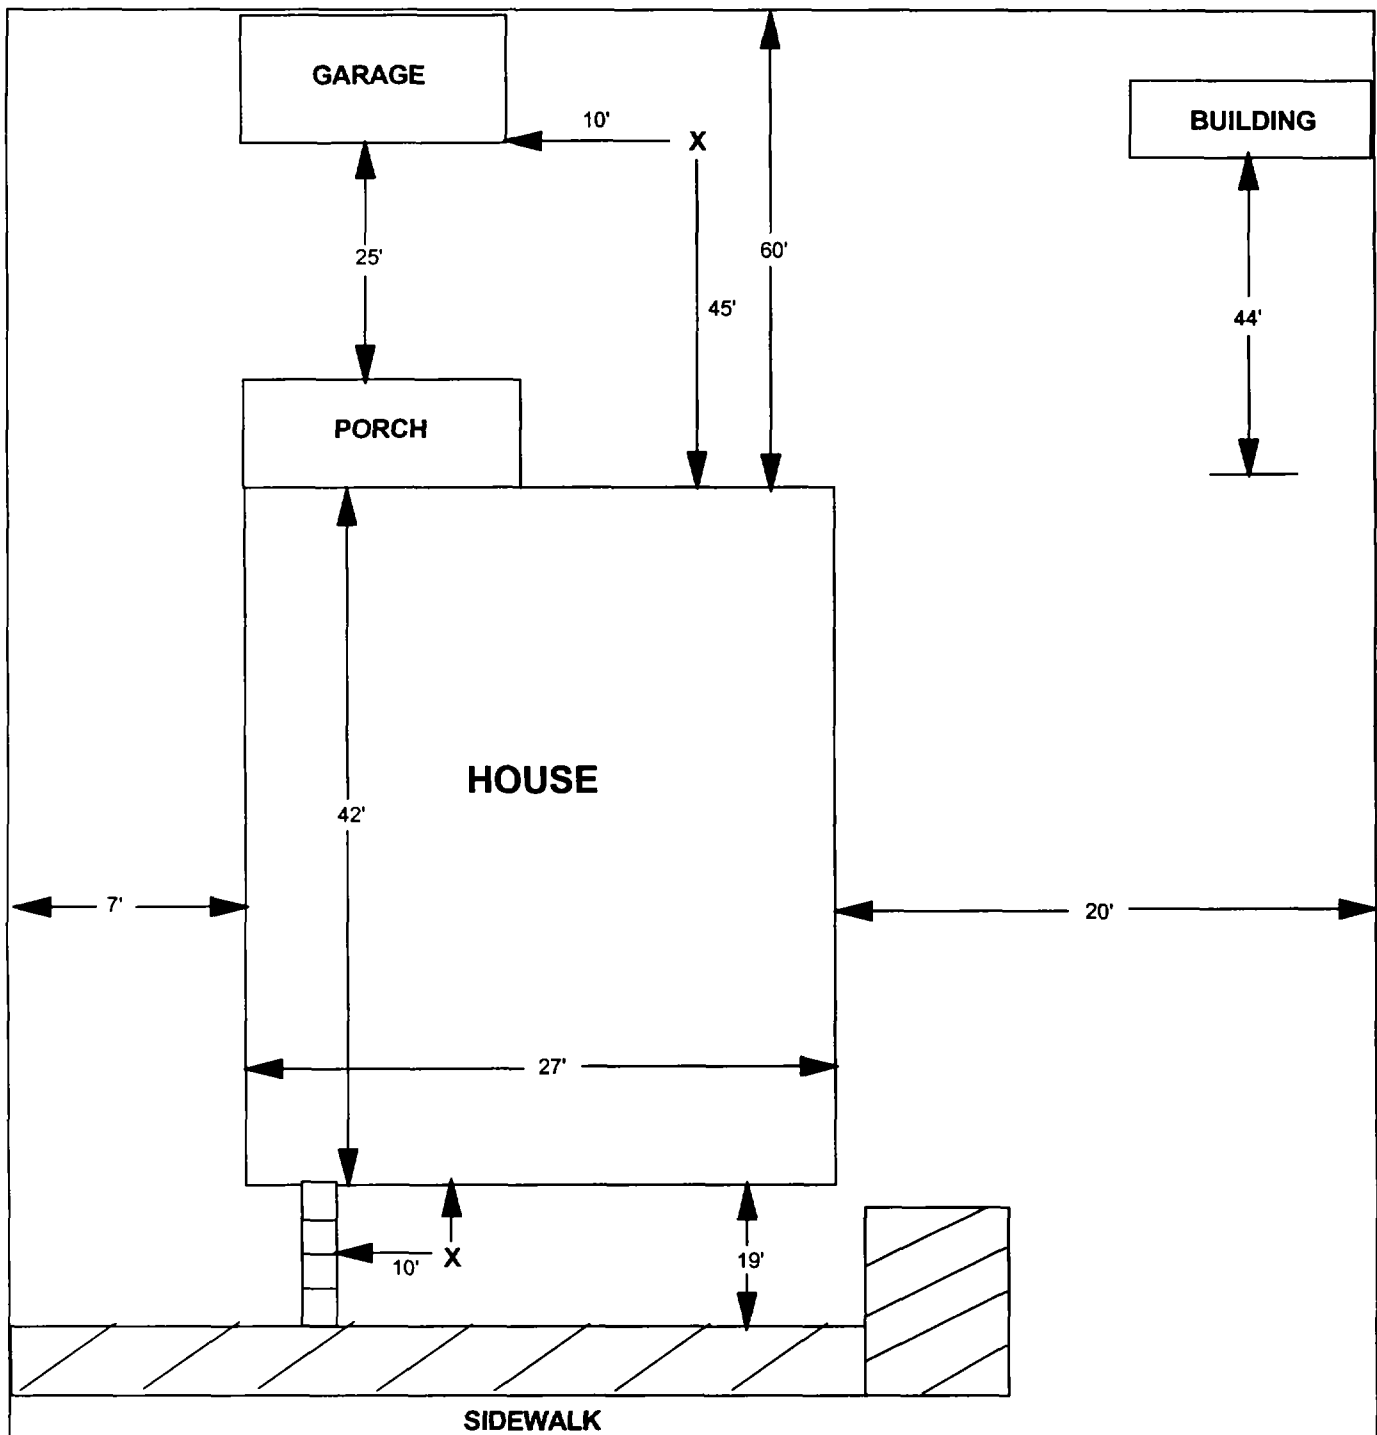

X = SAMPLE POINT

1928 GRAND

**TOTAL
DIMENSIONS
121'X54'**

OHM 
Corporation
Findlay, Ohio

Drawn By: **JG** Checked By:

Date: 8/19/98 Approved By:

Scale: **NTS** Drawing No:

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1932/34 Grand

Action Date: 12/5/97

Loadout: 12/8/97

Restoration Begins: 12/8/97

Restoration Completed: 12/20/97

*Stack emission sites were not sampled for verification due to the fact that a pre-determined depth for excavation was given to OHM by USACE.

*An excavation depth of 3 inches was established by USACE prior to work commencing.

*The excavation of special waste yielded a total of 43.28 cubic yards, which was shipped to WMI-Milam for disposal.

*Equipment utilized during excavation:

*TL-26

*TCM

*X331

*17-KW

*Subcontractors:

*WMI-landfill

*B. Garcia-trucking

*Grantham-trucking

*Emerald-turf farm

**OHM CORPORATION
PROJECT 19531
GRANITE CITY, IL**

QUANTITY SUMMARY FOR

1932/34 Grand

SPECIAL WASTE (TONS)	BACKFILL (LOADS)	TOPSOIL (TONS)	CA-6 (TONS)	CA-7 (TONS)	SAND (TONS)	SOD CU.YDS.	CONCRETE	OTHER
56.27		14.36	30.15	45.65		164		

**Sampling Analysis
Project #19531**

0 - 3" Front and Back

Street/Number Address	A		A	
	PPM	No.	PPM	No.
1932/34 Grand	618		604	


3 - 6" Front and Back

B	B		B	
	PPM	No.	PPM	No.
		366		467

6 - 12" Front and Back

C	C		C	
	PPM	No.	PPM	No.
		646		184
		199		368
		202		109

Depth	
Excav.	
(inch)	
3	

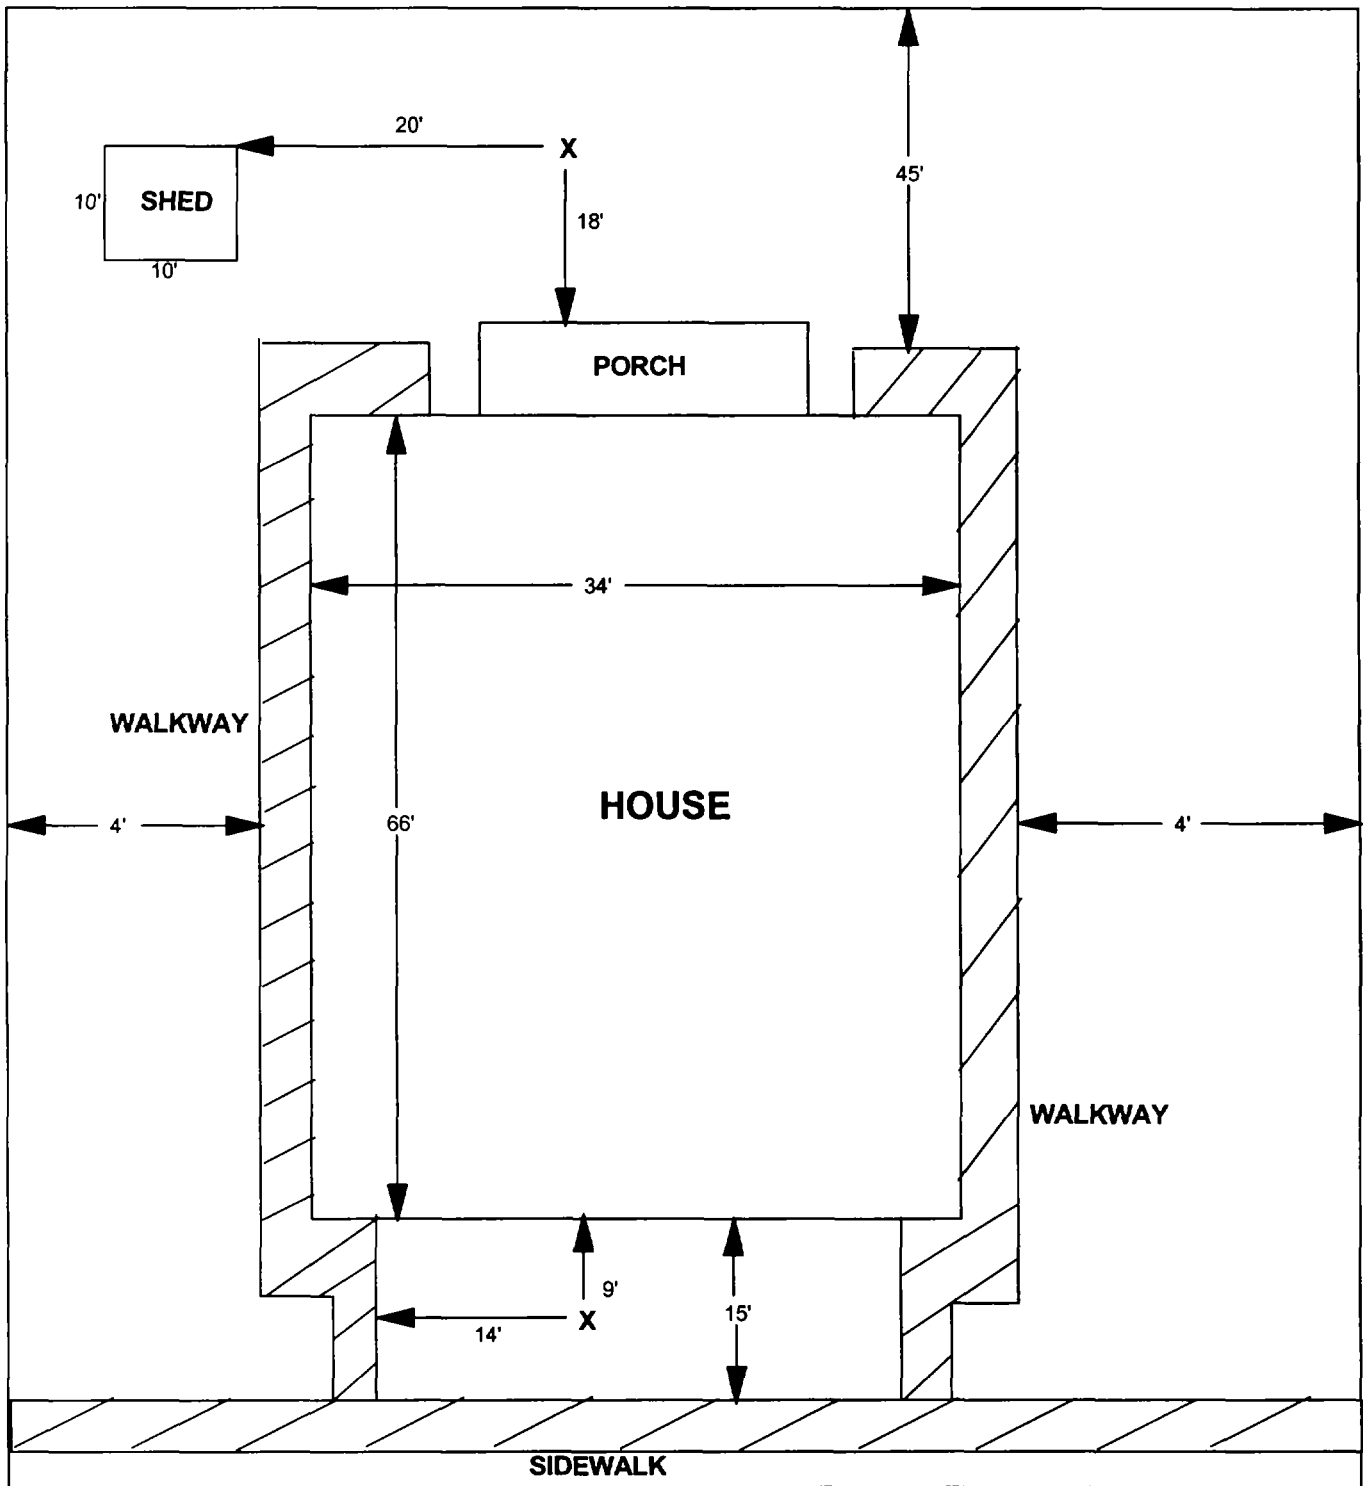

X = SAMPLE POINT

1932/34 GRAND

**TOTAL
DIMENSIONS
128'X42'**

OHM 
Corporation
Findlay, Ohio

Drawn By: jg	Checked By:
Date: 8/19/98	Approved By:
Scale: NTS	Drawing No:

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ction Date: 3/20/97

oadout: 3/22/97

Restoration Begins: 3/22/97

Restoration Completed: 4/4/97

*Stack emission sites were not sampled for verification due to the fact that a pre-determined depth for excavation was given to OHM by USACE.

*An excavation depth of 12 inches was established by USACE prior to work commencing.

*The excavation of special waste yielded a total of 150.11 cubic yards, which was shipped to WMI-Milam for disposal.

*Equipment utilized during excavation:

*TL-26

*TCM

*X331

*17-KW

*Subcontractors:

*WMI-landfill

*B. Garcia-trucking

*Granthum-trucking

*Pedigo Sod Farm

EASEMENT INFORMATION

This easement was completed after the Temporary Restraining Order (TRO) was lifted.

OHM CORPORATION
PROJECT 19531
GRANITE CITY, IL

QUANTITY SUMMARY FOR

1933/35 Grand

SPECIAL WASTE (TONS)	BACKFILL (LOADS)	TOPSOIL (TONS)	CA-6 (TONS)	CA-7 (TONS)	SAND (TONS)	SOD CU.YDS.	CONCRETE	OTHER
195.15	2	12	104.97	73.4		63		

**Sampling Analysis
Project #19531**

0 - 3" Front and Back

Street/Number Address	A		A	
	PPM	No.	PPM	No.
	PPM	No.	PPM	No.

1933 Grand

577 1872

3 - 6" Front and Back

	B		B	
	PPM	No.	PPM	No.
	PPM	No.	PPM	No.

539 446

6 - 12" Front and Back

	C		C	
	PPM	No.	PPM	No.
	PPM	No.	PPM	No.

193 1409

261 610

Depth Excav. (inch)

12

PARKING

GRAVEL
PARKING
LOT


GRAVEL
PARKING
LOT

GR1937

GR1933

GR1929/1931

GR1923

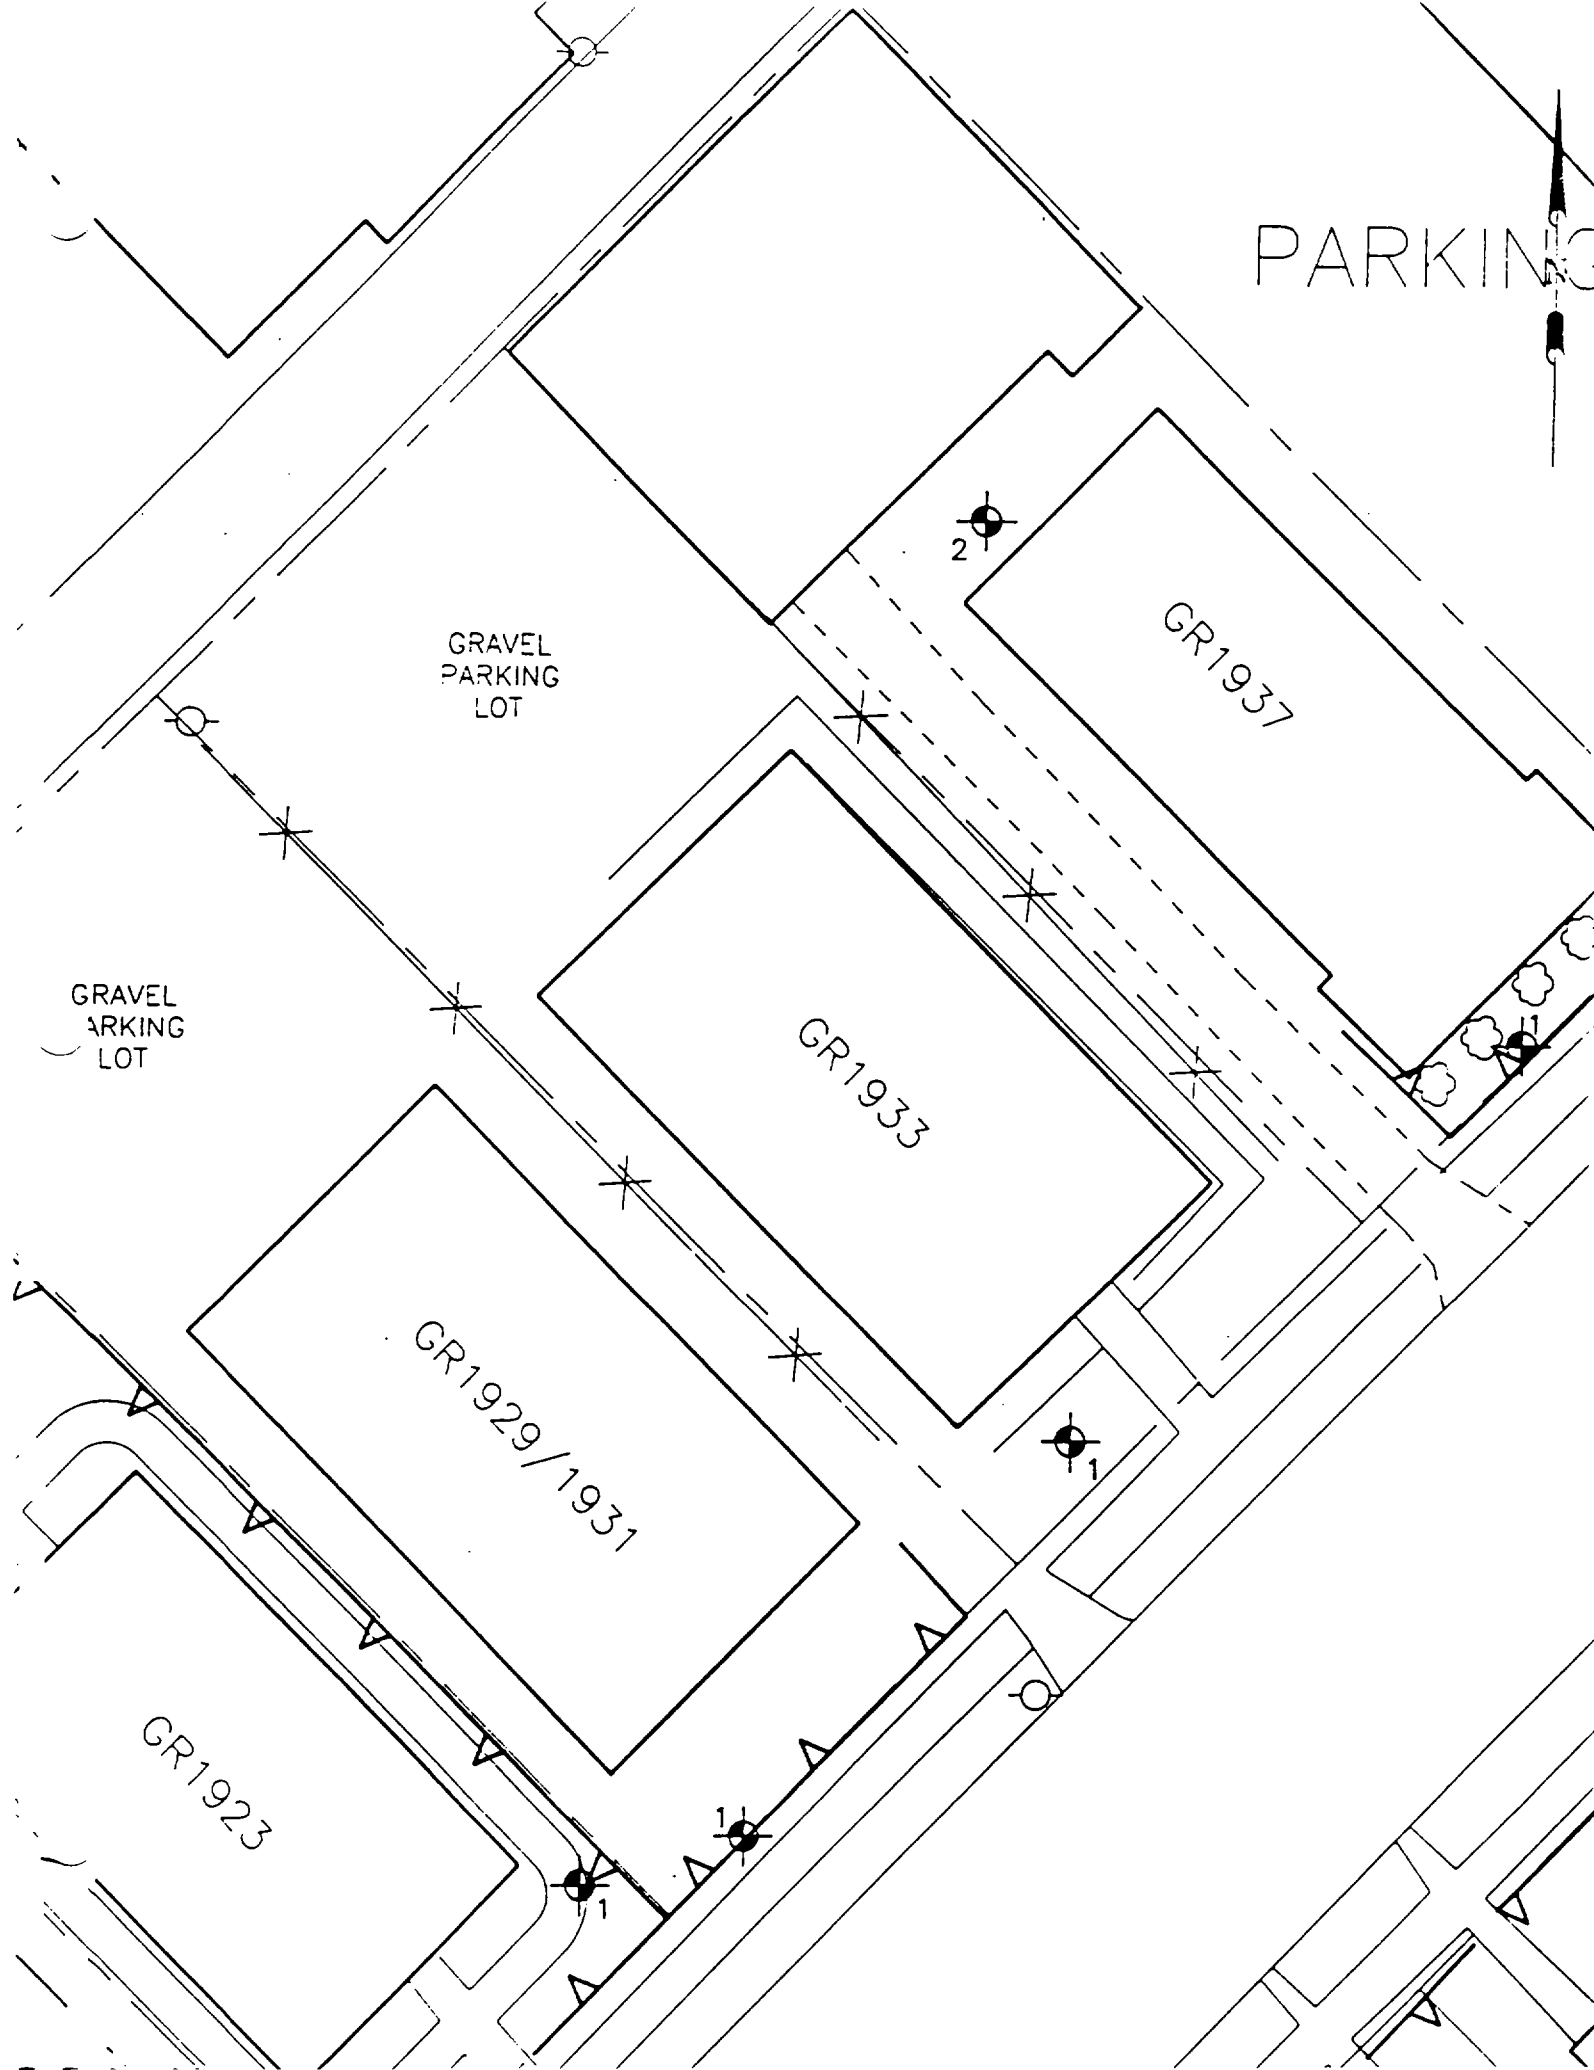

2

2

2

2117/19 Grand

Action Date: 4/24/98

Loadout: 5/5/98

Restoration Begins: 5/6/98

Restoration Completed: 5/19/98

*Stack emission sites were not sampled for verification due to the fact that a pre-determined depth for excavation was given to OHM by USACE.

*An excavation depth of 12 inches was established by USACE prior to work commencing.

*The excavation of special waste yielded a total of 80.41 cubic yards, which was shipped to WMI-Milam for disposal.

*Equipment utilized during excavation:

*TL-26

*TCM

*X331

*17-KW

*Subcontractors:

*WMI-landfill

*B. Garcia-trucking

*Grantham-trucking

*Emerald Turf Farm

OHM CORPORATION
PROJECT 19531
GRANITE CITY, IL

QUANTITY SUMMARY FOR 2117/19 Grand

SPECIAL WASTE (TONS)	BACKFILL (LOADS)	TOPSOIL (TONS)	CA-6 (TONS)	CA-7 (TONS)	SAND (TONS)	SOD CU.YDS.	CONCRETE	OTHER
104.54	5		15.25	30.25		60		

**Sampling Analysis
Project #19531**

0 - 3" Front and Back

Street/Number Address	A	
	PPM	PPM
	No.	No.
2117/19 Grand	643	785


3 - 6" Front and Back

	B	
	PPM	PPM
	No.	No.
	592	322

6 - 12" Front and Back

	C	
	PPM	PPM
	No.	No.
	418	571

	Depth	
	Excav.	
	(inch)	
		12

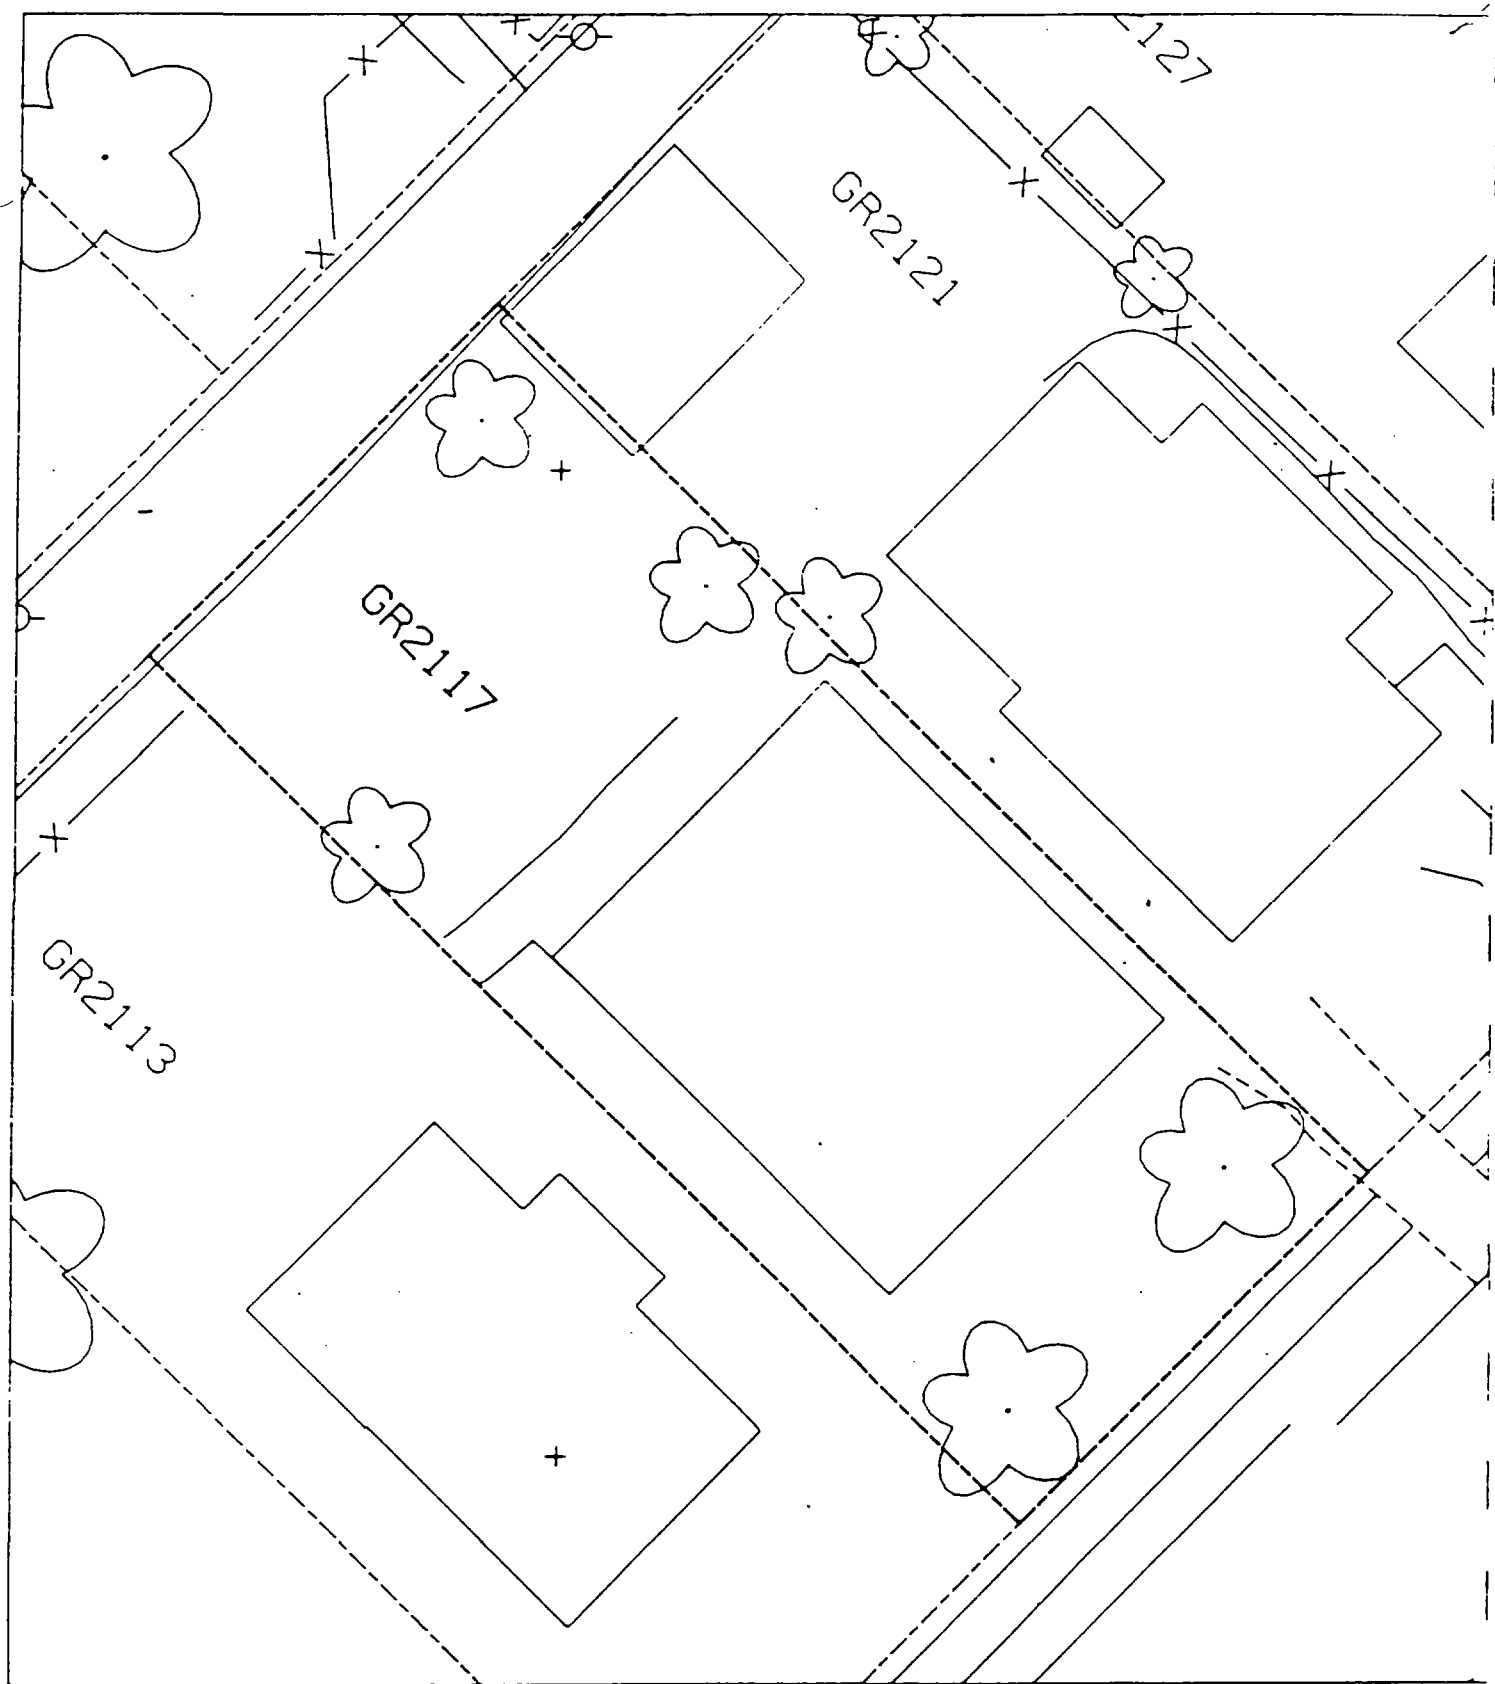

2129 Grand

Action Date: 3/12/98

Loadout: 3/14/98

Restoration Begins: 3/14/98

Restoration Completed: 3/25/98

*Stack emission sites were not sampled for verification due to the fact that a pre-determined depth for excavation was given to OHM by USACE.

*An excavation depth of 6 inches was established by USACE prior to work commencing.

*The excavation of special waste yielded a total of 96.56 cubic yards, which was shipped to WMI-Milam for disposal.

*Equipment utilized during excavation:

*TL-26

*TCM

*X331

*17-KW

*Subcontractors:

*WMI-landfill

*B. Garcia-trucking

*Grantham-trucking

*Schneider Turf Farm

OHM CORPORATION
PROJECT 19531
GRANITE CITY, IL

QUANTITY SUMMARY FOR 2129 Grand

SPECIAL WASTE (TONS)	BACKFILL (LOADS)	TOPSOIL (TONS)	CA-6 (TONS)	CA-7 (TONS)	SAND (TONS)	SOD CU.YDS.	CONCRETE	OTHER
125.54	9		71.85			360		

**Sampling Analysis
Project #19531**

0 - 3" Front and Back

Street/Number Address	A		A	
	PPM	No.	PPM	No.
2129 Grand	354	823		
	457	514		


3 - 6" Front and Back

B	B		B	
	PPM	No.	PPM	No.
572	395			
	959	1061		

6 - 12" Front and Back

C	C		C	
	PPM	No.	PPM	No.
140	178			

Depth Excav. (inch)	
	6

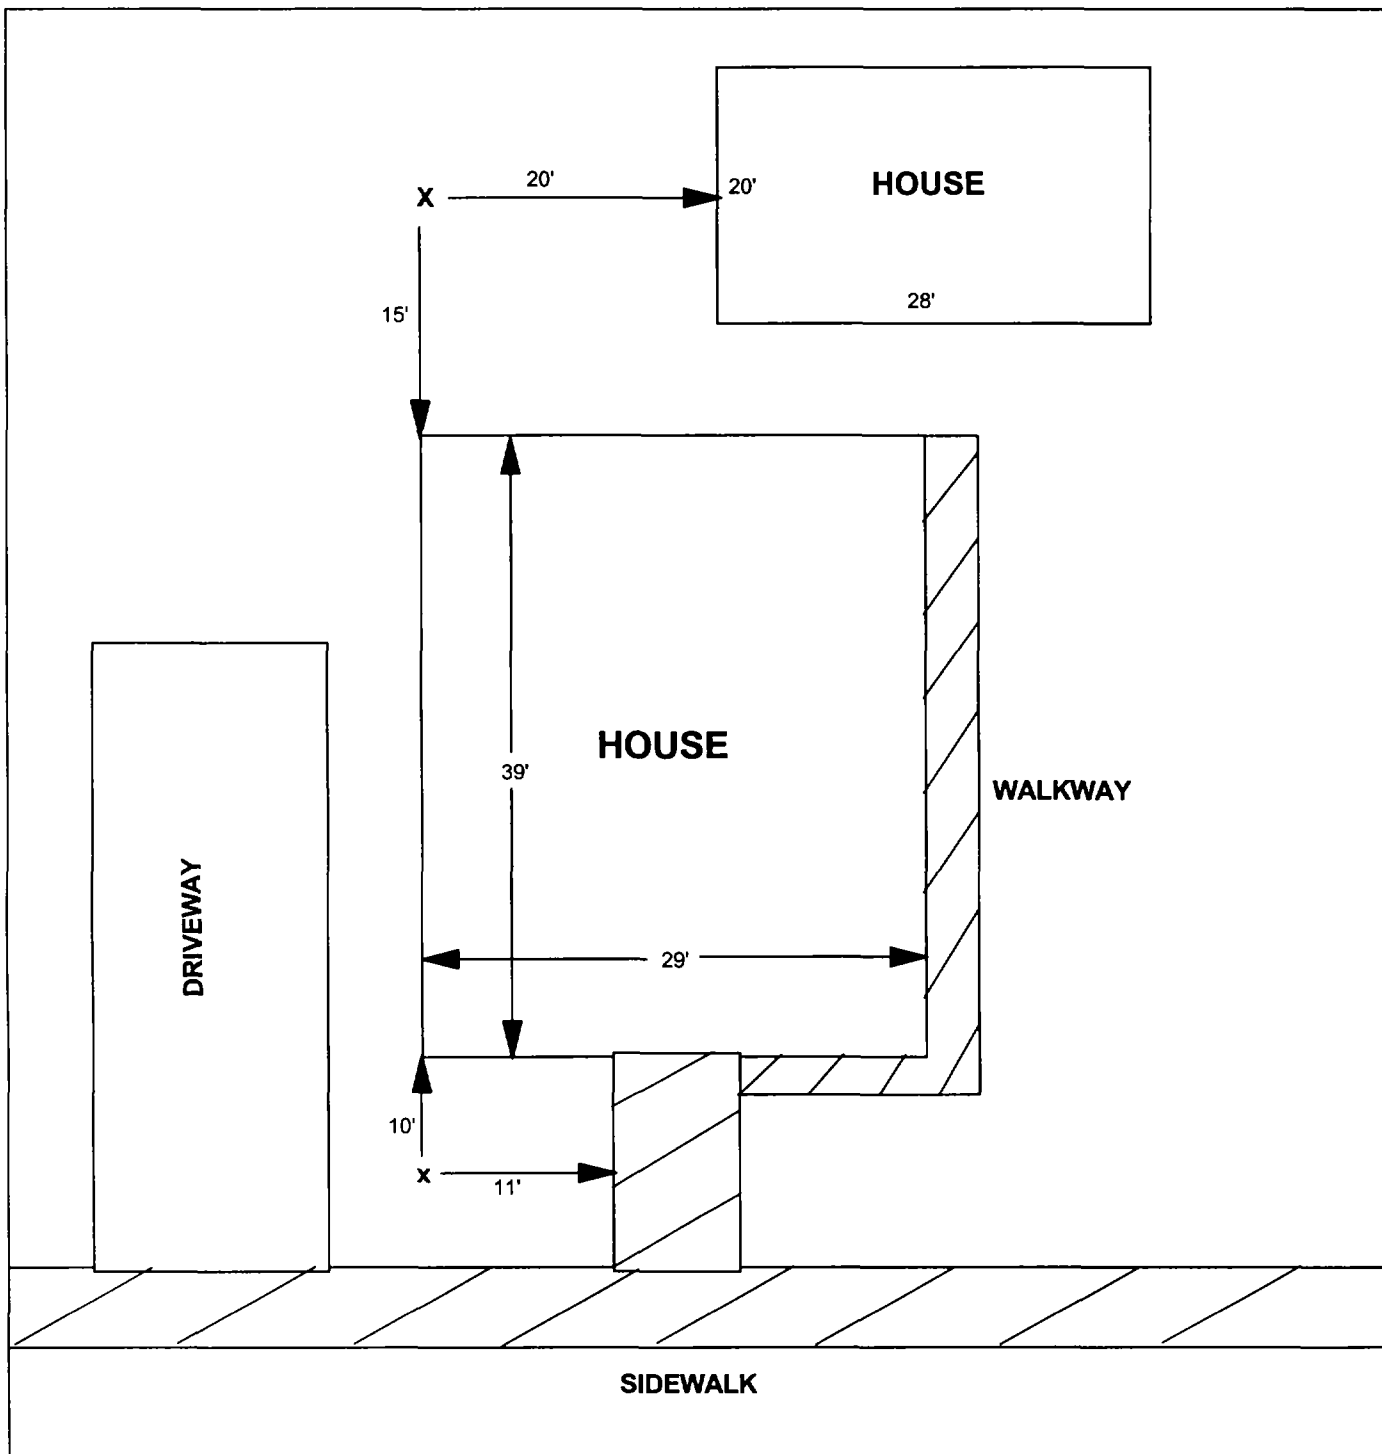

X = SAMPLE POINT

2129 GRAND

**TOTAL
DIMENSIONS
120'X53'**

OHM 
Corporation
Findlay, Ohio

Drawn By: JG	Checked By:
Date: 8/20/98	Approved By:
Scale: NTS	Drawing No:

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2139 Grand

Action Date: 3/5/98

Loadout: 3/6/98

Restoration Begins: 3/6/98

Restoration Completed: 3/25/98

*Stack emission sites were not sampled for verification due to the fact that a pre-determined depth for excavation was given to OHM by USACE.

*An excavation depth of 12 inches was established by USACE prior to work commencing.

*The excavation of special waste yielded a total of 101.93 cubic yards, which was shipped to WMI-Milam for disposal.

*Equipment utilized during excavation:

*TL-26

*TCM

*X331

*17KW

*Subcontractors:

*WMI-landfill

*B. Garcia-trucking

*Granthum-trucking

*Schneider Turf Farm

OHM CORPORATION
 PROJECT 19531
 GRANITE CITY, IL

QUANTITY SUMMARY FOR 2139 Grand

SPECIAL WASTE (TONS)	BACKFILL (LOADS)	TOPSOIL (TONS)	CA-6 (TONS)	CA-7 (TONS)	SAND (TONS)	SOD CU.YDS.	CONCRETE	OTHER
132.51	7		70.4	13.1		180		

Sampling Analysis
Project #19531

0 - 3" Front and Back

Street/Number Address	A	
	PPM	PPM
	No.	No.

3 - 6" Front and Back

	B	
	PPM	PPM
	No.	No.

6 - 12" Front and Back

	C	
	PPM	PPM
	No.	No.

Depth Excav. (inch)

2139 Grand


482

1030

727 2050

759 344

12

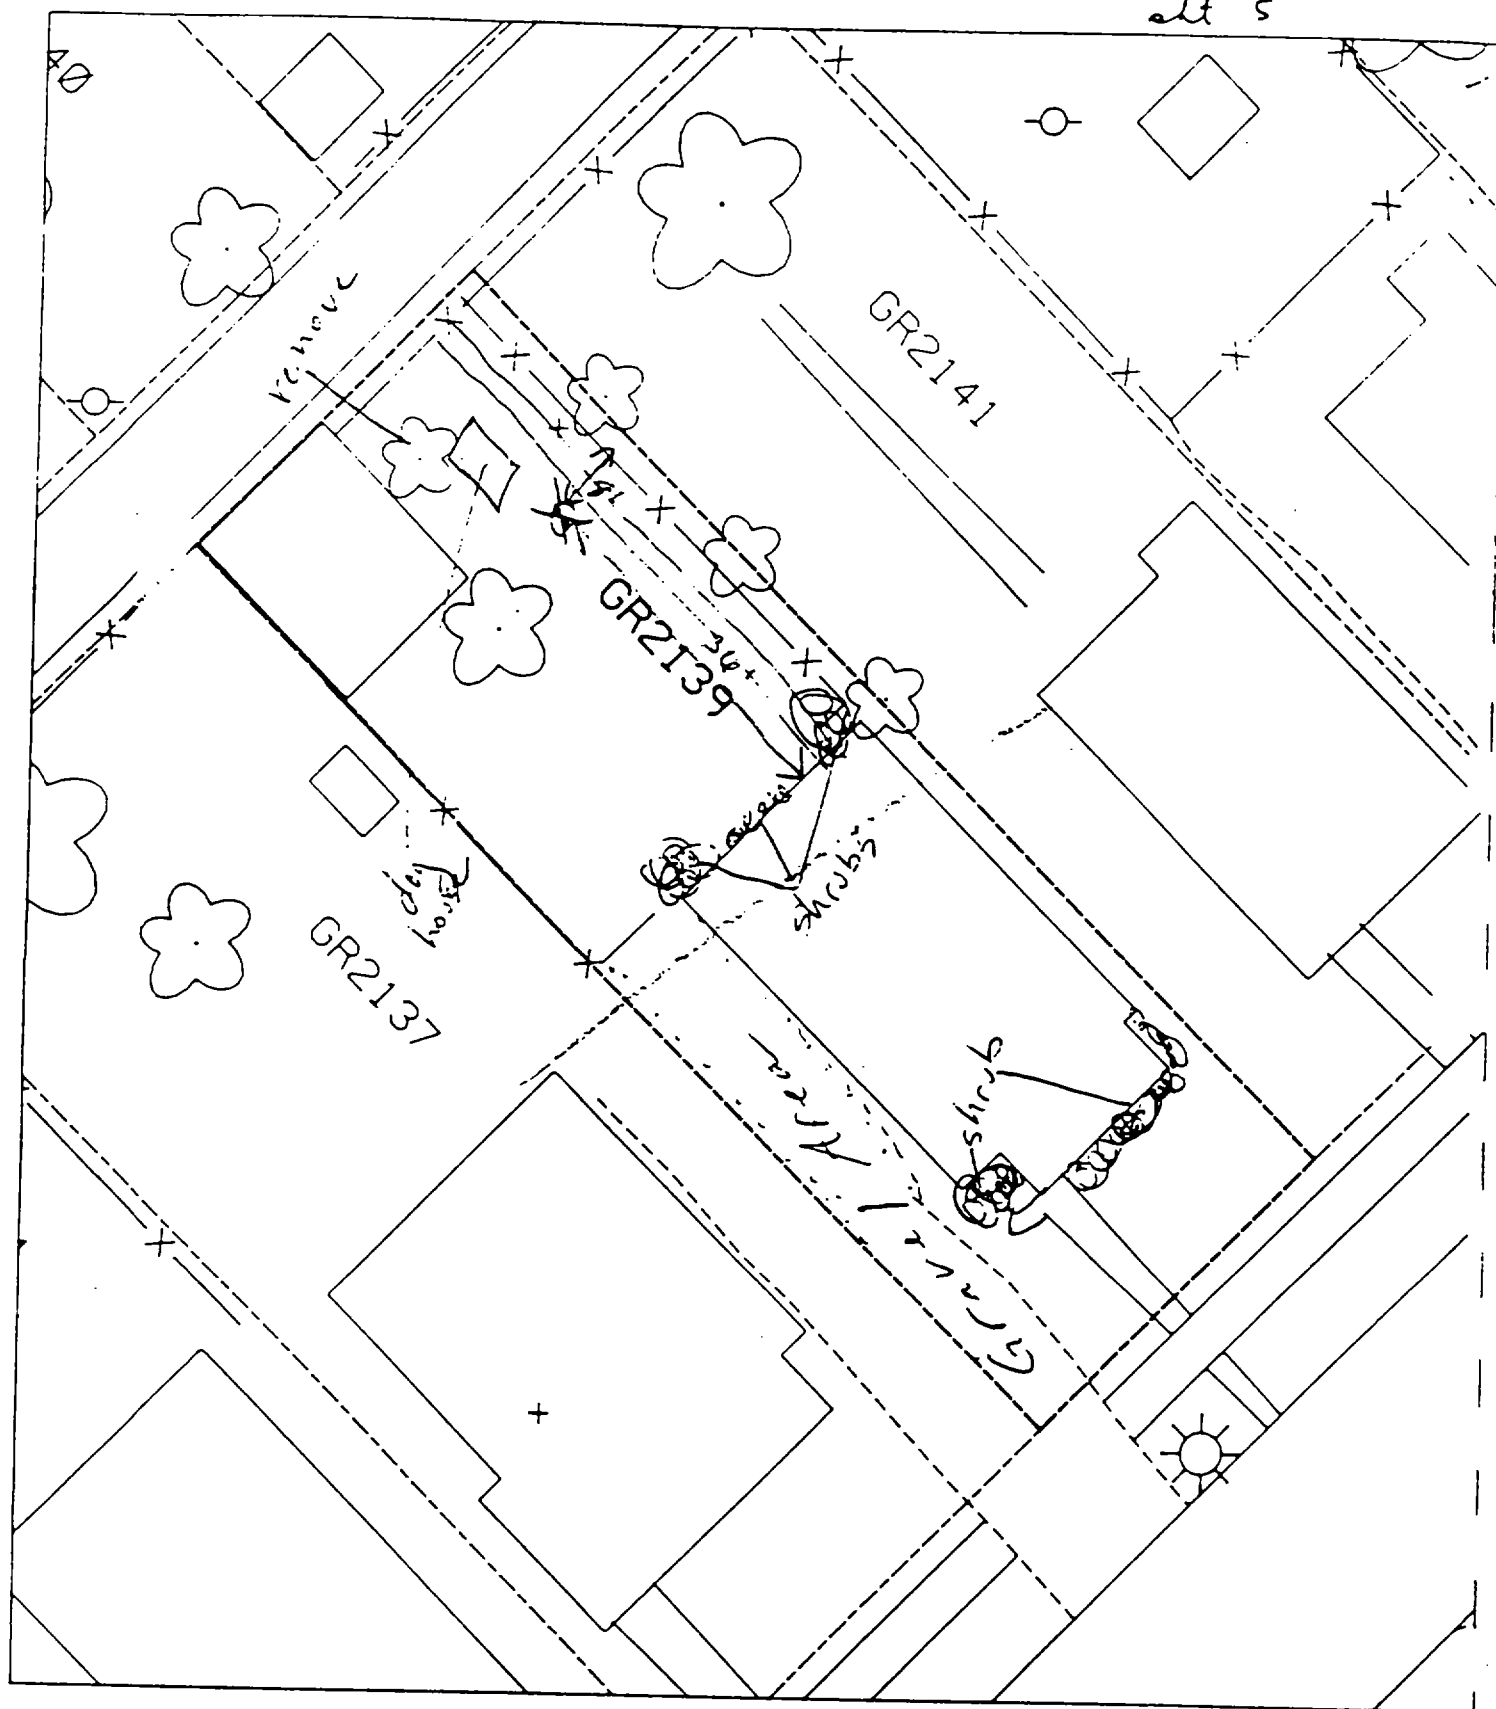

B1 - 36ft north of house & west of paved + house - 5370
 fence in front yard along sidewalk in front
 of bushes. per Wendy 5/13/92

B2 - ~~edges of backyard~~ in backyard per Wendy 5/13/92

1

2

3

2149 Grand

Action Date: 4/1/98

Loadout: 4/2/98

Restoration Begins: 4/6/98

Restoration Completed: 4/11/98

*Stack emission sites were not sampled for verification due to the fact that a pre-determined depth for excavation was given to OHM by USACE.

*An excavation depth of 6 inches was established by USACE prior to work commencing.

*The excavation of special waste yielded a total of 91.04 cubic yards, which was shipped to WMI-Milam for disposal.

*Equipment utilized during excavation:

*TL-26

*TCM

*X331

*17KW

*Subcontractors:

*WMI-landfill

*B. Garcia-trucking

*Granthum-trucking

*Schneider Turf Farm

OHM CORPORATION
PROJECT 19531
GRANITE CITY, IL

QUANTITY SUMMARY FOR 2149 Grand

SPECIAL WASTE (TONS)	BACKFILL (LOADS)	TOPSOIL (TONS)	CA-6 (TONS)	CA-7 (TONS)	SAND (TONS)	SOD CU.YDS.	CONCRETE	OTHER
118.36	8					420		

Sampling Analysis
Project #19531

0 - 3" Front and Back

Street/Number Address	A		A	
	PPM	No.	PPM	No.
2149 Grand	352	963		
	483	836		


3 - 6" Front and Back

B	B		B	
	PPM	No.	PPM	No.
256	1100			
451	1053			

6 - 12" Front and Back

C	C		C	
	PPM	No.	PPM	No.
76	114			

Depth Excav. (inch)
6

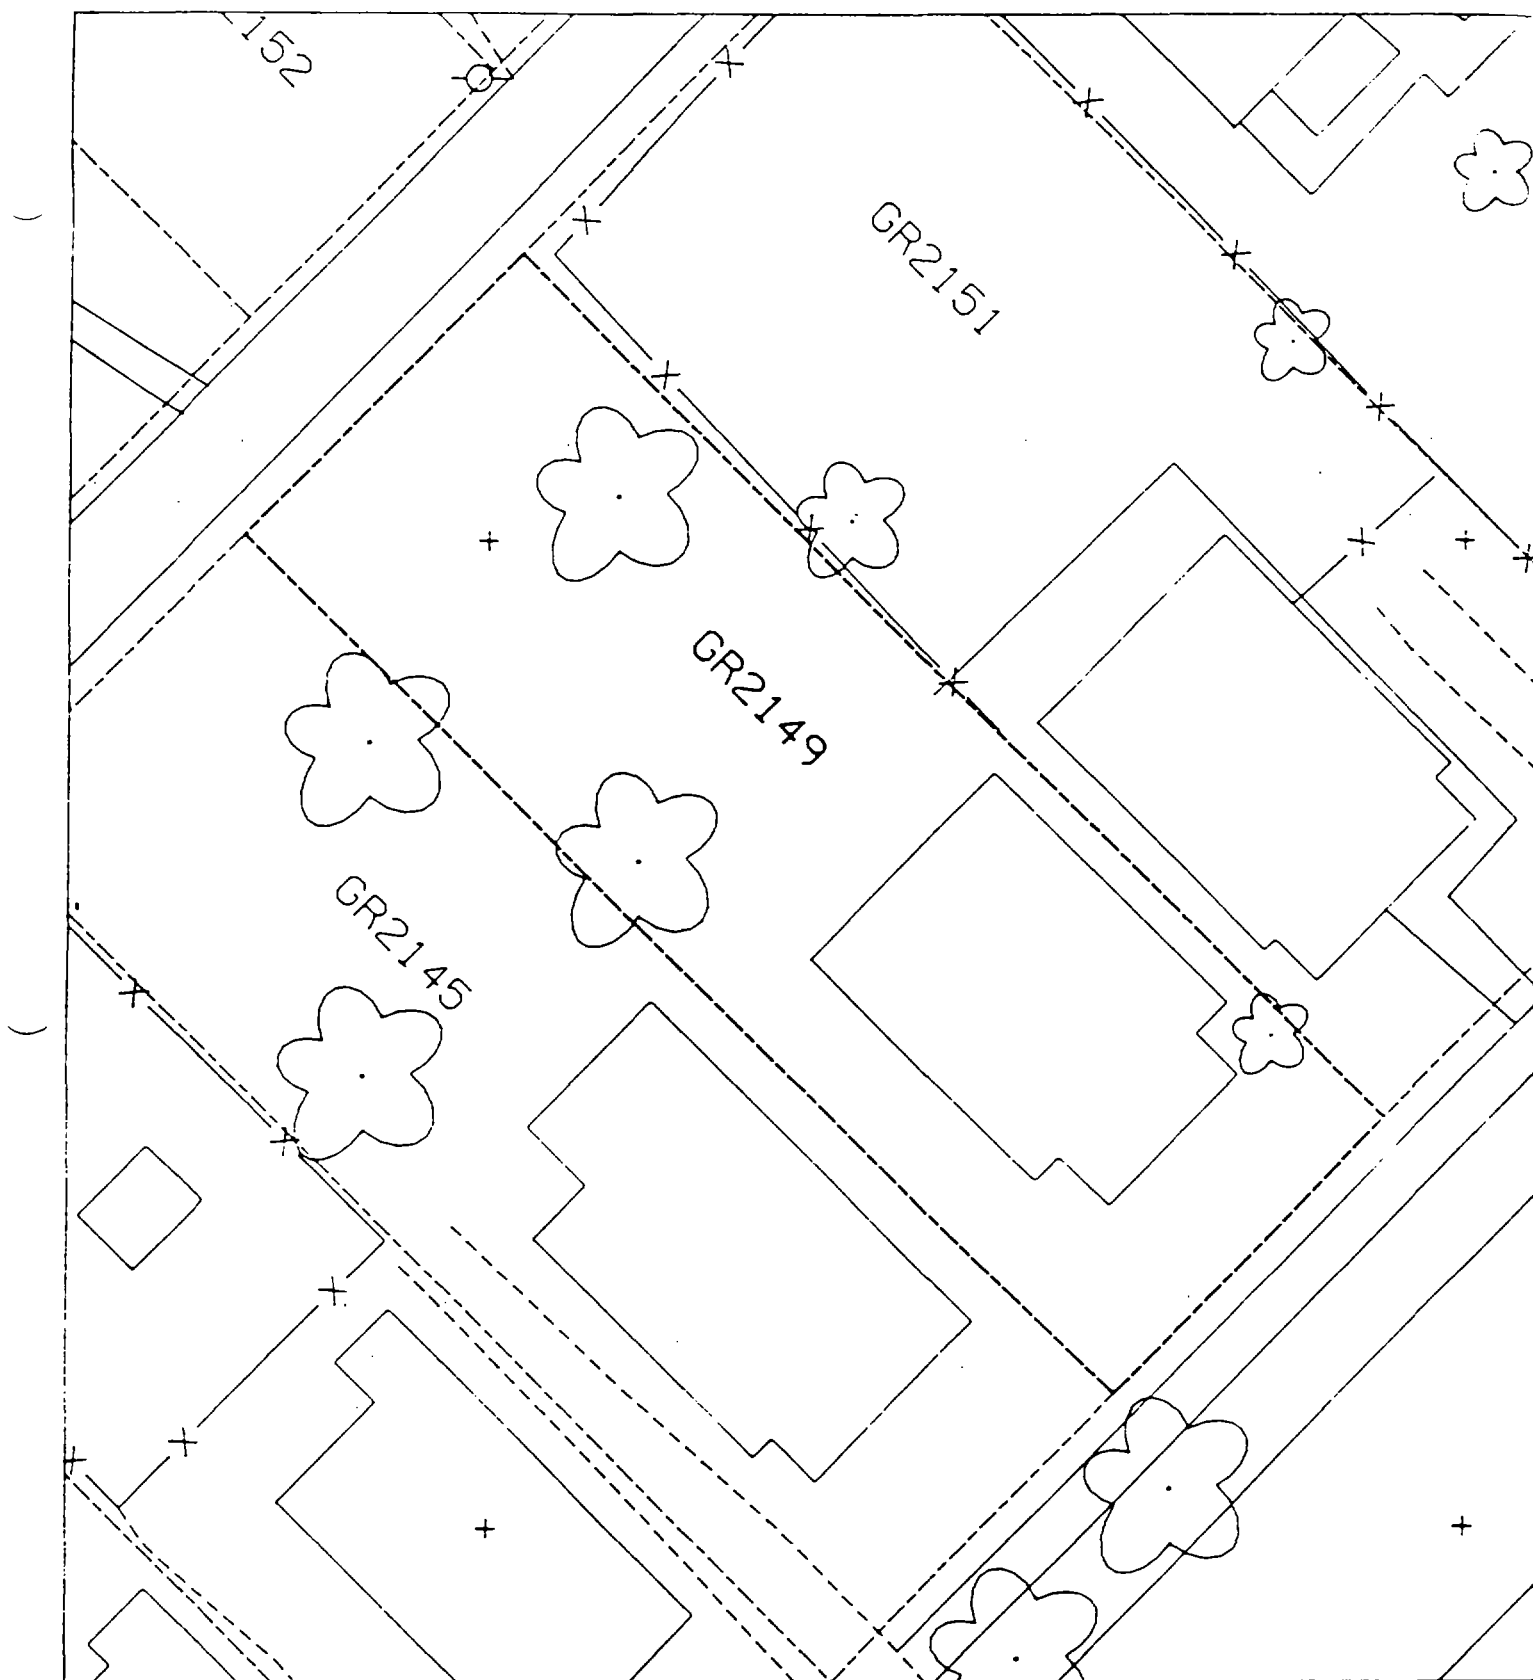

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)

)

2206 Grand

Action Date: 5/15/98

Loadout: 5/18/98

Restoration Begins: 5/21/98

Restoration Completed: 6/2/98

*Stack emission sites were not sampled for verification due to the fact that a pre-determined depth for excavation was given to OHM by USACE.

*An excavation depth of 6 inches was established by USACE prior to work commencing.

*The excavation of special waste yielded a total of 36.39 cubic yards, which was shipped to WMI-Milam for disposal.

*Equipment utilized during excavation:

*TL-26

*TCM

*X331

*17-KW

*Subcontractors:

*WMI-landfill

*B. Garcia-trucking

*Grantham-trucking

*Emerald-turf farm

**OHM CORPORATION
PROJECT 19531
GRANITE CITY, IL**

QUANTITY SUMMARY FOR

2206 Grand

SPECIAL WASTE (TONS)	BACKFILL (LOADS)	TOPSOIL (TONS)	CA-6 (TONS)	CA-7 (TONS)	SAND (TONS)	SOD CU.YDS.	CONCRETE	OTHER
47.31	2		41.7			180		

**Sampling Analysis
Project #19531**

0 - 3" Front and Back

Street/Number Address	A		A	
	PPM	No.	PPM	No.

3 - 6" Front and Back

B	B		B	
	PPM	No.	PPM	No.

6 - 12" Front and Back

C	C		C	
	PPM	No.	PPM	No.

Depth	Depth	
	Excav.	(inch)

2206 Grand


980

497

2980 563

137 331

6

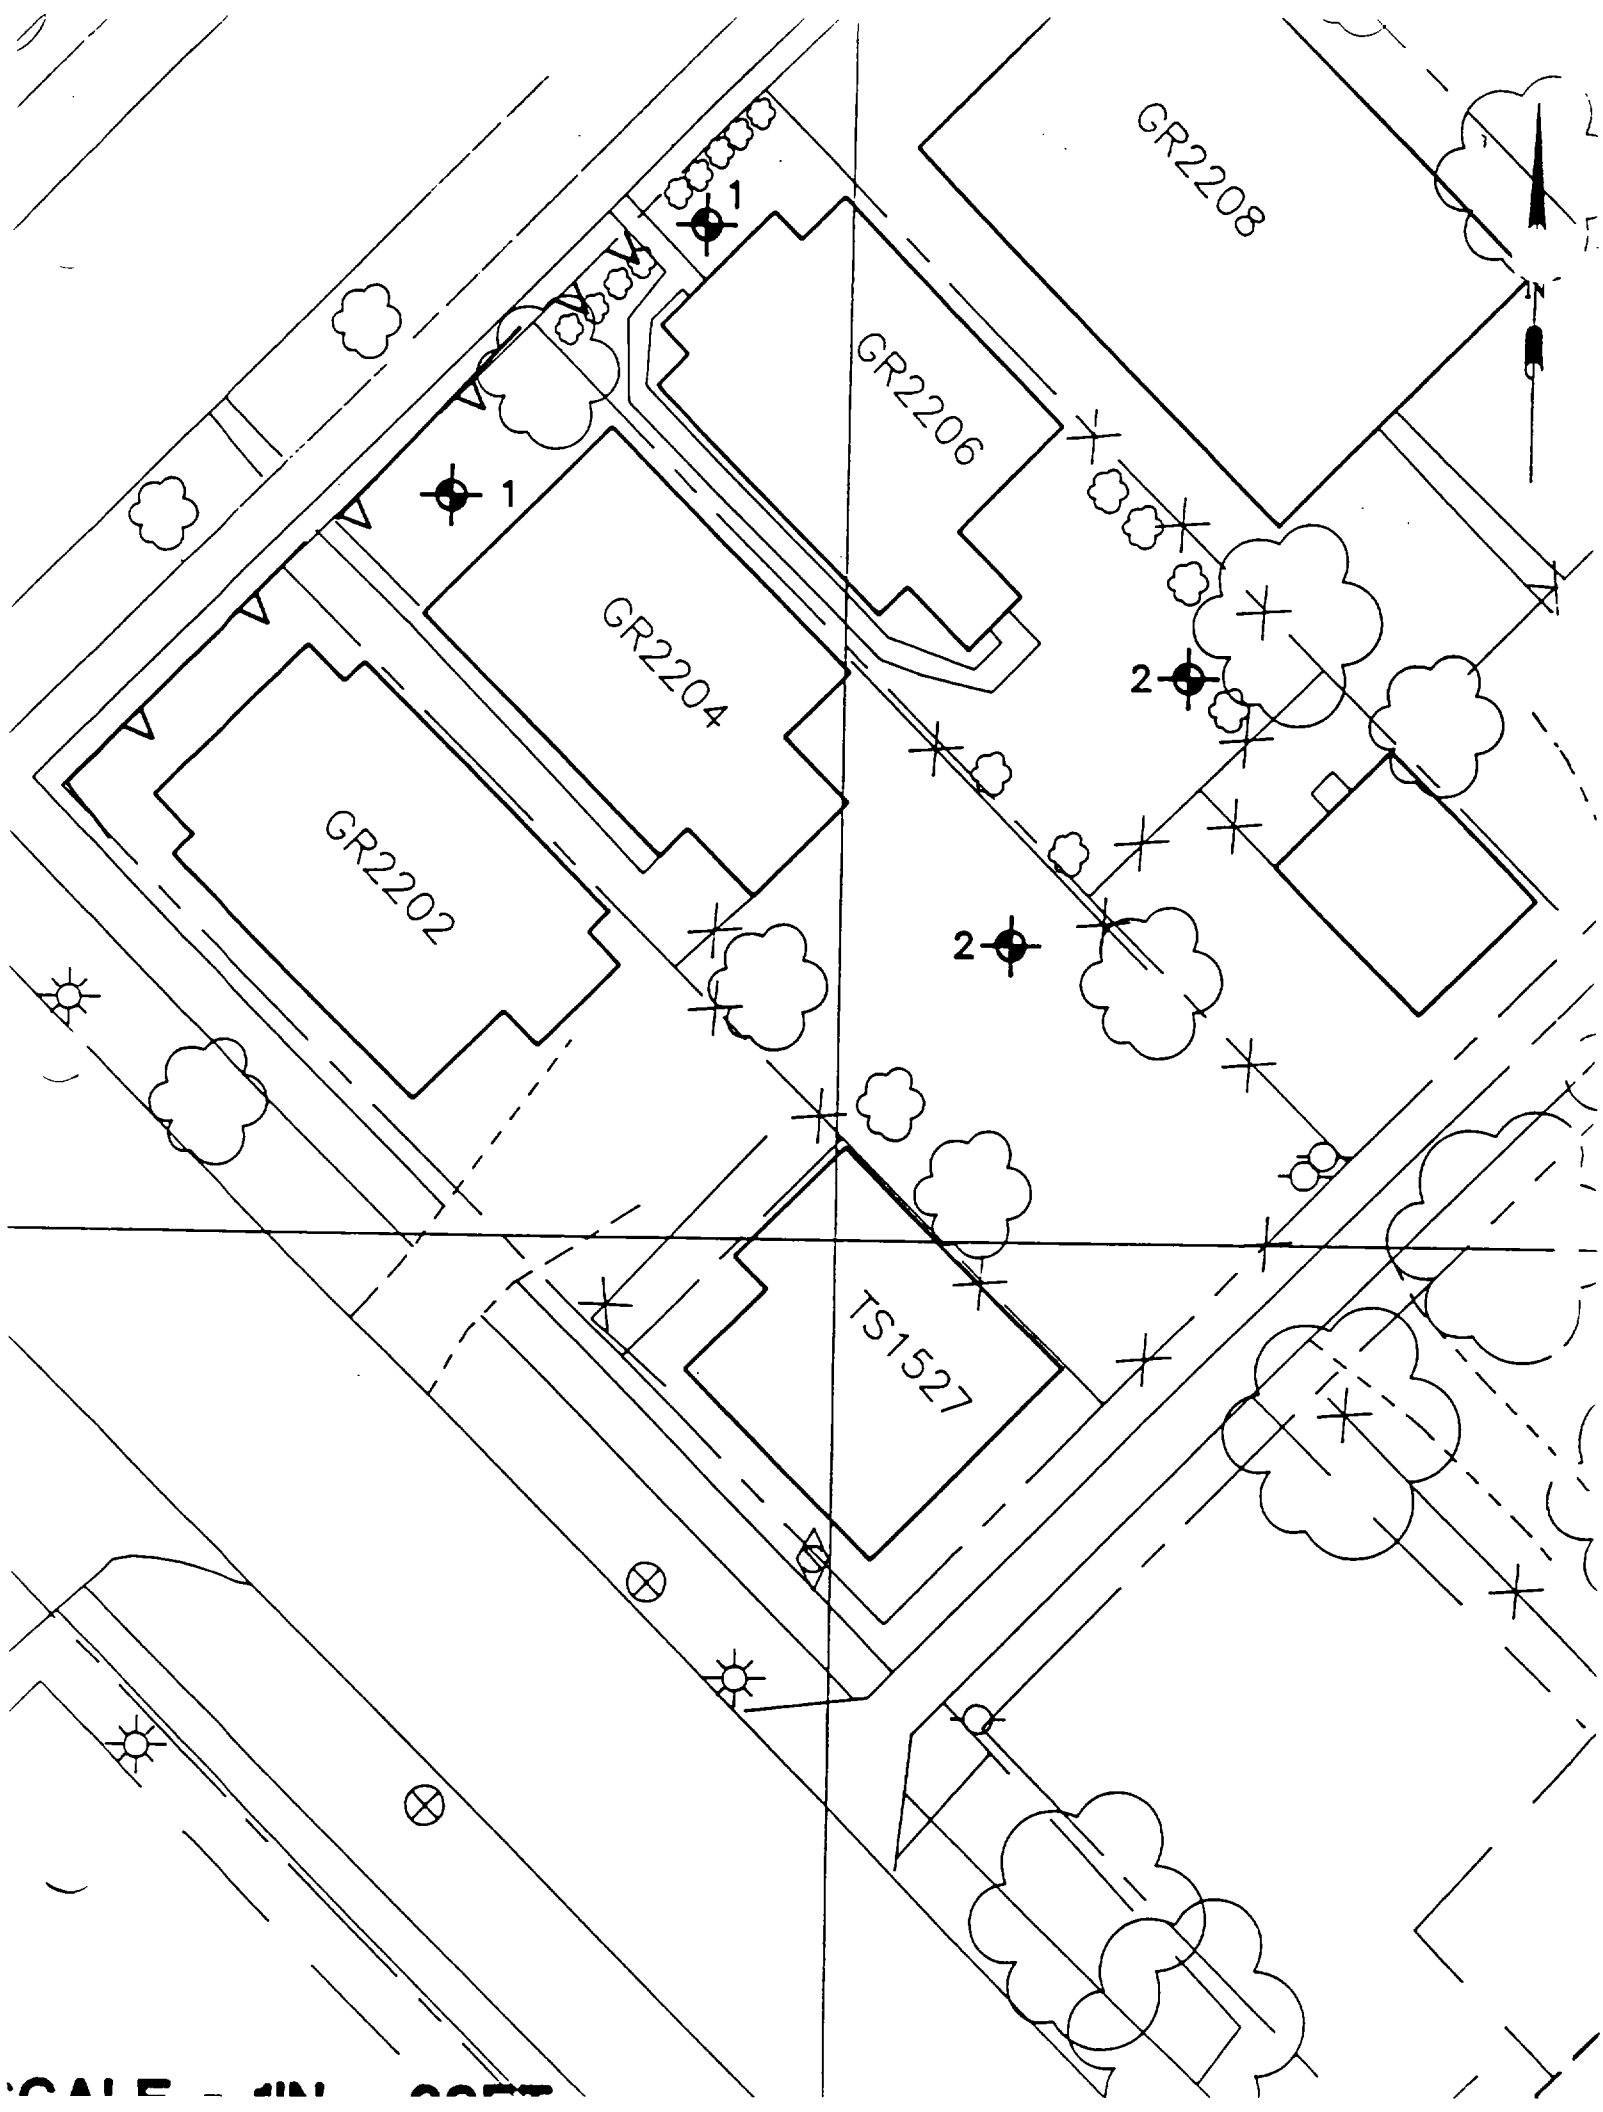

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)

)

Action Date: 5/19/98

Loadout: 5/20/98

Restoration Begins: 5/20/98

Restoration Completed: 5/21/98

*Stack emission sites were not sampled for verification due to the fact that a pre-determined depth for excavation was given to OHM by USACE.

*An excavation depth of 3 inches was established by USACE prior to work commencing.

*The excavation of special waste yielded a total of 48.75 cubic yards, which was shipped to WMI-Milam for disposal.

*Equipment utilized during excavation:

*TL-26

*TCM

*X331

*17-KW

*Subcontractors:

*WMI-landfill

*B. Garcia-trucking

*Grantham-trucking

*Emerald-turf farm

**OHM CORPORATION
PROJECT 19531
GRANITE CITY, IL**

QUANTITY SUMMARY FOR

2208/10 Grand

SPECIAL WASTE (TONS)	BACKFILL (LOADS)	TOPSOIL (TONS)	CA-6 (TONS)	CA-7 (TONS)	SAND (TONS)	SOD CU.YDS.	CONCRETE	OTHER
63.38	6		43.8	16.9		480		

Sampling Analysis
Project #19531

0 - 3" Front and Back

Street/Number Address	A	
	PPM	No.
2208/10 Grand	125	551
	290	530
	286	365


3 - 6" Front and Back

	B	
	PPM	No.
	61	197
	229	543
	286	357

6 - 12" Front and Back

	C	
	PPM	No.
	263	501
	199	218
	126	179

Depth Excav. (inch)
3

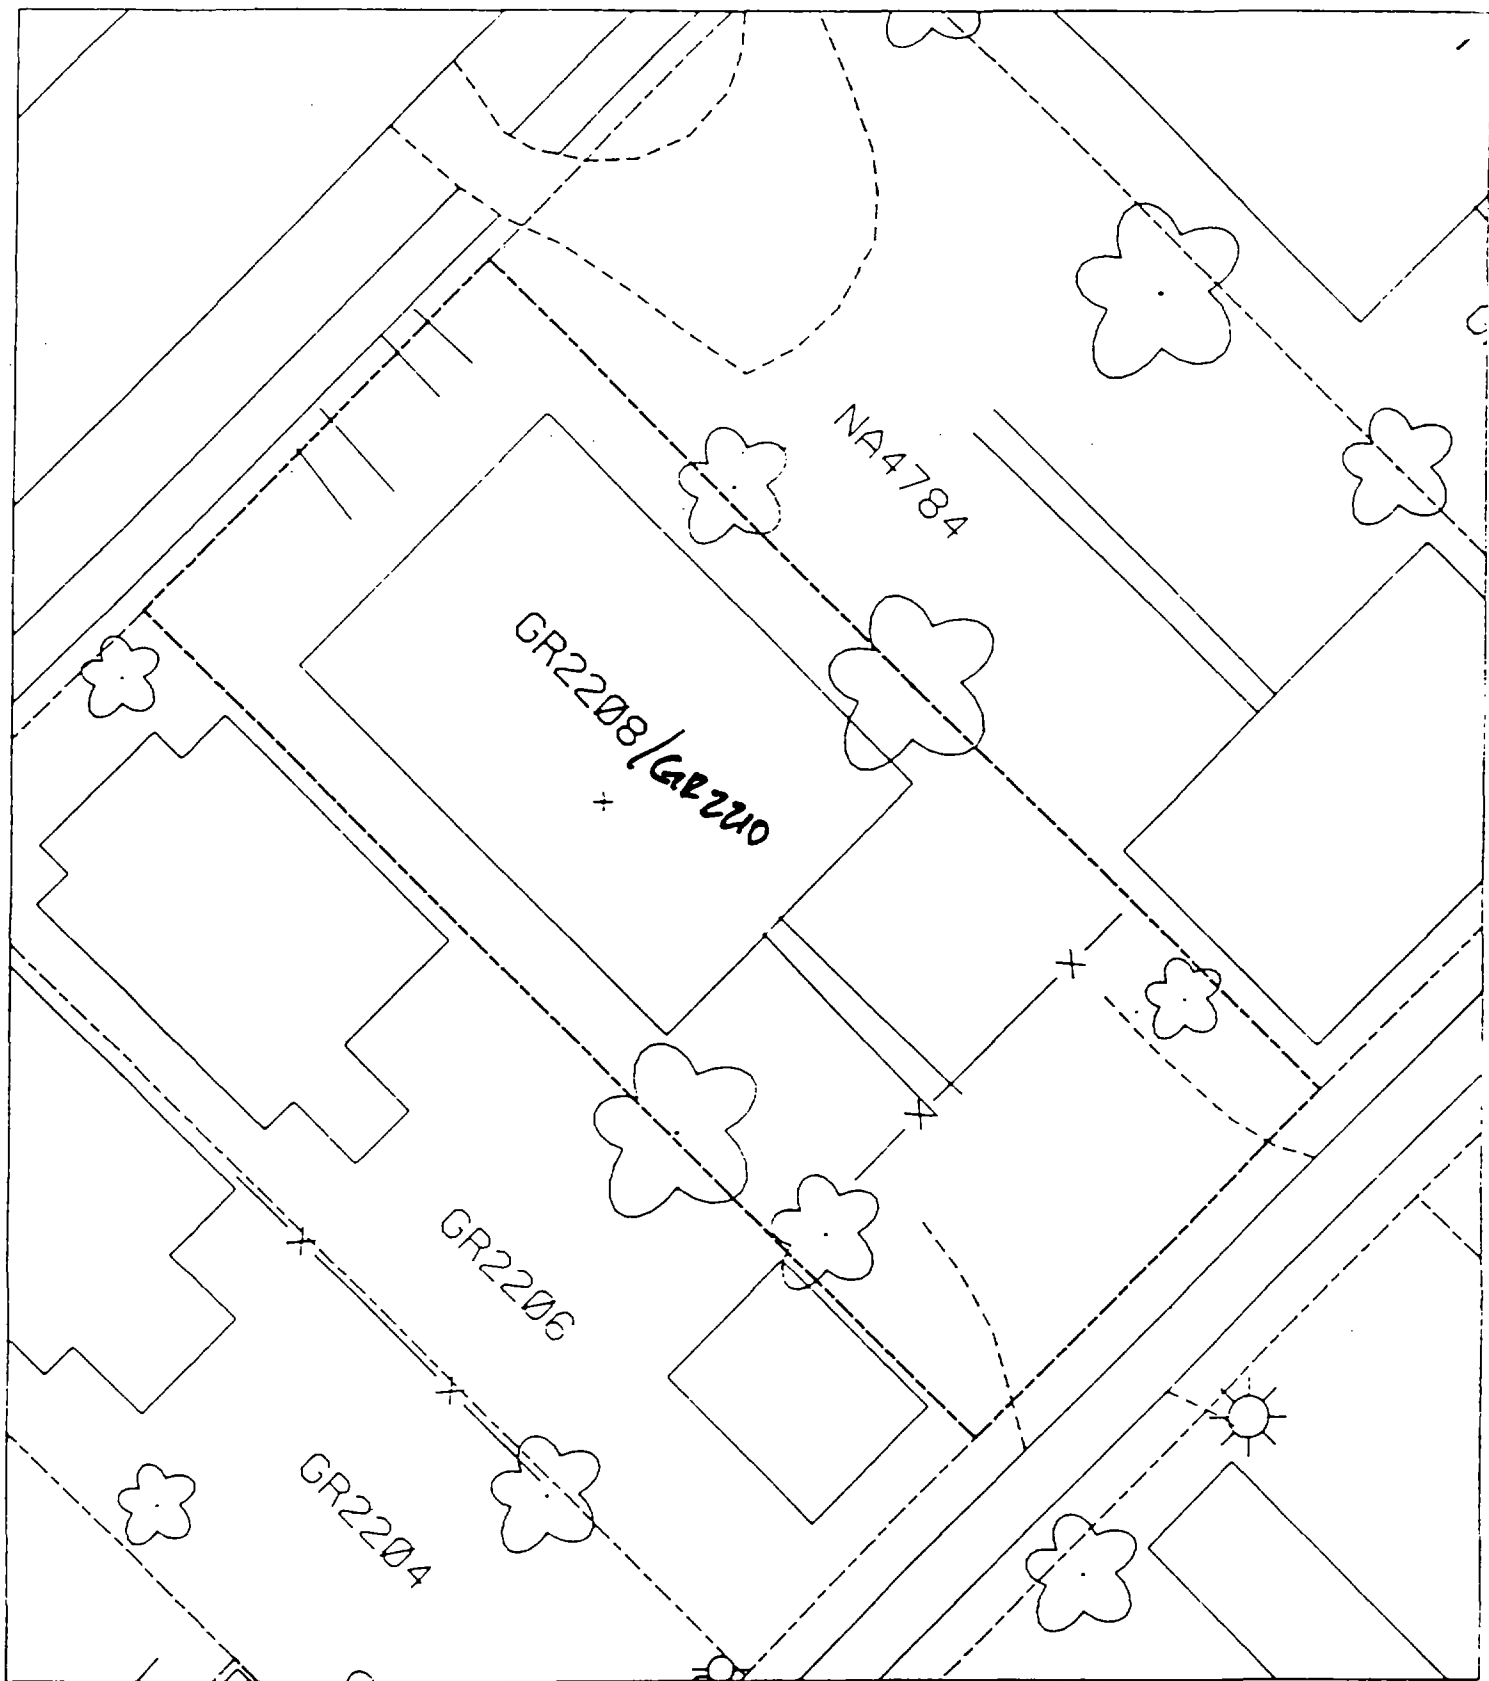

sh 44

)

)

)

2216/18 Grand

Action Date: 5/12/98

Loadout: 5/13/98

Restoration Begins: 5/14/98

Restoration Completed: 5/18/98

*Stack emission sites were not sampled for verification due to the fact that a pre-determined depth for excavation was given to OHM by USACE.

*An excavation depth of 6 inches was established by USACE prior to work commencing.

*The excavation of special waste yielded a total of 72.50 cubic yards, which was shipped to WMI-Milam for disposal.

*Equipment utilized during excavation:

*TL-26

*TCM

*X331

*17-KW

*Subcontractors:

*WMI-landfill

*B. Garcia-trucking

*Grantham-trucking

*Schneider Turf Farm

OHM CORPORATION
PROJECT 19531
GRANITE CITY, IL

QUANTITY SUMMARY FOR 2216/18 Grand

SPECIAL WASTE (TONS)	BACKFILL (LOADS)	TOPSOIL (TONS)	CA-6 (TONS)	CA-7 (TONS)	SAND (TONS)	SOD CU.YDS.	CONCRETE	OTHER
94.25	5		60.85	14.2		310		

**Sampling Analysis
Project #19531**

0 - 3" Front and Back

	A	A	A
Street/Number	PPM	PPM	PPM
Address	No.	No.	No.

2216/18 Grand 570 692

3 - 6" Front and Back

B	B	B
PPM	PPM	PPM
No.	No.	No.

381 692
159 630

6 - 12" Front and Back

C	C	C
PPM	PPM	PPM
No.	No.	No.


134 375

Depth
Excav.
(inch)

6

4/23/92 - Sample Data

ant 5

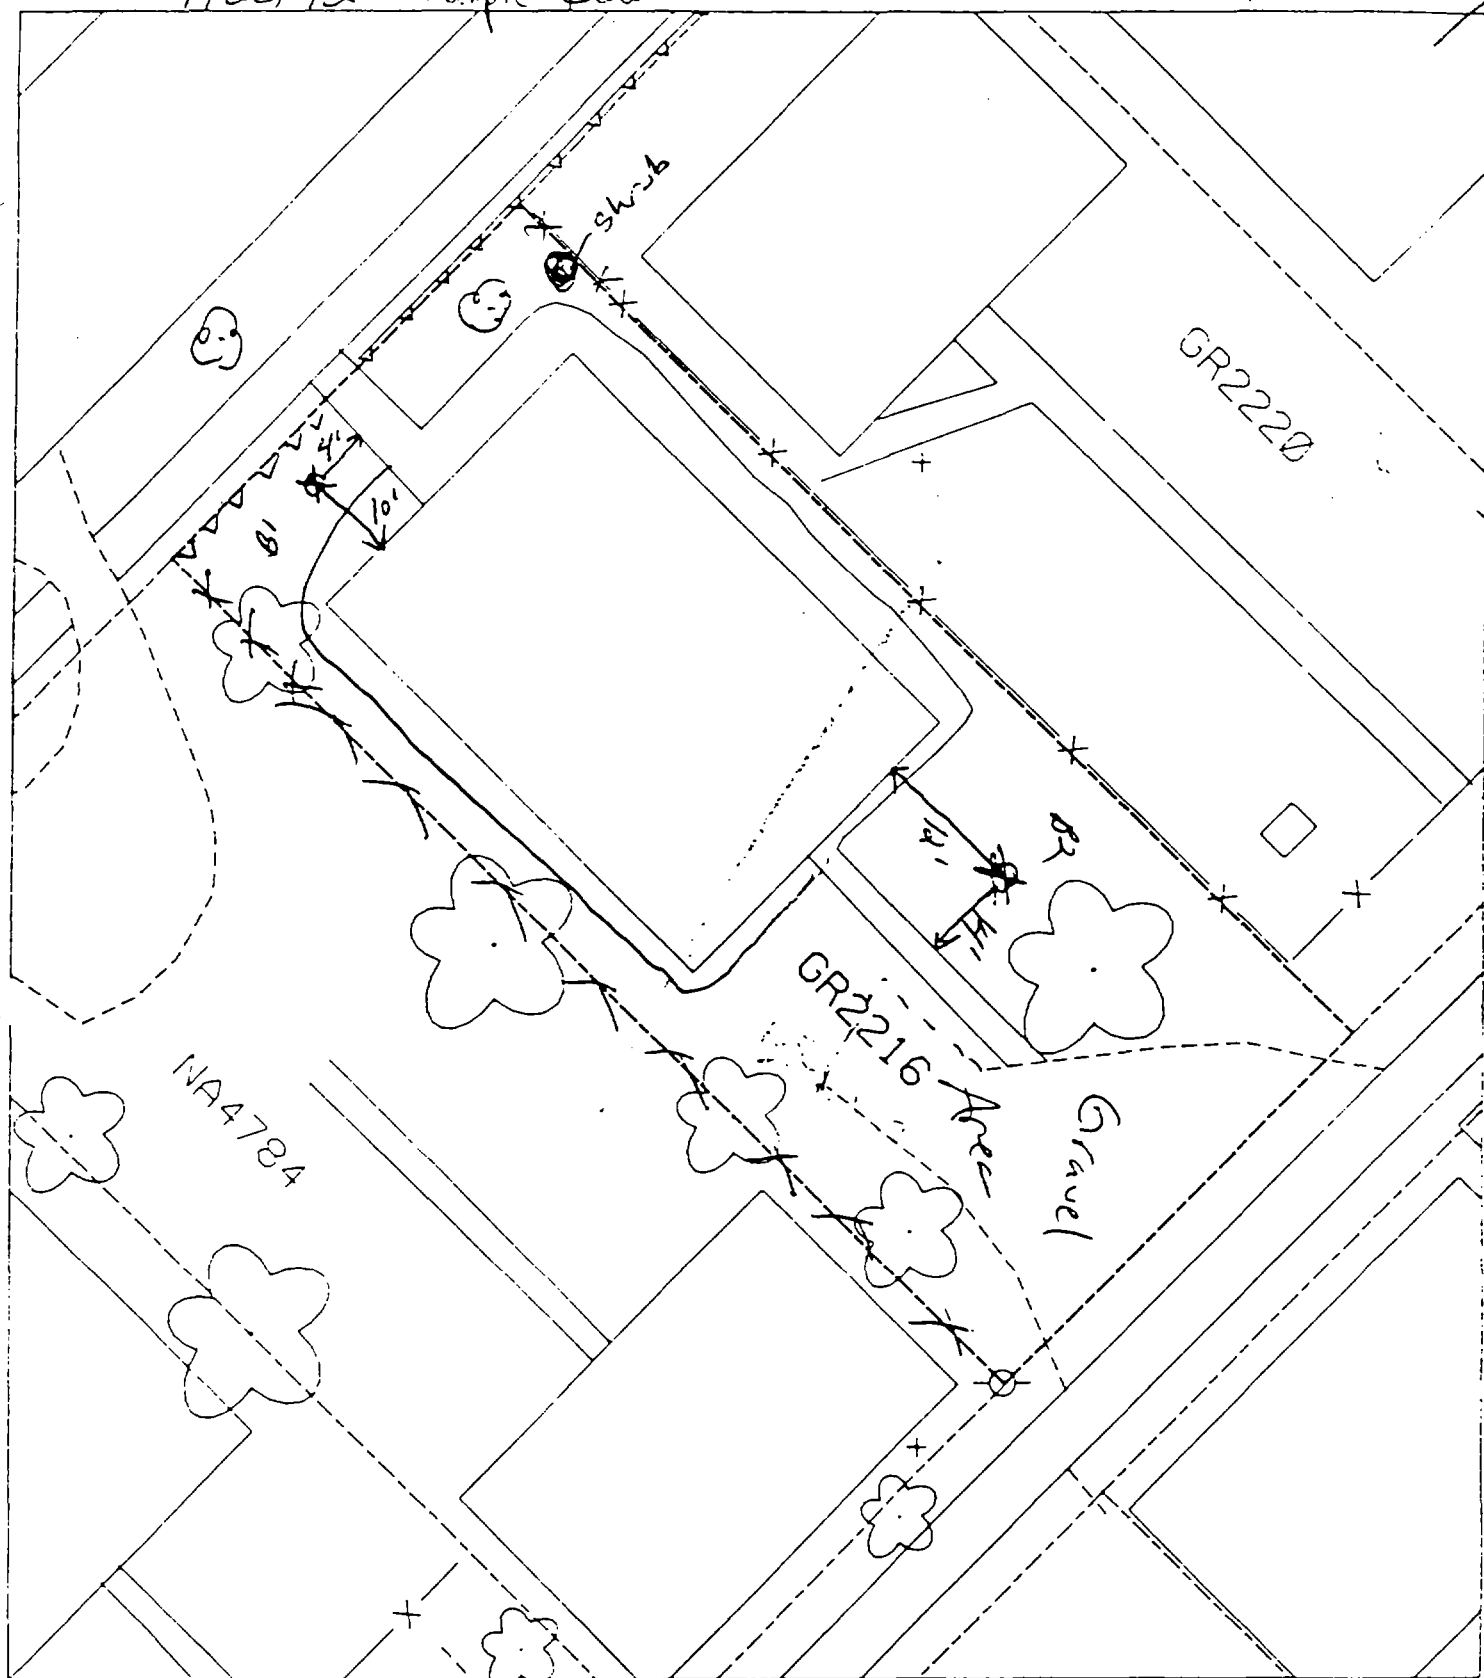

B¹ - 10' north of house & 4' west of sidewalk.

70 paved + house 55-60%

B² - 14' east of sidewalk & 12' south of house

Action Date: 4/25/98

Loadout: 5/4/98

Restoration Begins: 5/5/98

Restoration Completed: 5/13/98

*Stack emission sites were not sampled for verification due to the fact that a pre-determined depth for excavation was given to OHM by USACE.

*An excavation depth of 6 inches was established by USACE prior to work commencing.

*The excavation of special waste yielded a total of 130.36 cubic yards, which was shipped to WMI-Milam for disposal.

*Equipment utilized during excavation:

*TL-26

*TCM

*X331

*17-KW

*Subcontractors:

*WMI-landfill

*B. Garcia-trucking

*Grantham-trucking

*Emerald Turf Farm

OHM CORPORATION
PROJECT 19531
GRANITE CITY, IL

QUANTITY SUMMARY FOR 2224/26 Grand

SPECIAL WASTE (TONS)	BACKFILL (LOADS)	TOPSOIL (TONS)	CA-6 (TONS)	CA-7 (TONS)	SAND (TONS)	SOD CU.YDS.	CONCRETE	OTHER
169.48	6		13.6	27.65		300		

**Sampling Analysis
Project #19531**

0 - 3" Front and Back

Street/Number Address	A		A	
	PPM	No.	PPM	No.
2224/26 Grand	591		571	

3 - 6" Front and Back

B	B		B	
	PPM	No.	PPM	No.
520	371			
48	383			
404	261			

6 - 12" Front and Back

C	C		C	
	PPM	No.	PPM	No.
294	224			

Depth Excav. (inch)		
6		

A hand-drawn site plan of a gravel pit area. The plan shows a large rectangular area labeled "GR2226 (2224)" in the upper left. To its right is a smaller area labeled "GR2228" with the handwritten note "remove tree here". Below these is a large area labeled "GR2220". A dashed line runs diagonally across the plan, separating the upper areas from the lower ones. A small area labeled "Gravel Pit" is located near the bottom right. The plan includes various symbols: crosses (+) along the boundaries, a small square at the bottom left, and several cloud-like shapes representing trees or vegetation. A handwritten note "Area" is also present near the "Gravel Pit" label. The plan is drawn on a grid of dashed lines.

70 paved + house 75%

B² - 18' south of house & 10' east of corner of house,

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—

2228 Grand

Action Date: 4/24/98

Loadout: 4/25/98

Restoration Begins: 5/4/98

Restoration Completed: 5/13/98

*Stack emission sites were not sampled for verification due to the fact that a pre-determined depth for excavation was given to OHM by USACE.

*An excavation depth of 3 inches was established by USACE prior to work commencing.

*The excavation of special waste yielded a total of 49.62 cubic yards, which was shipped to WMI-Milam for disposal.

*Equipment utilized during excavation:

*TL-26

*TCM

*X331

*17KW

*Subcontractors:

*WMI-landfill

*B. Garcia-trucking

*Granthum-trucking

*Emerald Turf Farm

OHM CORPORATION
PROJECT 19531
GRANITE CITY, IL

QUANTITY SUMMARY FOR 2228 Grand

SPECIAL WASTE (TONS)	BACKFILL (LOADS)	TOPSOIL (TONS)	CA-6 (TONS)	CA-7 (TONS)	SAND (TONS)	SOD CU.YDS.	CONCRETE	OTHER
64.51	5		43.45	13.85		180		

**Sampling Analysis
Project #19531**

0 - 3" Front and Back

Street/Number Address	A		A	
	PPM	No.	PPM	No.
2228 Grand	353	597		
	519	468		

3 - 6" Front and Back

B	B		B	
	PPM	No.	PPM	No.
156		438		

6 - 12" Front and Back

C	C		C	
	PPM	No.	PPM	No.
73		348		

Depth	
Excav.	
(inch)	

3

GR2220

GR2226

GR2228

GR2234

MA2229

Driveway

Gravel

131

132

133

B2 13 ft E of House
18 ft S of House

50% 9.1 Paid + House

1

2

3

Action Date: 4/21/98

Loadout: 4/22/98

Restoration Begins: 4/22/98

Restoration Completed: 5/13/98

*Stack emission sites were not sampled for verification due to the fact that a pre-determined depth for excavation was given to OHM by USACE.

*An excavation depth of 3 inches was established by USACE prior to work commencing.

*The excavation of special waste yielded a total of 50.88 cubic yards, which was shipped to WMI-Milam for disposal.

*Equipment utilized during excavation:

*TL-26

*TCM

*X331

*17-KW

*Subcontractors:

*WMI-landfill

*B. Garcia-trucking

*Grantham-trucking

*Emerald Turf Farm

OHM CORPORATION
PROJECT 19531
GRANITE CITY, IL

QUANTITY SUMMARY FOR 2240/42 Grand

SPECIAL WASTE (TONS)	BACKFILL (LOADS)	TOPSOIL (TONS)	CA-6 (TONS)	CA-7 (TONS)	SAND (TONS)	SOD CU.YDS.	CONCRETE	OTHER
66.15	3		29.2	14.2		360		

Sampling Analysis
Project #19531

0 - 3" Front and Back

	A	A	A
Street/Number	PPM	PPM	PPM
Address	No.	No.	No.

3 - 6" Front and Back

B	B	B
PPM	PPM	PPM
No.	No.	No.

6 - 12" Front and Back

C	C	C
PPM	PPM	PPM
No.	No.	No.

Depth
Excav.
(inch)

3

363 330

475 491

837 423


2240/42 Grand

248

GR2246

GR2240
GR2242

GR2238

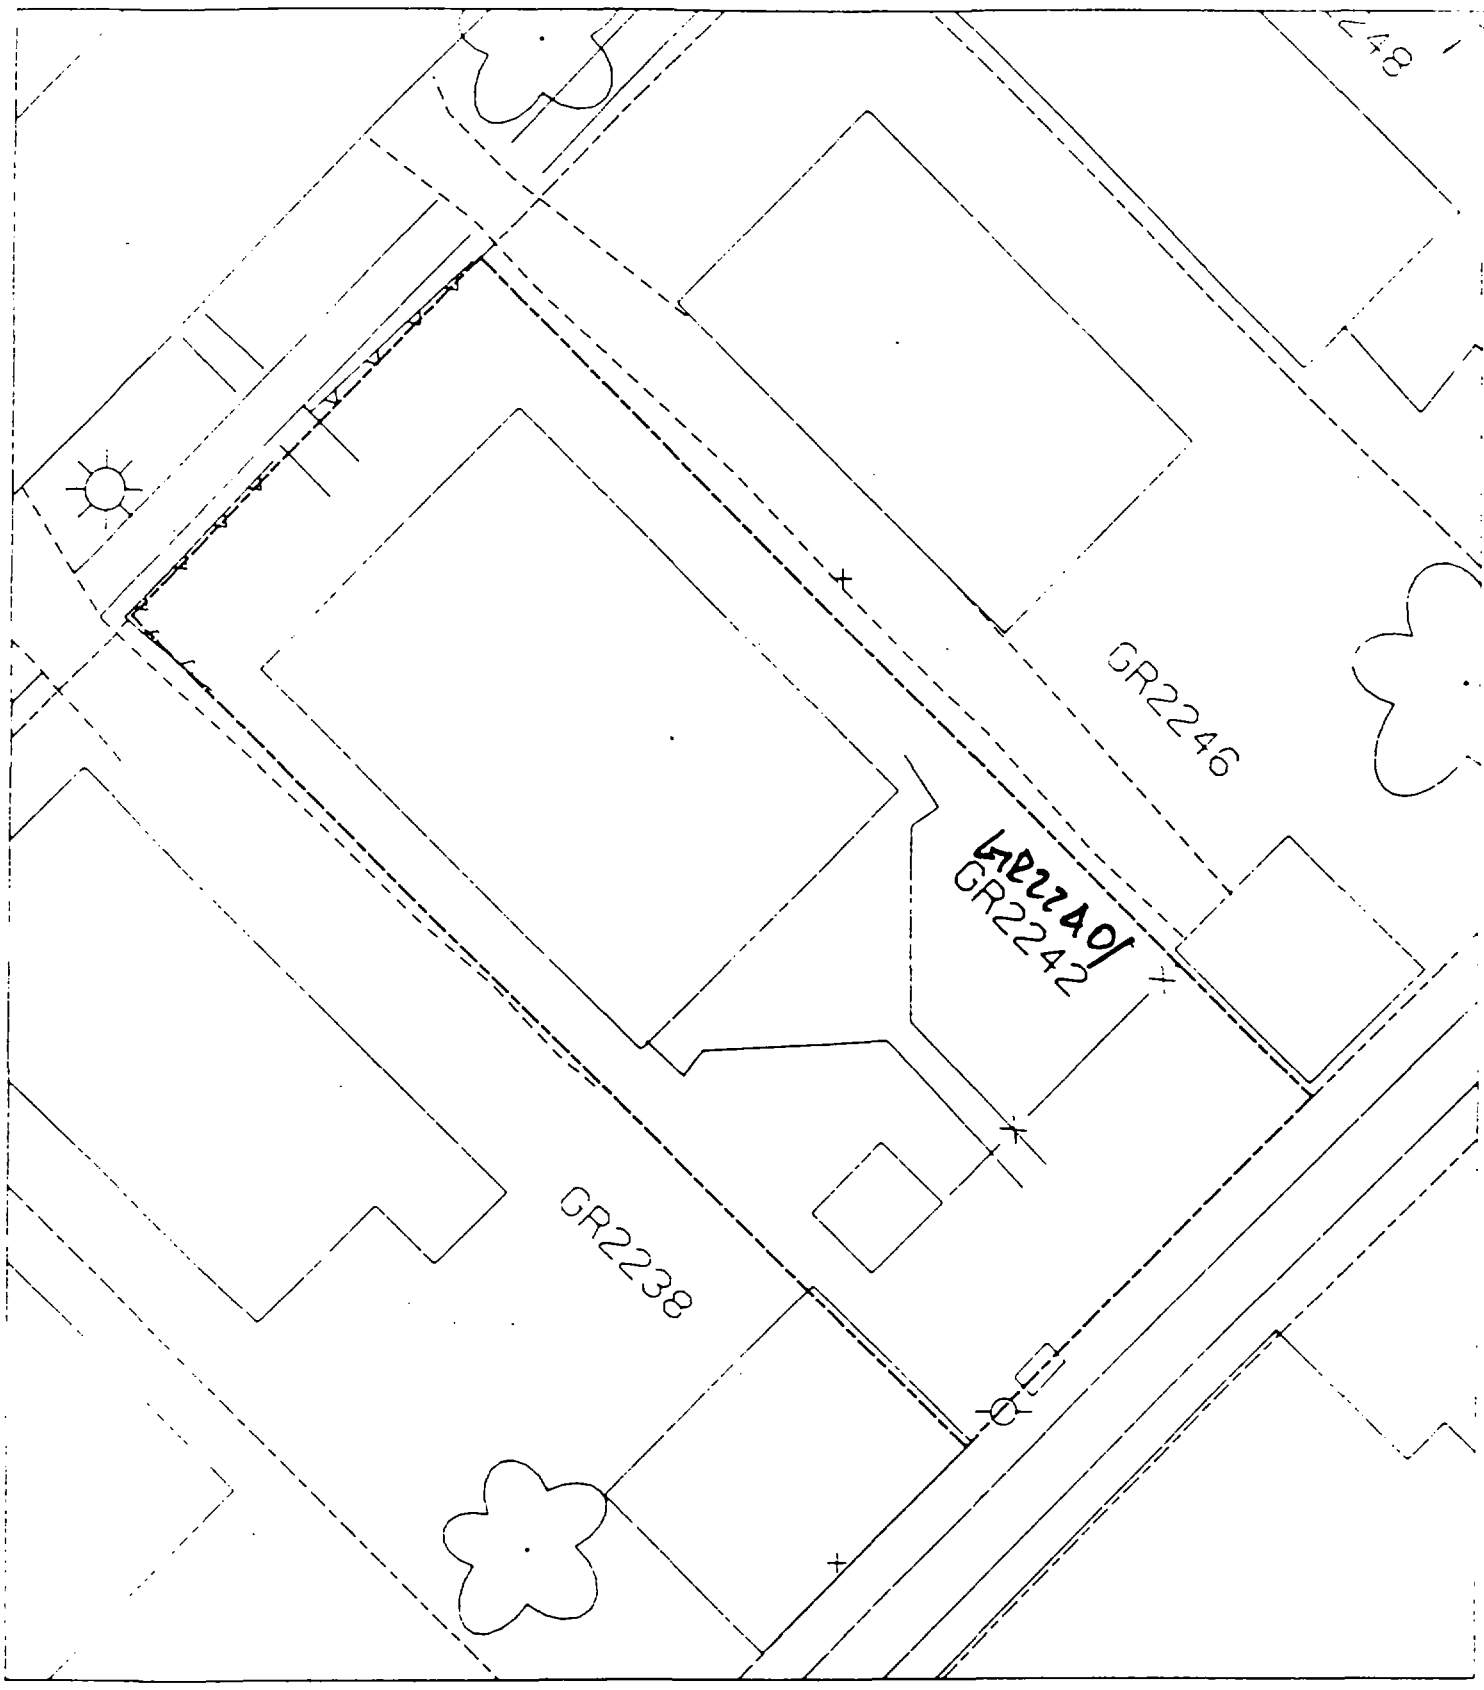

—

—

—

2246 Grand

Action Date: 4/11/98

Loadout: 4/13/98

Restoration Begins: 4/13/98

Restoration Completed: 4/23/98

*Stack emission sites were not sampled for verification due to the fact that a pre-determined depth for excavation was given to OHM by USACE.

*An excavation depth of 6 inches was established by USACE prior to work commencing.

*The excavation of special waste yielded a total of 64.99 cubic yards, which was shipped to WMI-Milam for disposal.

*Equipment utilized during excavation:

*TL-26

*TCM

*X331

*17KW

*Subcontractors:

*WMI-landfill

*B. Garcia-trucking

*Granthum-trucking

*Schneider Turf Farm

OHM CORPORATION
PROJECT 19531
GRANITE CITY, IL

QUANTITY SUMMARY FOR 2246 Grand

SPECIAL WASTE (TONS)	BACKFILL (LOADS)	TOPSOIL (TONS)	CA-6 (TONS)	CA-7 (TONS)	SAND (TONS)	SOD CU.YDS.	CONCRETE	OTHER
84.49	6.5					300		

**Sampling Analysis
Project #19531**

0 - 3" Front and Back

Street/Number Address	A		A	
	PPM	No.	PPM	No.
2246 Grand	783	1510		


3 - 6" Front and Back

B	B		B	
	PPM	No.	PPM	No.
356	800	909		
287	699			

6 - 12" Front and Back

C	C		C	
	PPM	No.	PPM	No.
162	101			

Depth	
Excav.	(inch)
	6

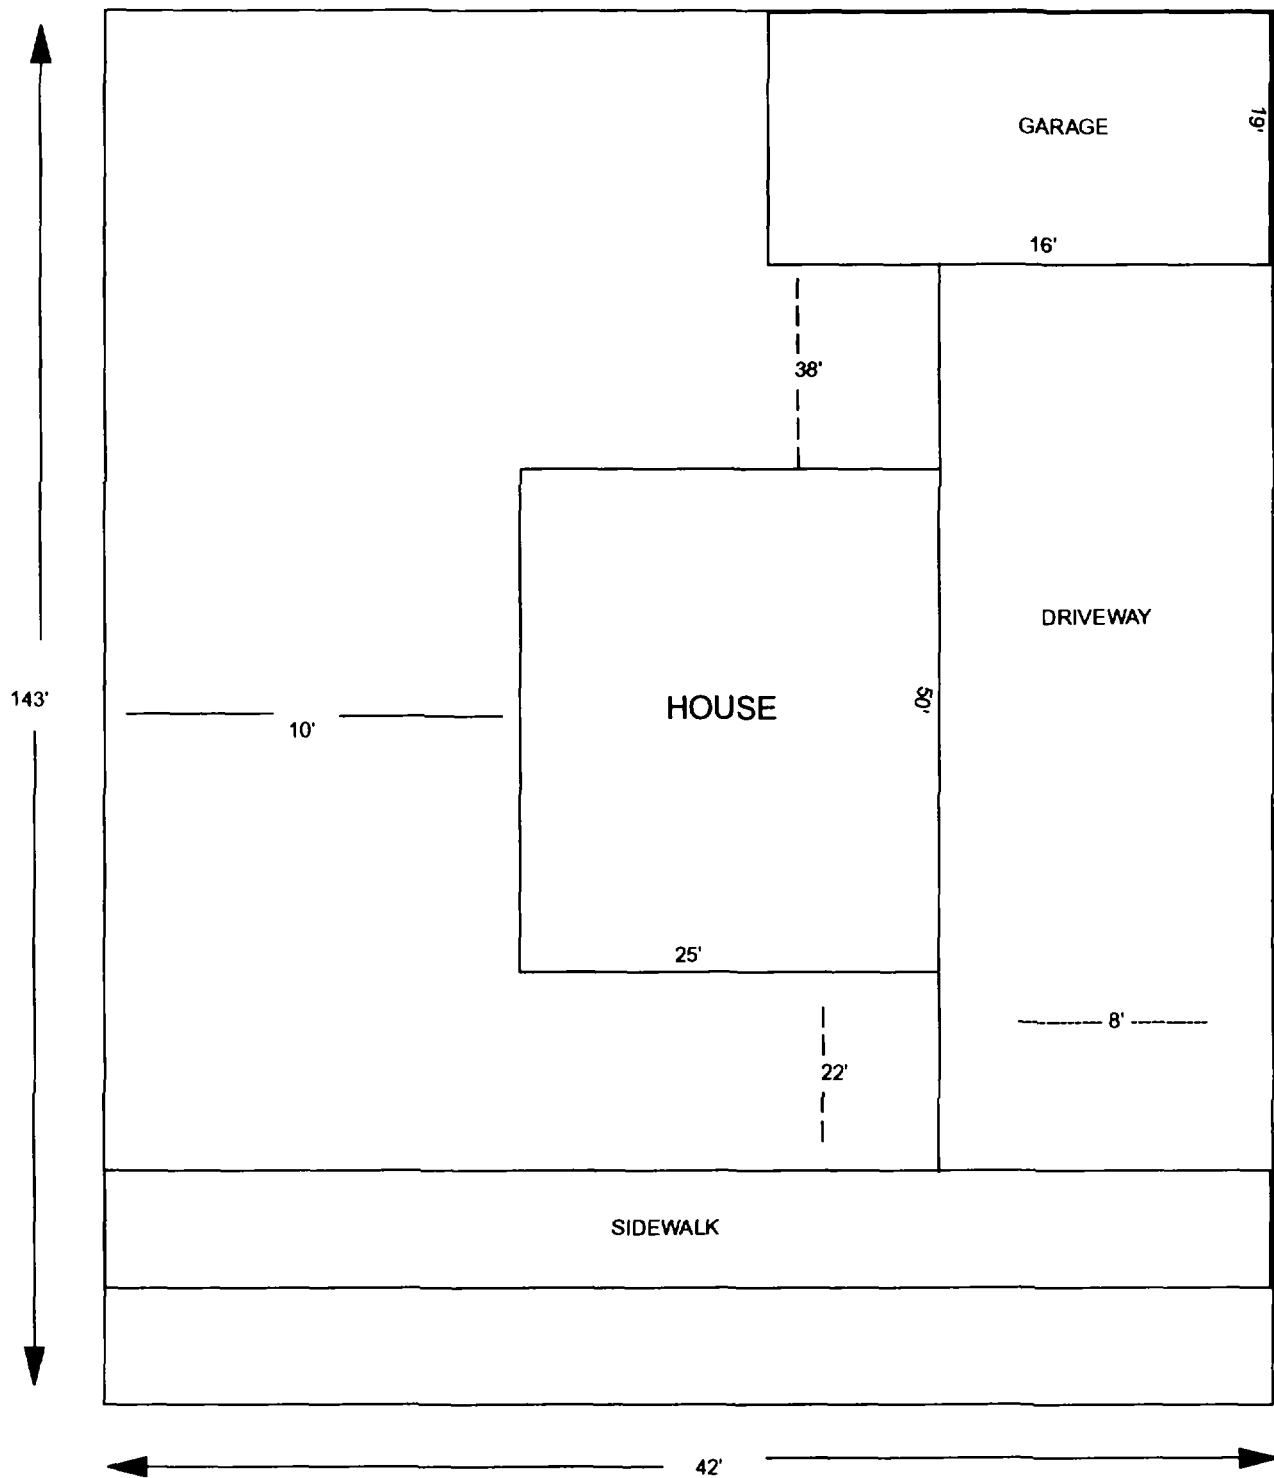

2246 GRAND

		OHM Corporation Findlay, Ohio	
		Drawn By: MTB	Checked By:
		Date: 4/19/96	Approved By:
		Scale: NTS	Drawing No:

928 Greenwood

Action Date: 7/29/97

Loadout: 7/31/97

Restoration Begins: 8/1/97

Restoration Completed: 9/3/97

*Stack emission sites were not sampled for verification due to the fact that a pre-determined depth for excavation was given to OHM by USACE.

*An excavation depth of 6 inches was established by USACE prior to work commencing.

*The excavation of special waste yielded a total of 160.73 cubic yards, which was shipped to WMI-Milam for disposal.

*Equipment utilized during excavation:

*TL-26

*TCM

*X331

*17-KW

*Subcontractors:

*WMI-landfill

*B. Garcia-trucking

*Granthum-trucking

*Emerald Turf Farm

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OHM CORPORATION
PROJECT 19531
GRANITE CITY, IL

QUANTITY SUMMARY FOR 928 Greenwood

SPECIAL WASTE (TONS)	BACKFILL (LOADS)	TOPSOIL (TONS)	CA-6 (TONS)	CA-7 (TONS)	SAND (TONS)	SOD CU.YDS.	CONCRETE	OTHER
208.95	21	140.82		14.6		1140		

**Sampling Analysis
Project #19531**

0 - 3" Front and Back

Street/Number Address	A		A	
	PPM	No.	PPM	No.
928 Greenwood	250	379	4100	469


3 - 6" Front and Back

	B		B	
	PPM	No.	PPM	No.
	340	467	777	243

6 - 12" Front and Back

	C		C	
	PPM	No.	PPM	No.
	380	376	150	173

Depth Excav. (inch)
6

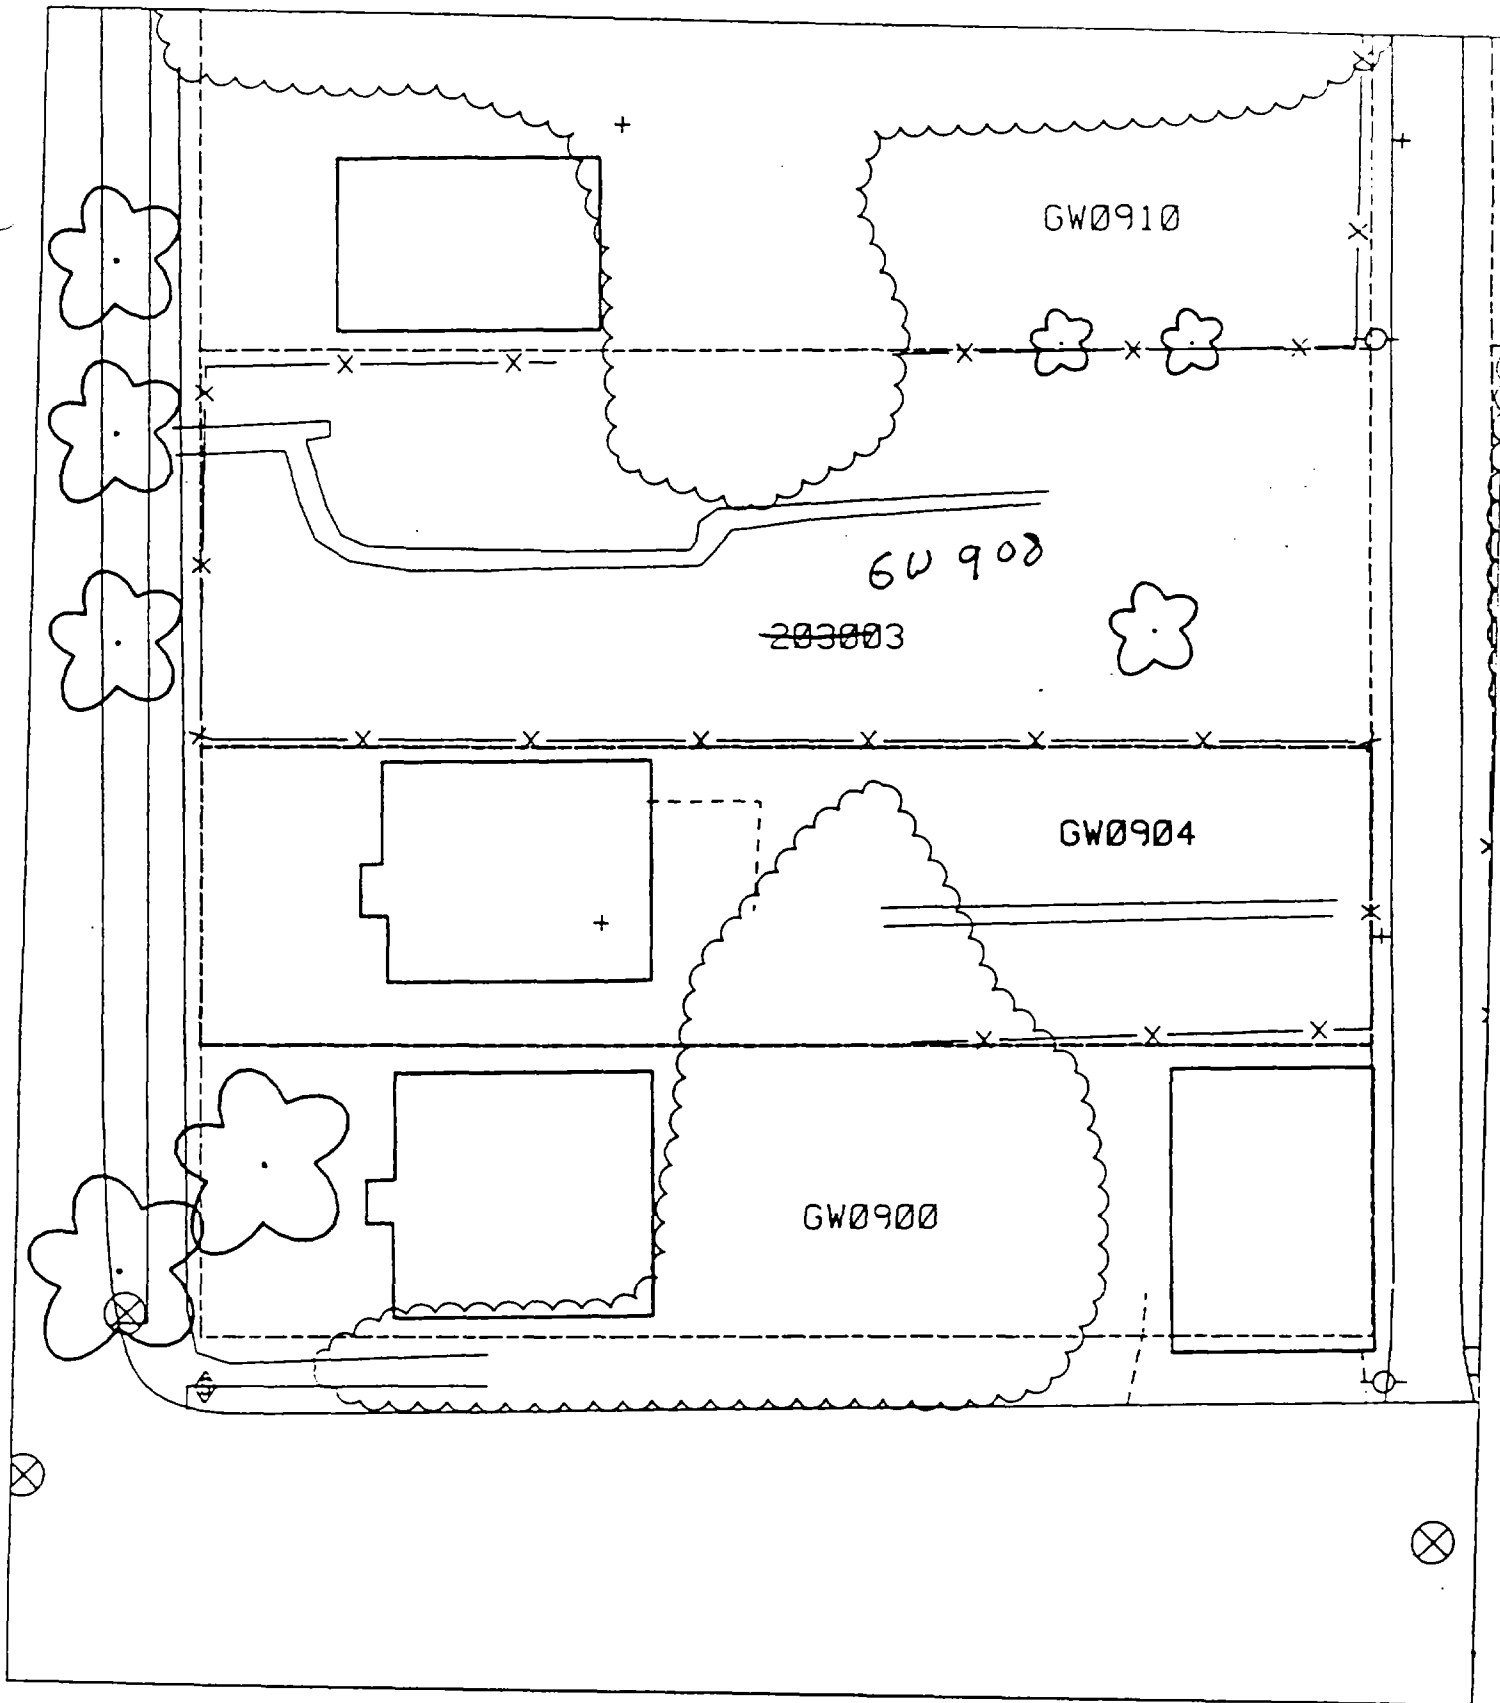

2

3

4

1009 Greenwood

Action Date: 11/18/97

Loadout: 11/20/97

Restoration Begins: 11/20/97

Restoration Completed: 11/25/97

*Stack emission sites were not sampled for verification due to the fact that a pre-determined depth for excavation was given to OHM by USACE.

*An excavation depth of 6 inches was established by USACE prior to work commencing.

*The excavation of special waste yielded a total of 78.13 cubic yards, which was shipped to WMI-Milam for disposal.

*Equipment utilized during excavation:

*TL-26

*TCM

*X331

*17-KW

*Subcontractors:

*WMI-landfill

*B. Garcia-trucking

*Grantham-trucking

*Emerald-turf farm

**OHM CORPORATION
PROJECT 19531
GRANITE CITY, IL**

QUANTITY SUMMARY FOR

1009 Greenwood

SPECIAL WASTE (TONS)	BACKFILL (LOADS)	TOPSOIL (TONS)	CA-6 (TONS)	CA-7 (TONS)	SAND (TONS)	SOD CU.YDS.	CONCRETE	OTHER
101.57	7	50.02	13.4	23.95		420		

**Sampling Analysis
Project #19531**

0 - 3" Front and Back

Street/Number	A		A	
Address	PPM	No.	PPM	No.

1009 Greenwood 460 394

3 - 6" Front and Back

B		B	
PPM	No.	PPM	No.

211 912
534 386


6 - 12" Front and Back

C		C	
PPM	No.	PPM	No.

157 188

Depth
Excav. (inch)

6

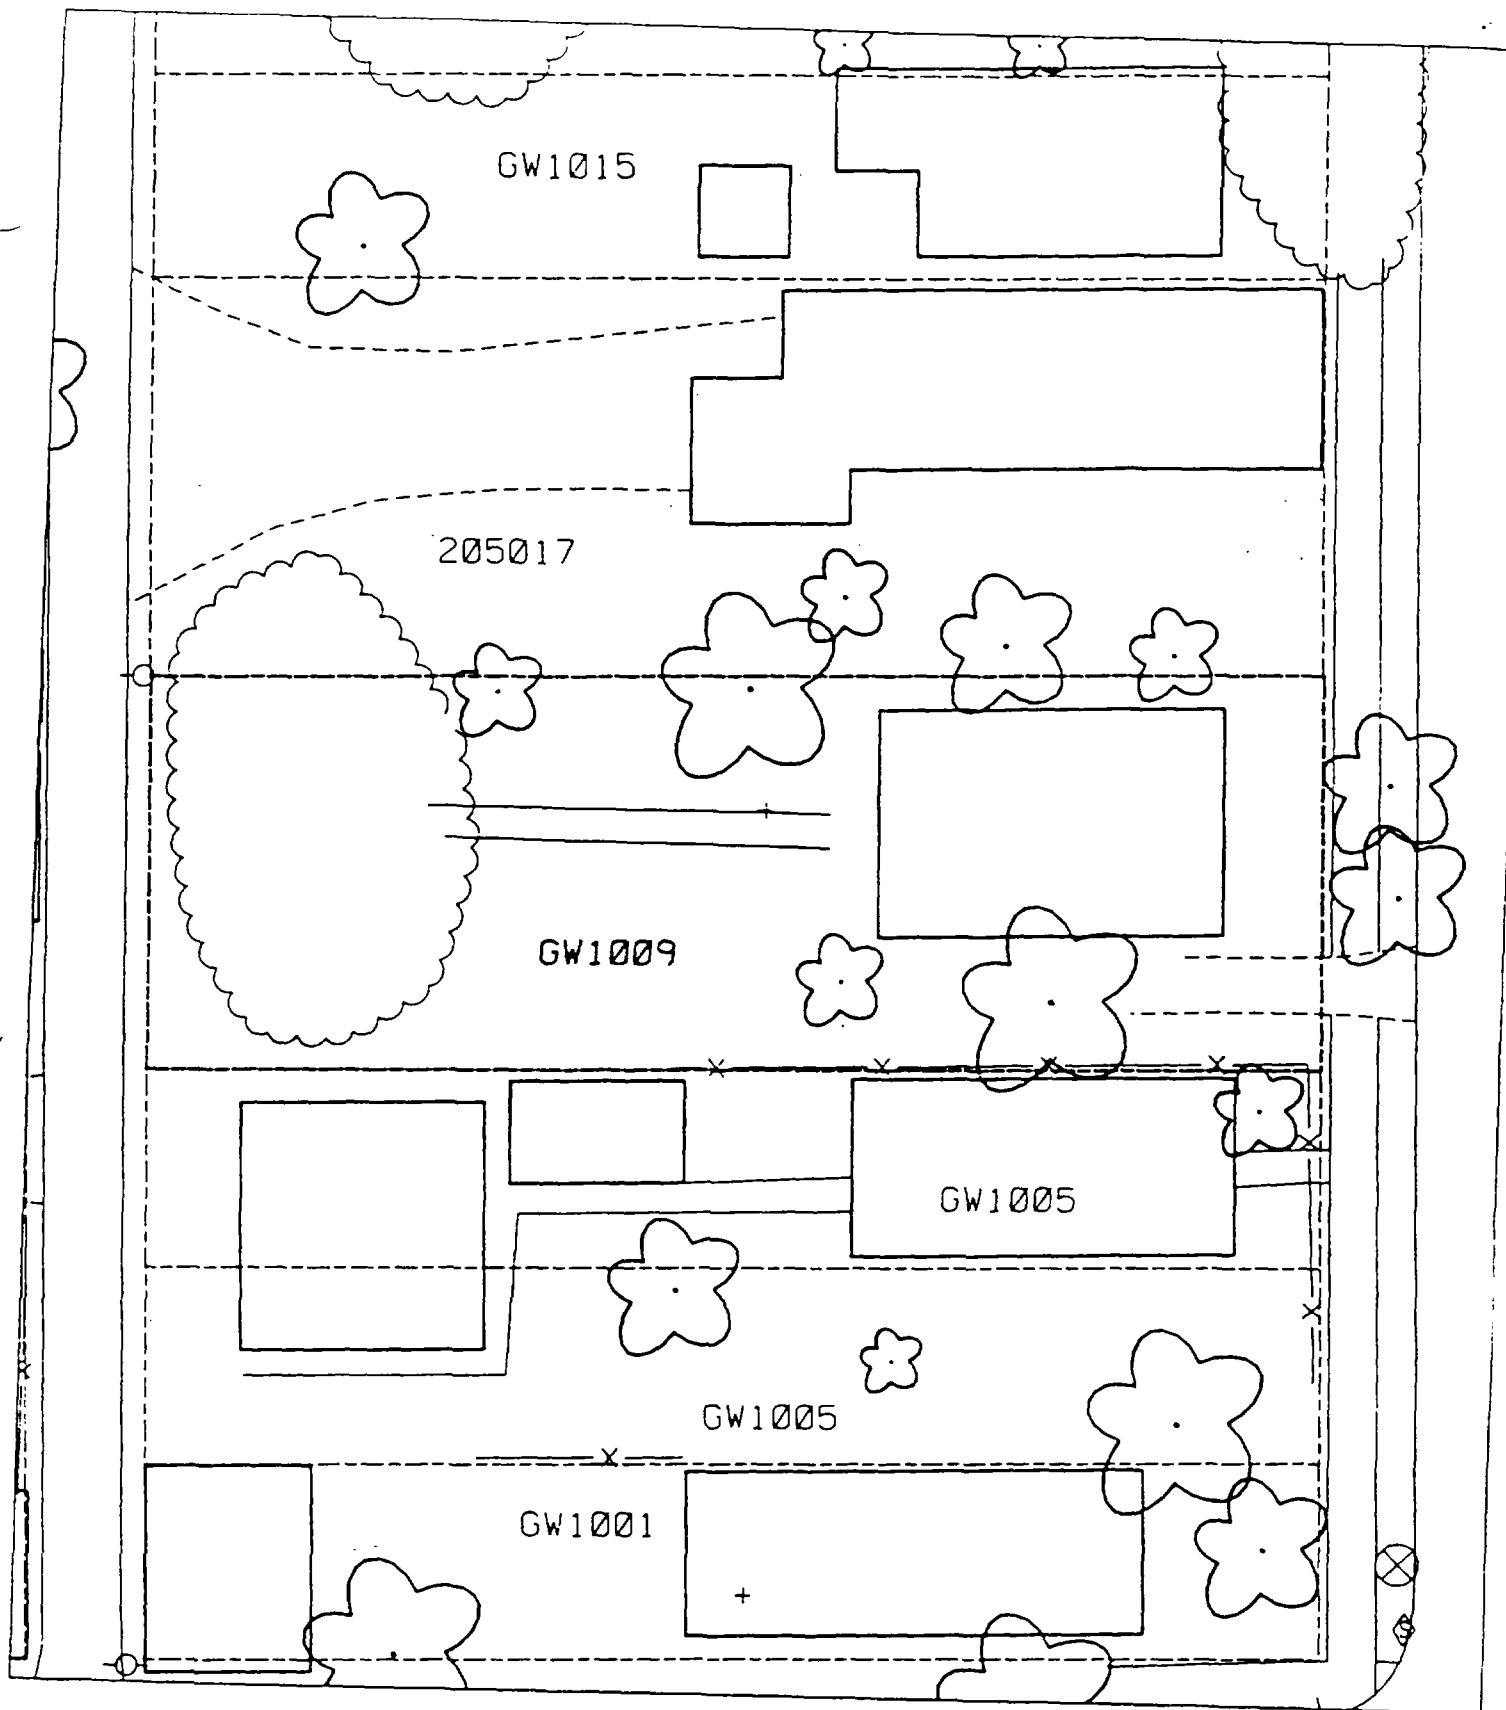

✓

✓

✓

1012 Greenwood

Action Date: 8/27/97

— Loadout: 9/2/97

Restoration Begins: 9/5/97

Restoration Completed: 9/22/97

*Stack emission sites were not sampled for verification due to the fact that a pre-determined depth for excavation was given to OHM by USACE.

*An excavation depth of 6 inches was established by USACE prior to work commencing.

*The excavation of special waste yielded a total of 152.45 cubic yards, which was shipped to WMI-Milam for disposal.

*Equipment utilized during excavation:

*TL-26

*TCM

*X331

*17-KW

*Subcontractors:

*WMI-landfill

*B. Garcia-trucking

*Granthum-trucking

*Schneider Turf Farm

OHM CORPORATION
PROJECT 1953I
GRANITE CITY, IL

QUANTITY SUMMARY FOR 1012 Greenwood

SPECIAL WASTE (TONS)	BACKFILL (LOADS)	TOPSOIL (TONS)	CA-6 (TONS)	CA-7 (TONS)	SAND (TONS)	SOD CU.YDS.	CONCRETE	OTHER
198.19	8	71.32	61.7	51.8		660		

**Sampling Analysis
Project #19531**

0 - 3" Front and Back

Street/Number Address	A		A	
	PPM	No.	PPM	No.
1012 Greenwood	422	450		

3 - 6" Front and Back


B	B		B
	PPM	No.	
	305	709	

6 - 12" Front and Back

C	C		C
	PPM	No.	
	183	827	

Depth Excav. (inch)
6

57 30

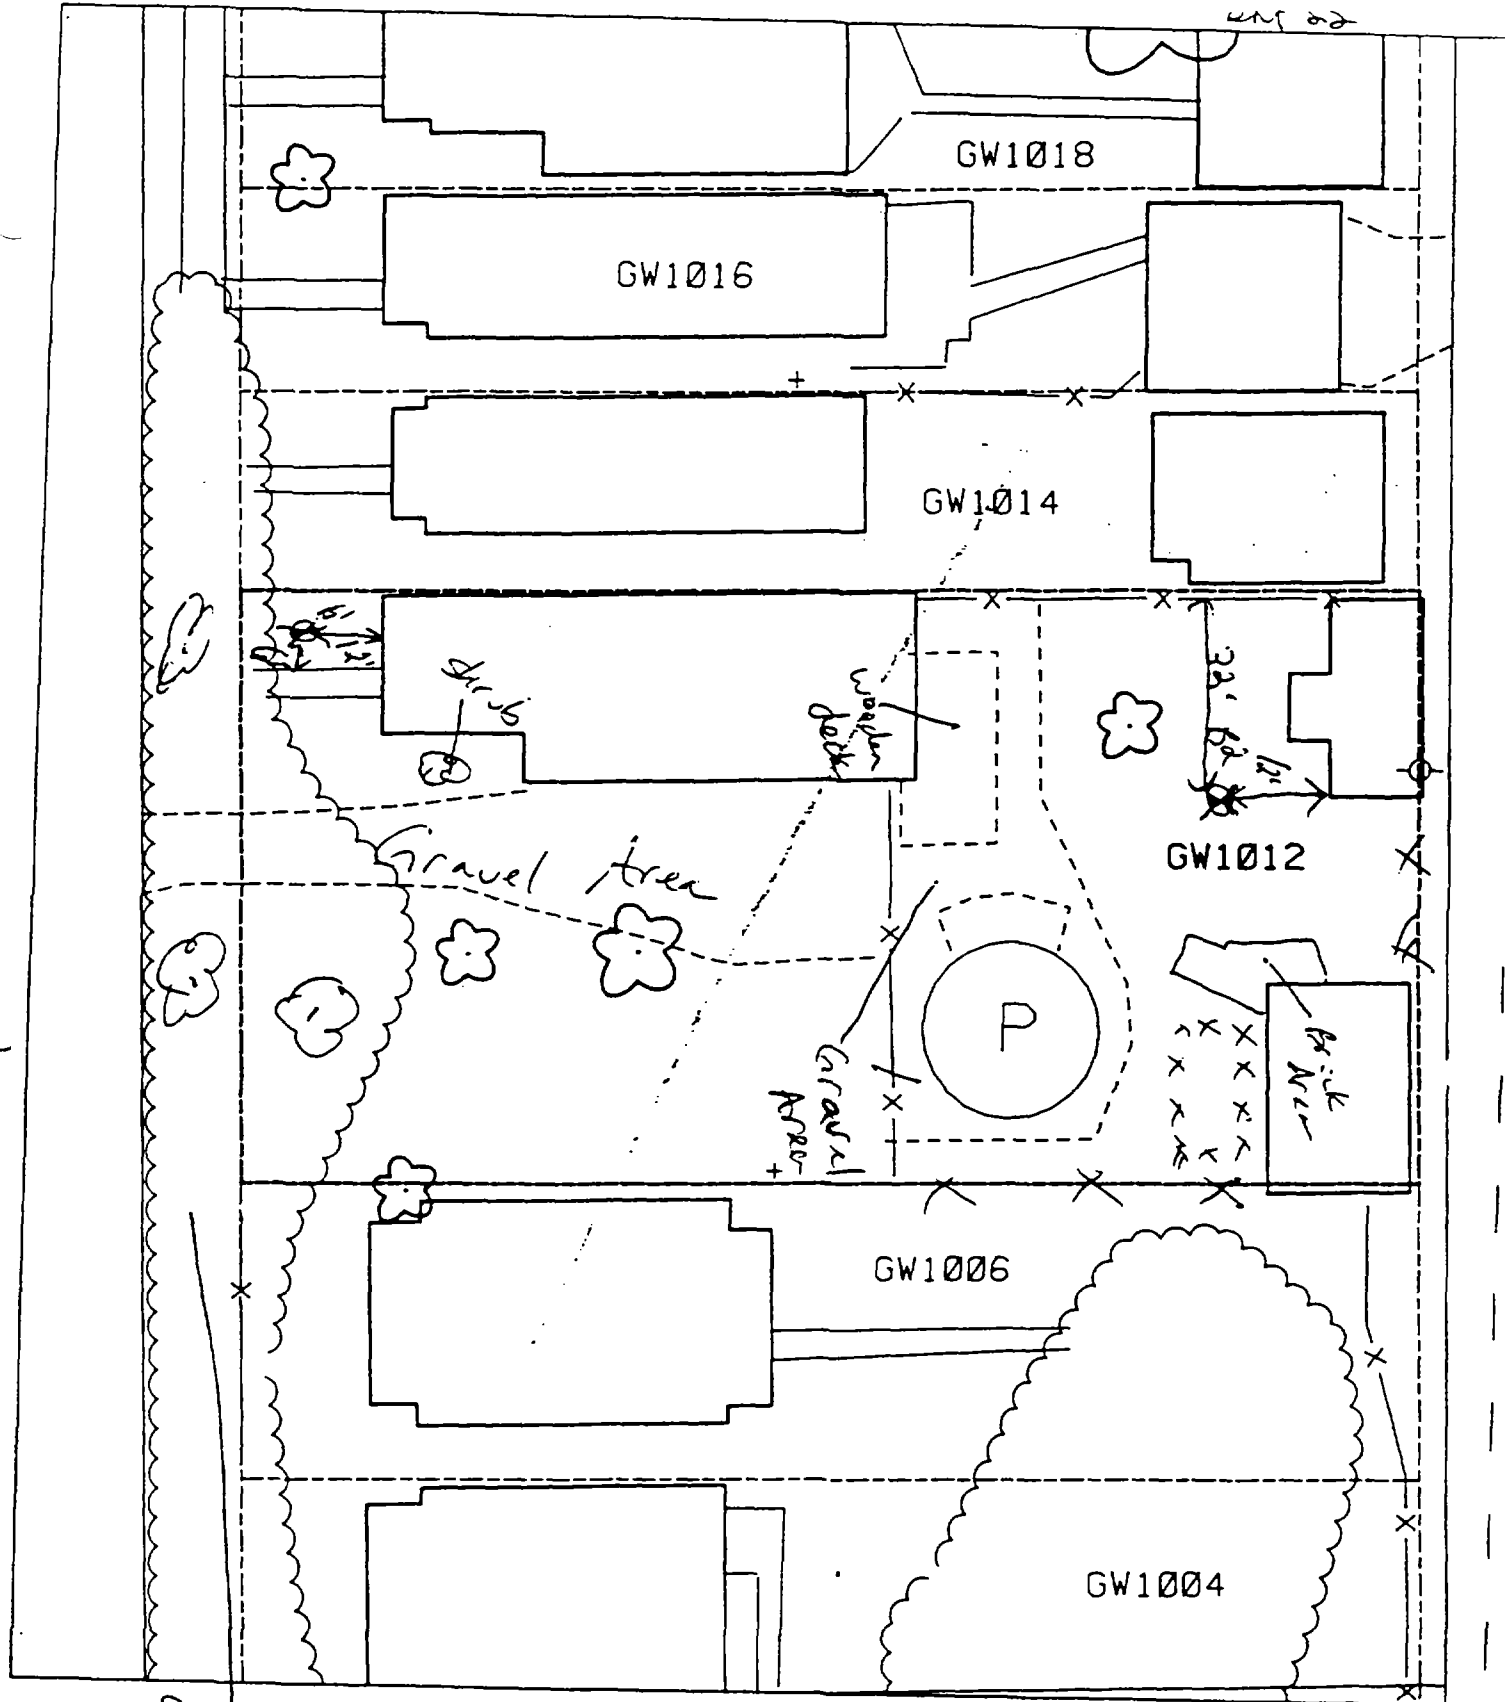

3' - 6' north of sidewalk & 12' west of house.

12' west of shed & 22' south of fence.

Unable to sample gate locked. Could not draw. unable

7% paved + house 60%

179°

1

2

3

1014 Greenwood

Action Date: 8/28/97

— Loadout: 9/10/97

Restoration Begins: 9/10/97

Restoration Completed: 9/22/97

*Stack emission sites were not sampled for verification due to the fact that a pre-determined depth for excavation was given to OHM by USACE.

*An excavation depth of 3 inches was established by USACE prior to work commencing.

*The excavation of special waste yielded a total of 58.76 cubic yards, which was shipped to WMI-Milam for disposal.

*Equipment utilized during excavation:

*TL-26

*TCM

*X331

*17-KW

*Subcontractors:

*WMI-landfill

*B. Garcia-trucking

*Granthum-trucking

*Schneider Turf Farm

OHM CORPORATION
PROJECT 19531
GRANITE CITY, IL

QUANTITY SUMMARY FOR

1014 Greenwood

SPECIAL WASTE (TONS)	BACKFILL (LOADS)	TOPSOIL (TONS)	CA-6 (TONS)	CA-7 (TONS)	SAND (TONS)	SOD CU.YDS.	CONCRETE	OTHER
76.39		36.57				180		

**Sampling Analysis
Project #19531**

0 - 3" Front and Back

	A		A	
Street/Number	PPM	No.	PPM	No.
Address	No.	No.	No.	No.

1014 Greenwood 344 1170
280 463

3 - 6" Front and Back

B	B		B	
PPM	PPM	PPM	PPM	PPM
No.	No.	No.	No.	No.

270 645
660 418


6 - 12" Front and Back

C	C		C	
PPM	PPM	PPM	PPM	PPM
No.	No.	No.	No.	No.

335 469

Depth
Excav.
(inch)

6

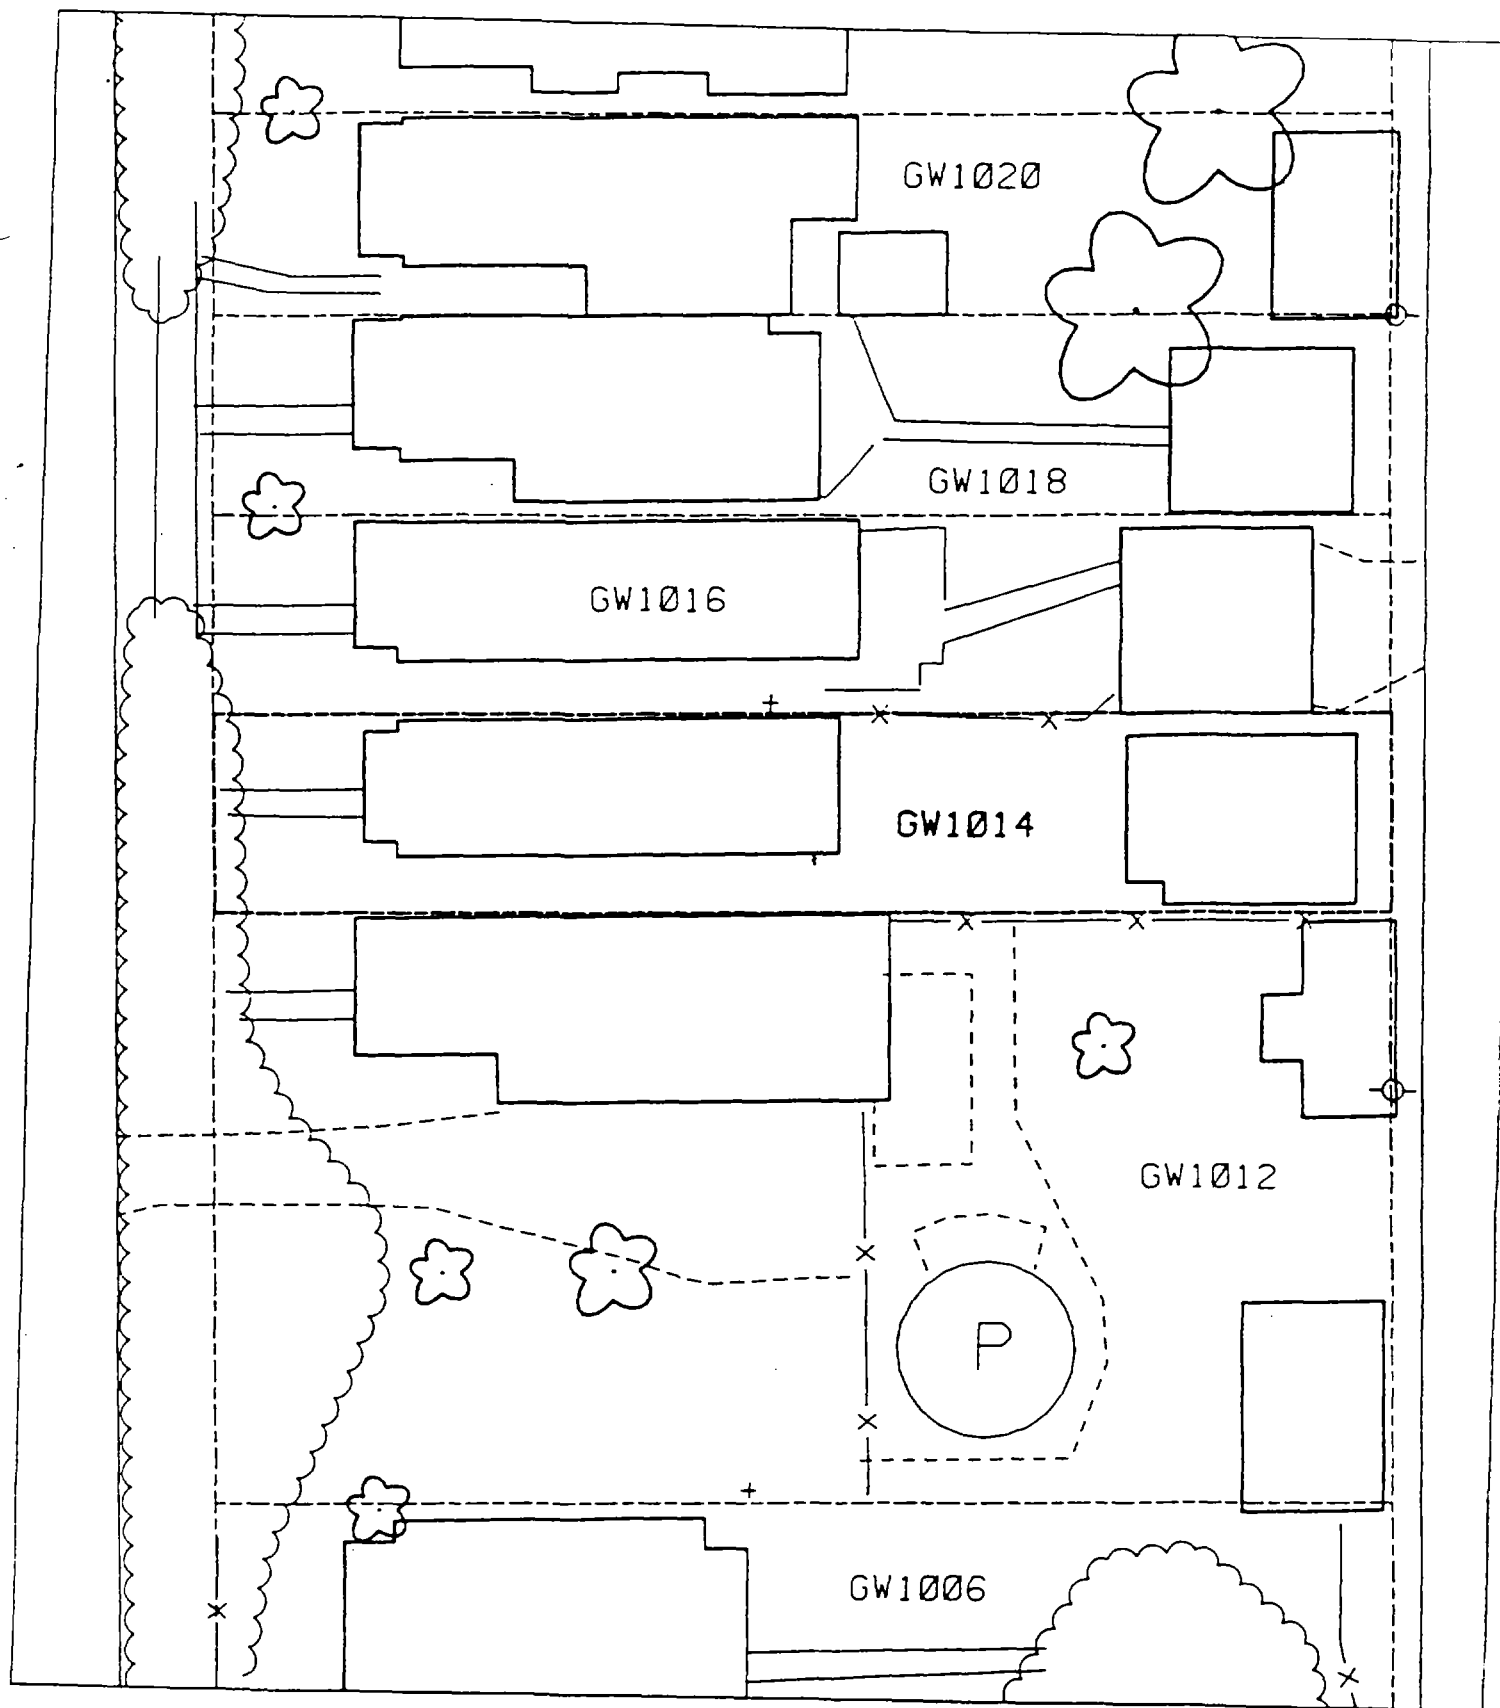

.)

2

.)

.)

1016 Greenwood

Action Date: 8/28/97

Loadout: 9/2/97

Restoration Begins: 9/9/97

Restoration Completed: 9/22/97

*Stack emission sites were not sampled for verification due to the fact that a pre-determined depth for excavation was given to OHM by USACE.

*An excavation depth of 6 inches was established by USACE prior to work commencing.

*The excavation of special waste yielded a total of 50.95 cubic yards, which was shipped to WMI-Milam for disposal.

*Equipment utilized during excavation:

*TL-26

*TCM

*X331

*17-KW

*Subcontractors:

*WMI-landfill

*B. Garcia-trucking

*Granthum-trucking

*Schneider Turf Farm

OHM CORPORATION
PROJECT 19531
GRANITE CITY, IL

QUANTITY SUMMARY FOR 1016 Greenwood

SPECIAL WASTE (TONS)	BACKFILL (LOADS)	TOPSOIL (TONS)	CA-6 (TONS)	CA-7 (TONS)	SAND (TONS)	SOD CU.YDS.	CONCRETE	OTHER
66.24	5	50.61	15.3			180		

**Sampling Analysis
Project #19531**

0 - 3" Front and Back

	A	A	A
Street/Number	PPM	PPM	PPM
Address	No.	No.	No.

1016 Greenwood 457 393

3 - 6" Front and Back

B	B	B
PPM	PPM	PPM
No.	No.	No.

597 375
153 **506**


6 - 12" Front and Back

C	C	C
PPM	PPM	PPM
No.	No.	No.

332 323

Depth
Excav.
(inch)

6

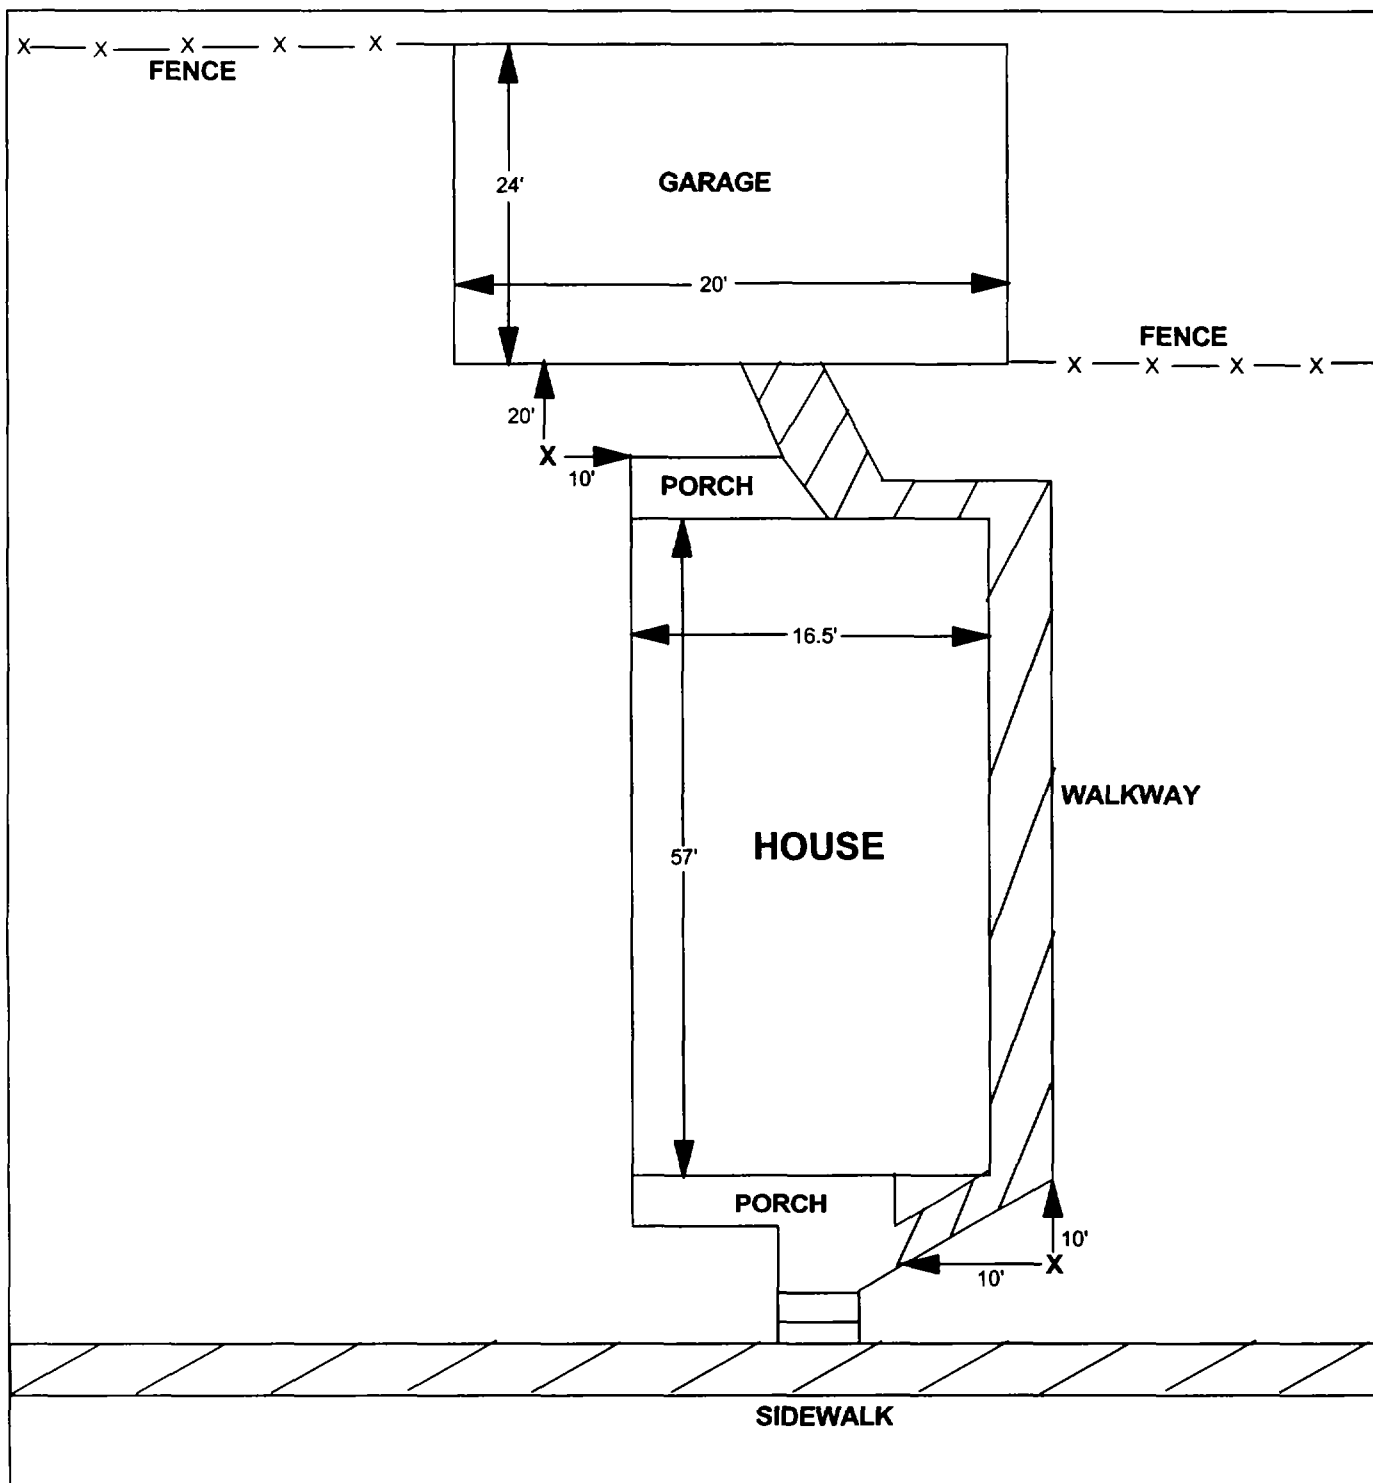

X = SAMPLE POINT

1016 GREENWOOD

**TOTAL
DIMENSIONS
118.5'X24.5'**

OHM 
Corporation
Findlay, Ohio

Drawn By: **JG** Checked By:

Date: 8/20/98 Approved By:

Scale: **NTS** Drawing No:

1

2

3

1019 Greenwood

Action Date: 10/10/97

— Loadout: 10/11/97

Restoration Begins: 10/11/97

Restoration Completed: 10/25/97

*Stack emission sites were not sampled for verification due to the fact that a pre-determined depth for excavation was given to OHM by USACE.

*An excavation depth of 6 inches was established by USACE prior to work commencing.

*The excavation of special waste yielded a total of 88.62 cubic yards, which was shipped to WMI-Milam for disposal.

*Equipment utilized during excavation:

*TL-26

*TCM

*X331

*17-KW

*Subcontractors:

*WMI-landfill

*B. Garcia-trucking

*Granthum-trucking

*Emerald Turf Farm

OHM CORPORATION
PROJECT 19531
GRANITE CITY, IL

QUANTITY SUMMARY FOR

1019 Greenwood

SPECIAL WASTE (TONS)	BACKFILL (LOADS)	TOPSOIL (TONS)	CA-6 (TONS)	CA-7 (TONS)	SAND (TONS)	SOD CU.YDS.	CONCRETE	OTHER
115.21	8	58.36				540		

Sampling Analysis
Project #19531


0 - 3" Front and Back			
Street/Number Address	A	A	A
	PPM	PPM	PPM
	No.	No.	No.

3 - 6" Front and Back			
B	B	B	B
	PPM	PPM	PPM
	No.	No.	No.

6 - 12" Front and Back			
C	C	C	C
	PPM	PPM	PPM
	No.	No.	No.

Depth Excav. (inch)

1019 Greenwood 296 438 425 1410 326 247 6

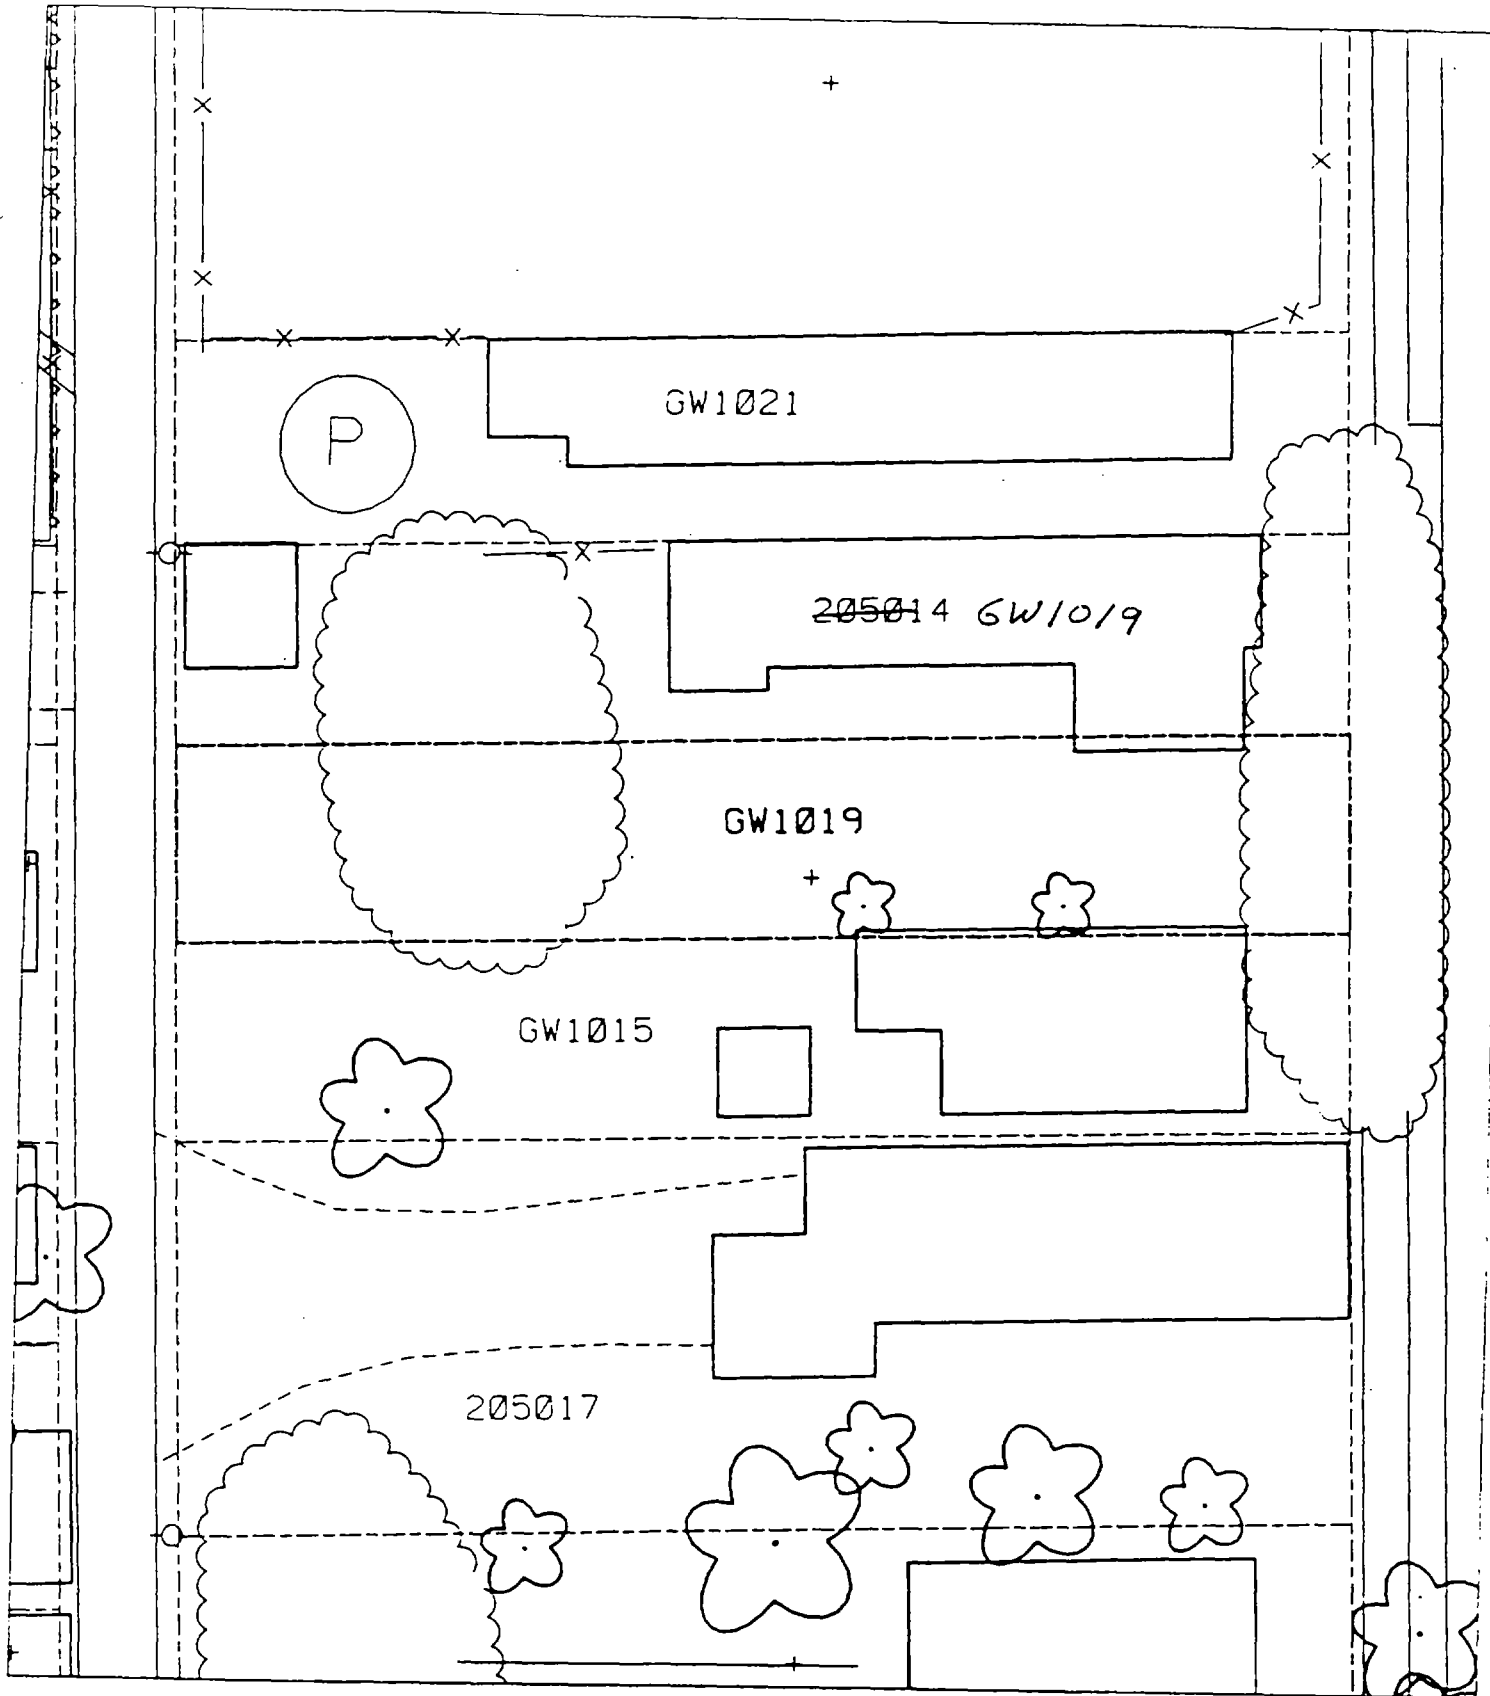

1

2

3

1022 Greenwood

Action Date: 9/13/97

Loadout: 9/16/97

Restoration Begins: 9/16/97

Restoration Completed: 10/17/97

*Stack emission sites were not sampled for verification due to the fact that a pre-determined depth for excavation was given to OHM by USACE.

*An excavation depth of 12 inches was established by USACE prior to work commencing.

*The excavation of special waste yielded a total of 71.03 cubic yards, which was shipped to WMI-Milam for disposal.

*Equipment utilized during excavation:

*TL-26

*TCM

*X331

*17-KW

*Subcontractors:

*WMI-landfill

*B. Garcia-trucking

*Grantham-trucking

*Emerald-turf farm

OHM CORPORATION
PROJECT 19531
GRANITE CITY, IL

QUANTITY SUMMARY FOR

1022 Greenwood

SPECIAL WASTE (TONS)	BACKFILL (LOADS)	TOPSOIL (TONS)	CA-6 (TONS)	CA-7 (TONS)	SAND (TONS)	SOD CU.YDS.	CONCRETE	OTHER
92.35	5	43.91				300		

Sampling Analysis
Project #19531

0 - 3" Front and Back

Street/Number Address	A		A	
	PPM	No.	PPM	No.
1022 Greenwood	291	721	797	1241


3 - 6" Front and Back

B		B	
PPM	No.	PPM	No.
301	2334	206	1229

6 - 12" Front and Back

C		C	
PPM	No.	PPM	No.
310	614	393	498

Depth Excav. (inch)
12

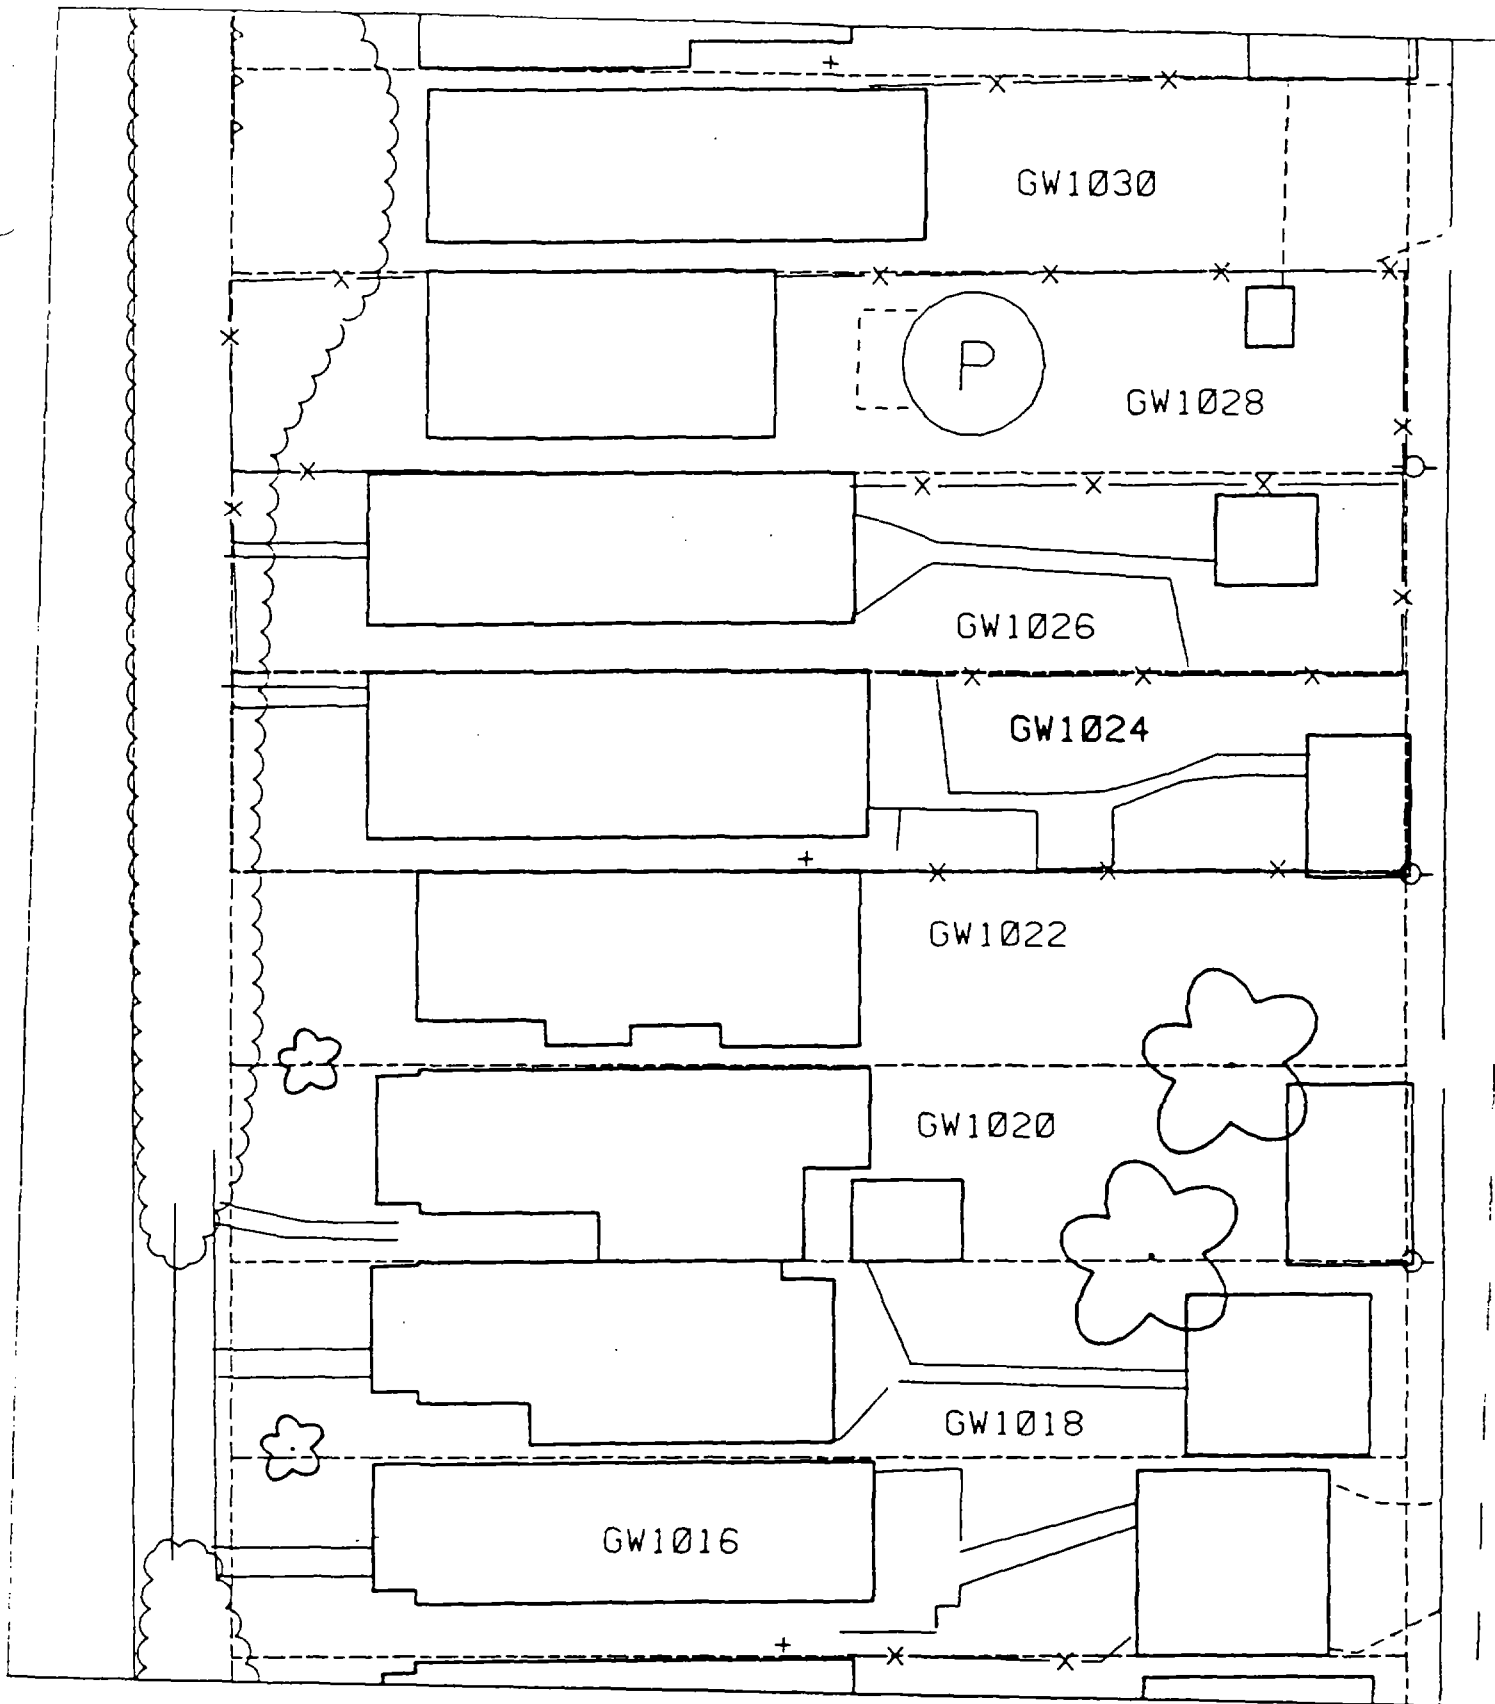

1

2

3

1024 Greenwood

Action Date: 3/14/98

Loadout: 3/23/98

Restoration Begins: 3/23/98

Restoration Completed: 3/27/98

*Stack emission sites were not sampled for verification due to the fact that a pre-determined depth for excavation was given to OHM by USACE.

*An excavation depth of 12 inches was established by USACE prior to work commencing.

*The excavation of special waste yielded a total of 41.85 cubic yards, which was shipped to WMI-Milam for disposal.

*Equipment utilized during excavation:

*TL-26

*TCM

*X331

*17-KW

*Subcontractors:

*WMI-landfill

*B. Garcia-trucking

*Grantham-trucking

*Emerald Turf Farm

OHM CORPORATION
PROJECT 19531
GRANITE CITY, IL

QUANTITY SUMMARY FOR 1024 Greenwood

SPECIAL WASTE (TONS)	BACKFILL (LOADS)	TOPSOIL (TONS)	CA-6 (TONS)	CA-7 (TONS)	SAND (TONS)	SOD CU.YDS.	CONCRETE	OTHER
54.41	6					180		

Sampling Analysis
Project #19531

0 - 3" Front and Back

Street/Number Address	A		A	
	PPM	No.	PPM	No.
1024 Greenwood	226	382		
	261	656		
	250	663		


3 - 6" Front and Back

B		B	
PPM	No.	PPM	No.
243	262		
238	334		

6 - 12" Front and Back

C		C	
PPM	No.	PPM	No.
121	187		
169	521		
196	465		

Depth Excav. (inch)
12

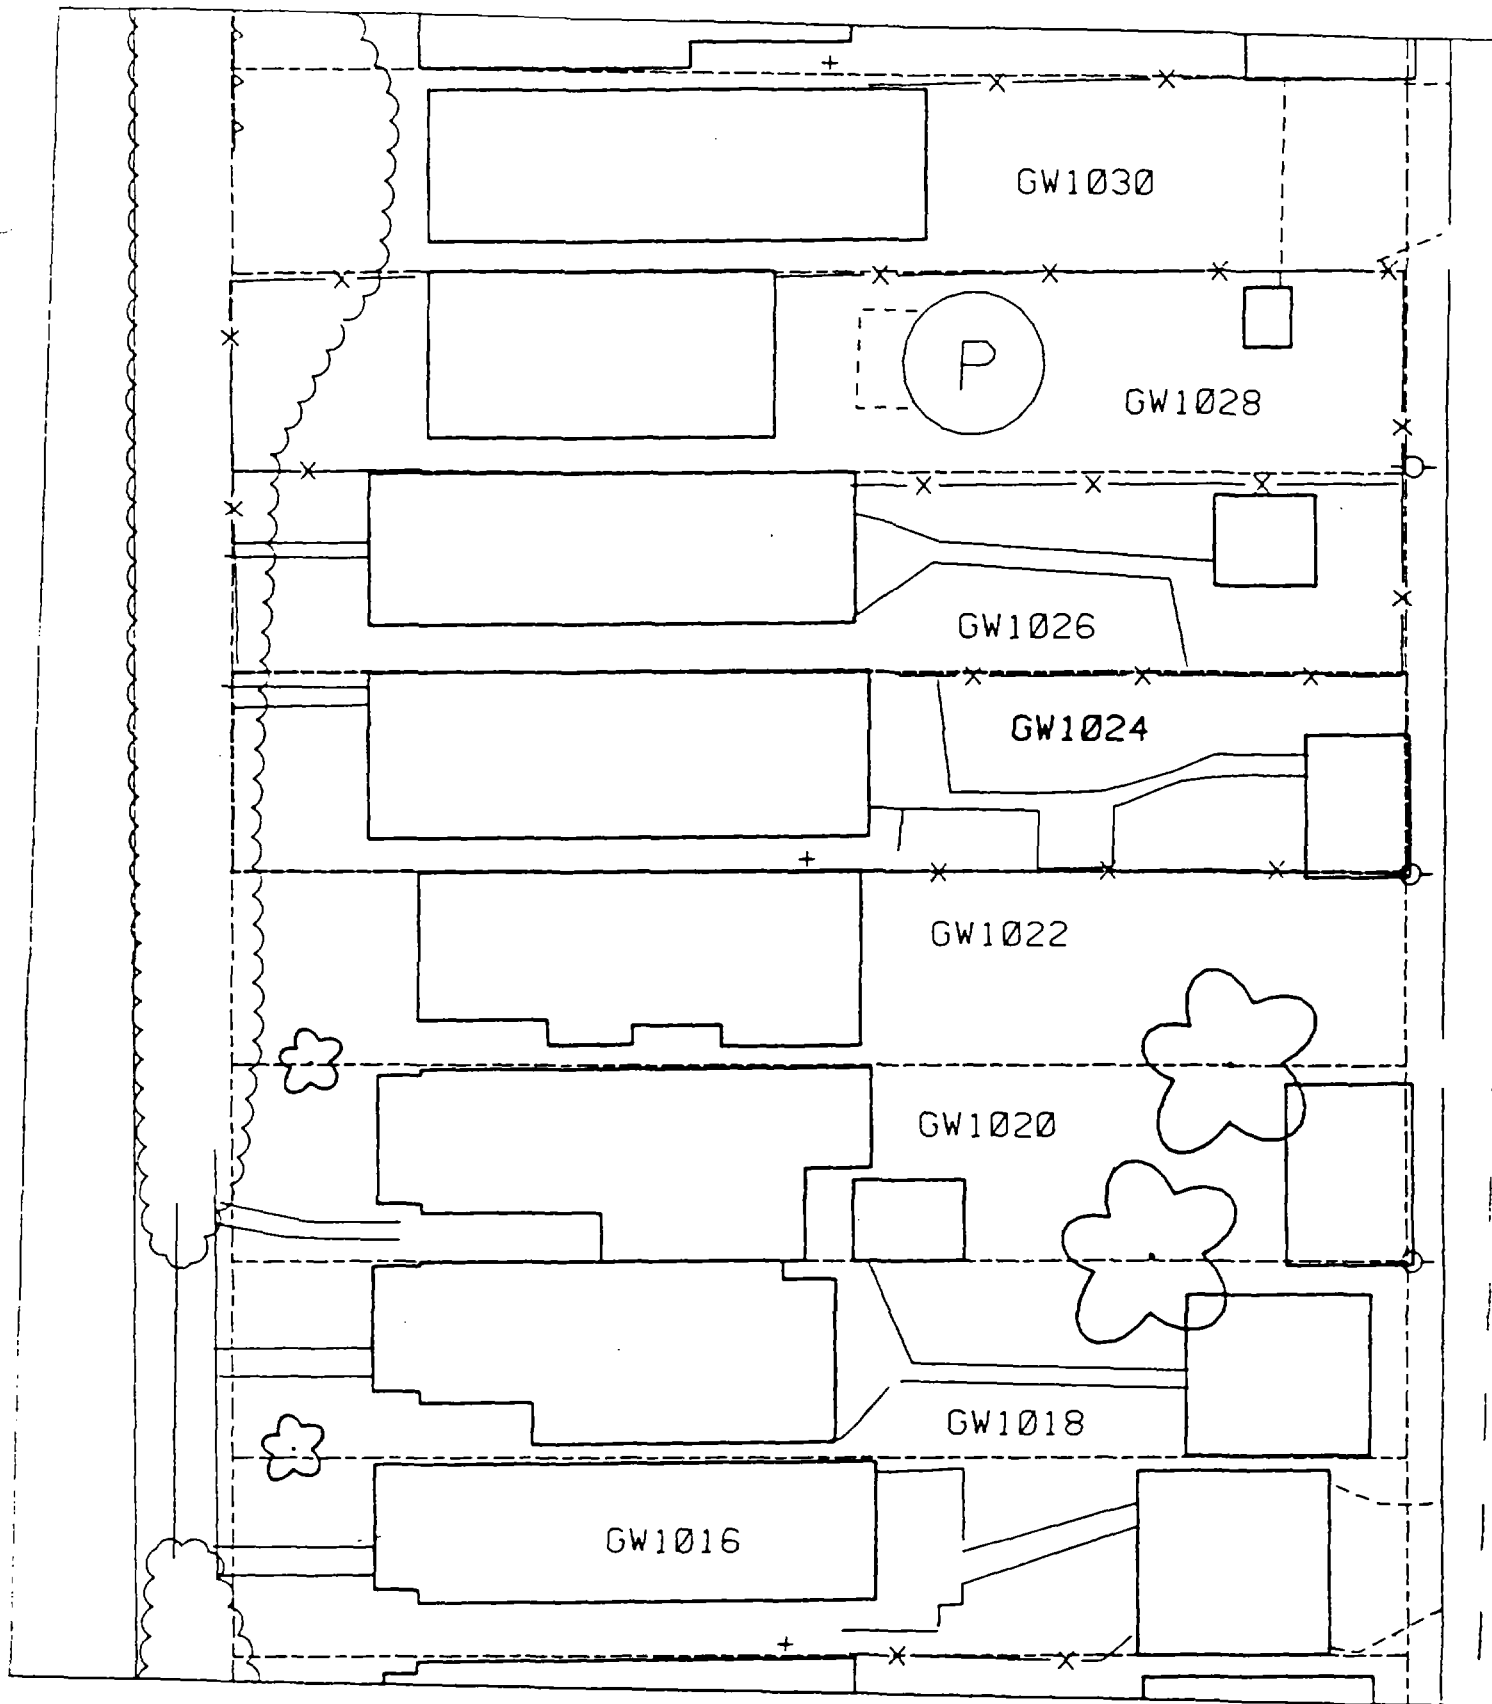

1028 Greenwood

Action Date: 9/18/97

Loadout: 9/20/97

Restoration Begins: 9/22/97

Restoration Completed: 10/17/97

*Stack emission sites were not sampled for verification due to the fact that a pre-determined depth for excavation was given to OHM by USACE.

*An excavation depth of 6 inches was established by USACE prior to work commencing.

*The excavation of special waste yielded a total of 59.79 cubic yards, which was shipped to WMI-Milam for disposal.

*Equipment utilized during excavation:

*TL-26

*TCM

*X331

*17-KW

*Subcontractors:

*WMI-landfill

*B. Garcia-trucking

*Granthum-trucking

*Emerald Turf Farm

OHM CORPORATION
PROJECT 19531
GRANITE CITY, IL

QUANTITY SUMMARY FOR

1028 Greenwood

SPECIAL WASTE (TONS)	BACKFILL (LOADS)	TOPSOIL (TONS)	CA-6 (TONS)	CA-7 (TONS)	SAND (TONS)	SOD CU.YDS.	CONCRETE	OTHER
77.73	4	29.25		14.1		300		

**Sampling Analysis
Project #19531**

0 - 3" Front and Back

Street/Number Address	A		A	
	PPM	No.	PPM	No.
1028 Greenwood	426	198		


3 - 6" Front and Back

B		B	
PPM	No.	PPM	No.
318	1030		
258	356		
441	577		

6 - 12" Front and Back

C		C	
PPM	No.	PPM	No.
139	397		

Depth Excav. (inch)
6

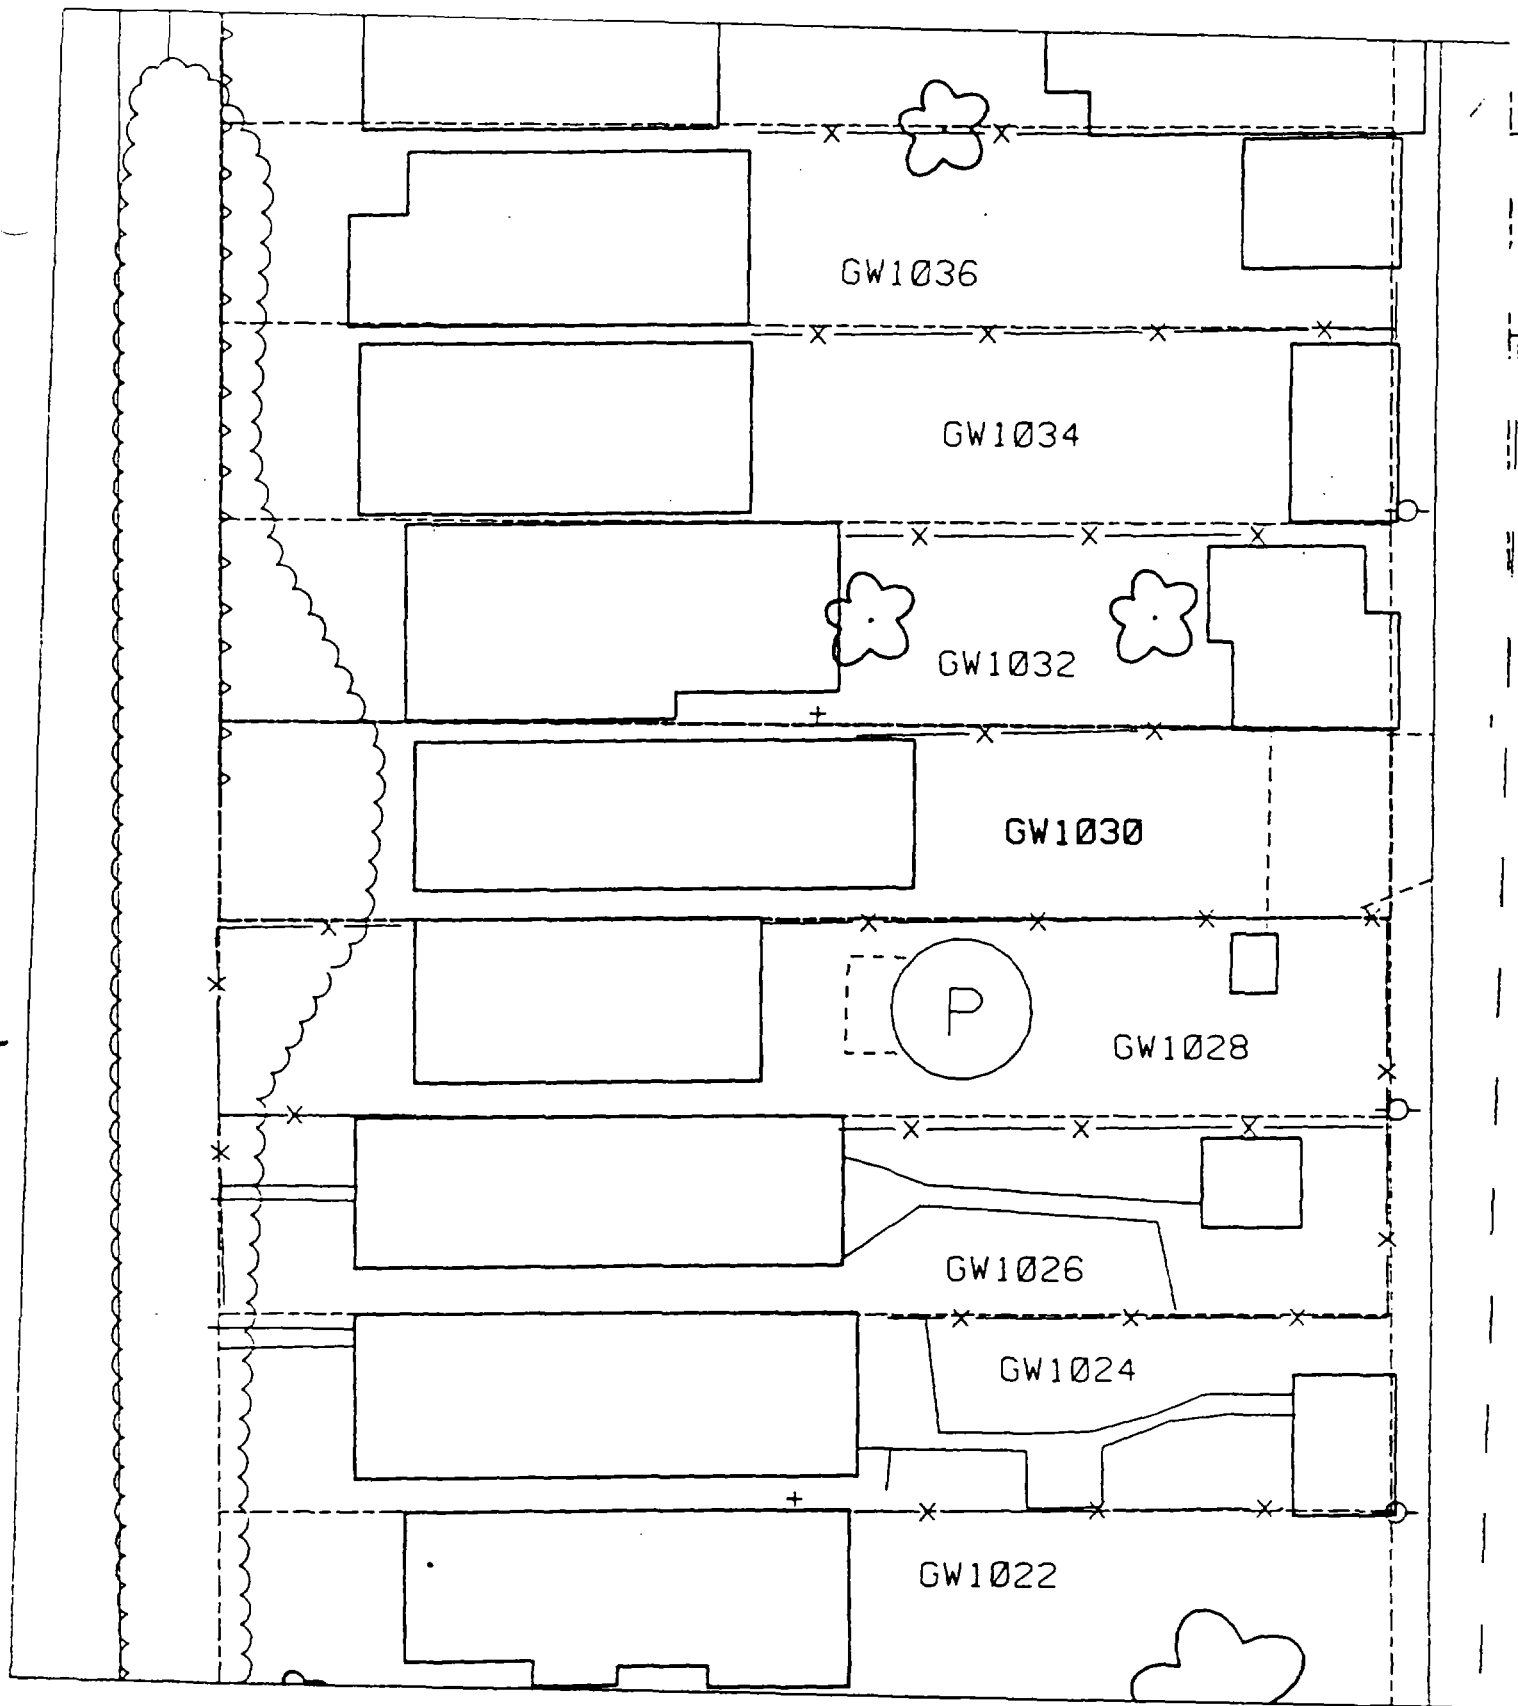

1

2

3

1030 Greenwood

Action Date: 3/25/98

Loadout: 3/27/98

Restoration Begins: 3/27/98

Restoration Completed: 4/9/98

*Stack emission sites were not sampled for verification due to the fact that a pre-determined depth for excavation was given to OHM by USACE.

*An excavation depth of 12 inches was established by USACE prior to work commencing.

*The excavation of special waste yielded a total of 86.10 cubic yards, which was shipped to WMI-Milam for disposal.

*Equipment utilized during excavation:

*TL-26

*TCM

*X331

*17-KW

*Subcontractors:

*WMI-landfill

*B. Garcia-trucking

*Grantham-trucking

*Emerald-turf farm

**OHM CORPORATION
PROJECT 19531
GRANITE CITY, IL**

QUANTITY SUMMARY FOR

1030 Greenwood

SPECIAL WASTE (TONS)	BACKFILL (LOADS)	TOPSOIL (TONS)	CA-6 (TONS)	CA-7 (TONS)	SAND (TONS)	SOD CU.YDS.	CONCRETE	OTHER
111.94	9		28.1	14.2		120		

**Sampling Analysis
Project #19531**

0 - 3" Front and Back

Street/Number Address	A		A	
	PPM	No.	PPM	No.
1030 Greenwood	76	886		
	156	636		

3 - 6" Front and Back


	B		B	
	PPM	No.	PPM	No.
	53	1920		
	272	561		

6 - 12" Front and Back

	C		C	
	PPM	No.	PPM	No.
	91	1535		
	217	488		

Depth	
Excav.	
(inch)	

12

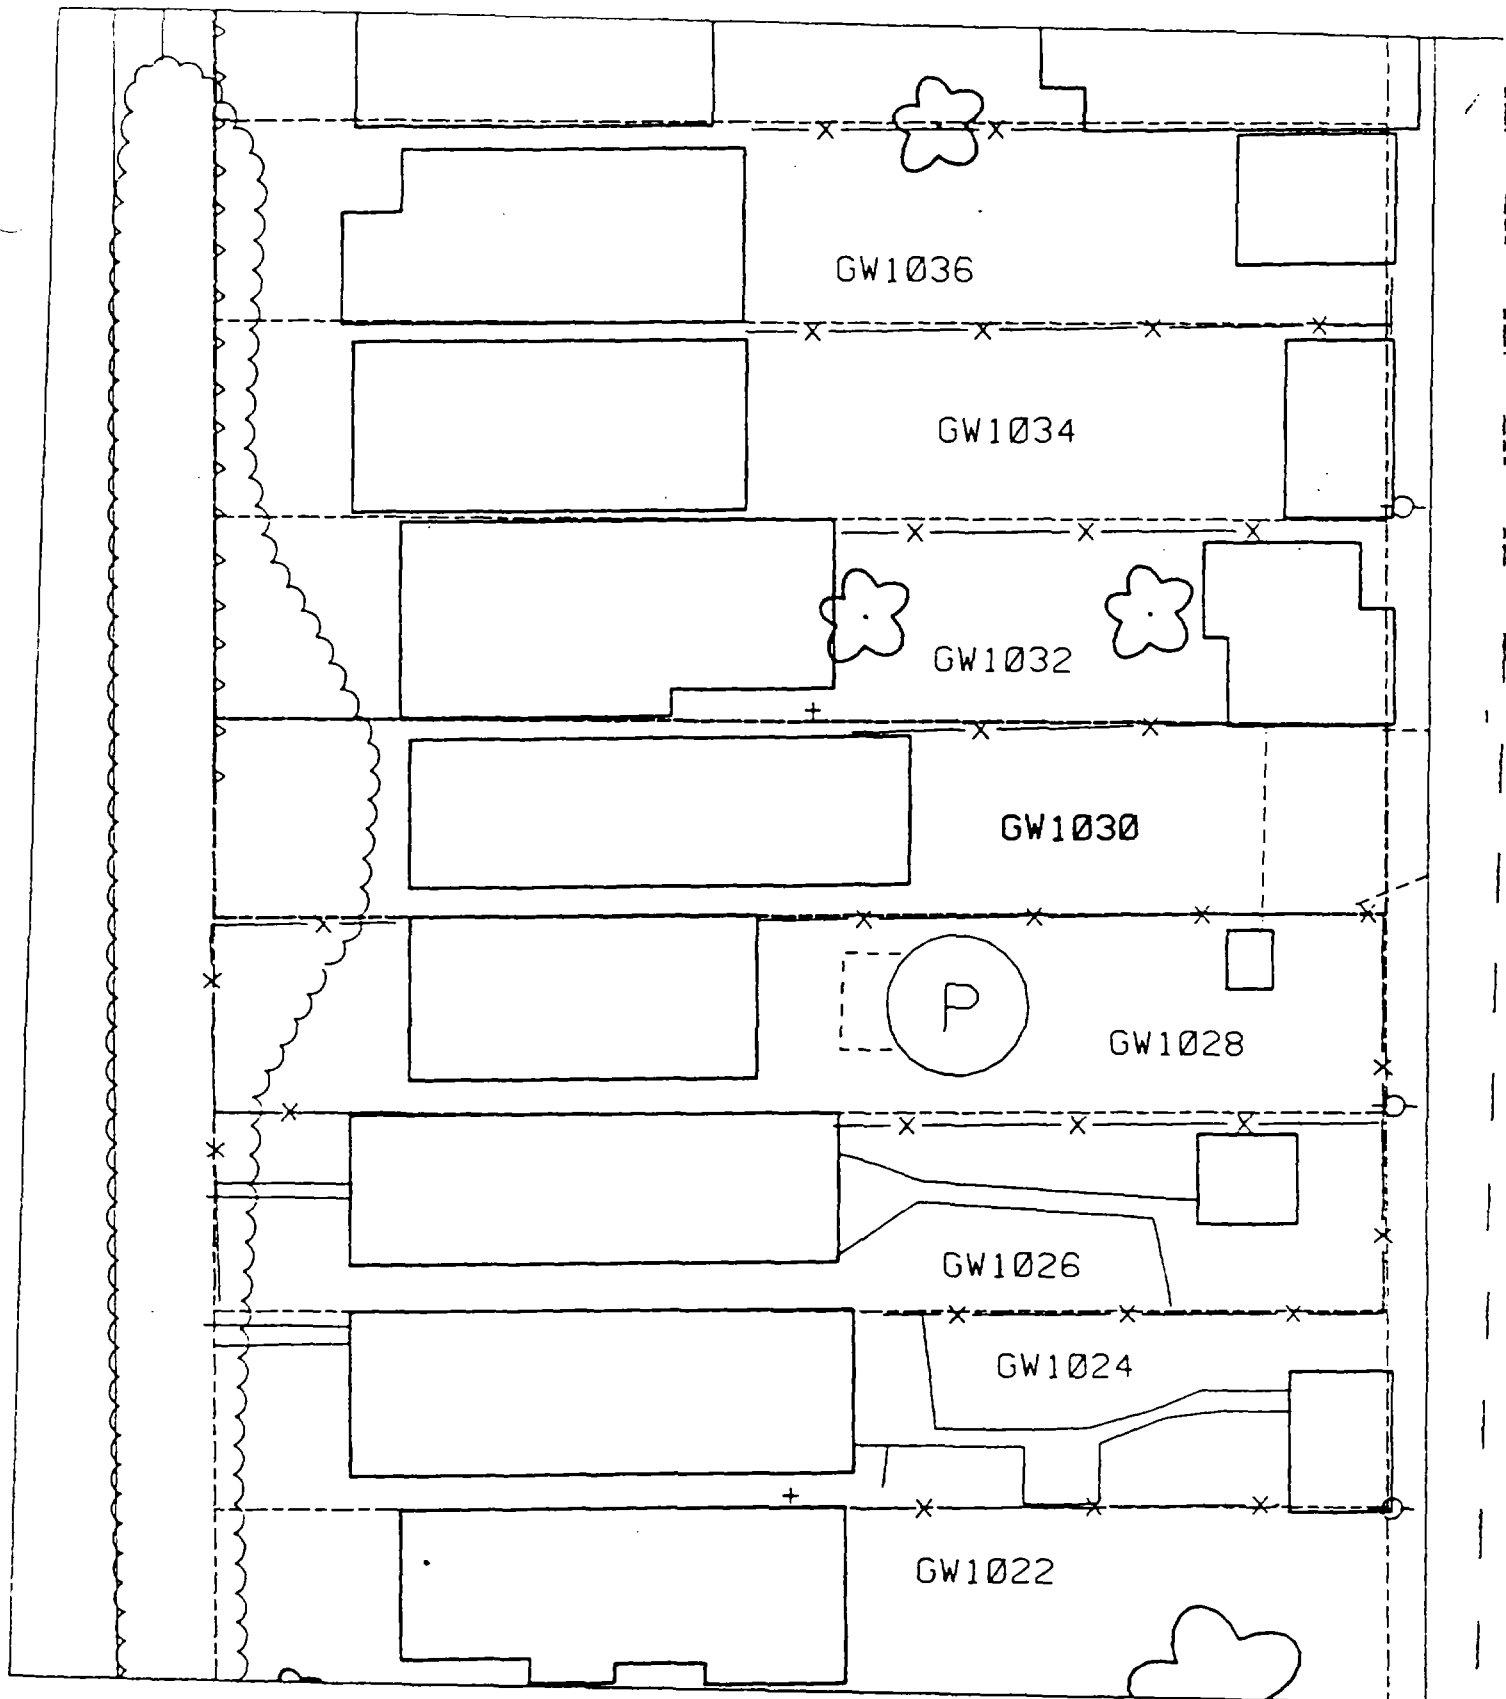

✓

✓

✓

1032 Greenwood

Action Date: 9/24/97

Loadout: 9/25/97

Restoration Begins: 9/25/97

Restoration Completed: 10/17/97

*Stack emission sites were not sampled for verification due to the fact that a pre-determined depth for excavation was given to OHM by USACE.

*An excavation depth of 3 inches was established by USACE prior to work commencing.

*The excavation of special waste yielded a total of 28.82 cubic yards, which was shipped to WMI-Milam for disposal.

*Equipment utilized during excavation:

*TL-26

*TCM

*X331

*17-KW

*Subcontractors:

*WMI-landfill

*B. Garcia-trucking

*Grantham-trucking

*Emerald-turf farm

OHM CORPORATION
PROJECT 19531
GRANITE CITY, IL

QUANTITY SUMMARY FOR

1032 Greenwood

SPECIAL WASTE (TONS)	BACKFILL (LOADS)	TOPSOIL (TONS)	CA-6 (TONS)	CA-7 (TONS)	SAND (TONS)	SOD CU.YDS.	CONCRETE	OTHER
37.47		25.4	13.1			240		

**Sampling Analysis
Project #19531**

0 - 3" Front and Back				
Street/Number Address	A		A	
	PPM	No.	PPM	No.
	No.		No.	

3 - 6" Front and Back				
B	B		B	
	PPM	No.	PPM	No.
	No.		No.	

6 - 12" Front and Back				
C	C		C	
	PPM	No.	PPM	No.
	No.		No.	


Depth	
Excav.	
(inch)	

1032 Greenwood 504 318
535 462

279 219

200 169

3

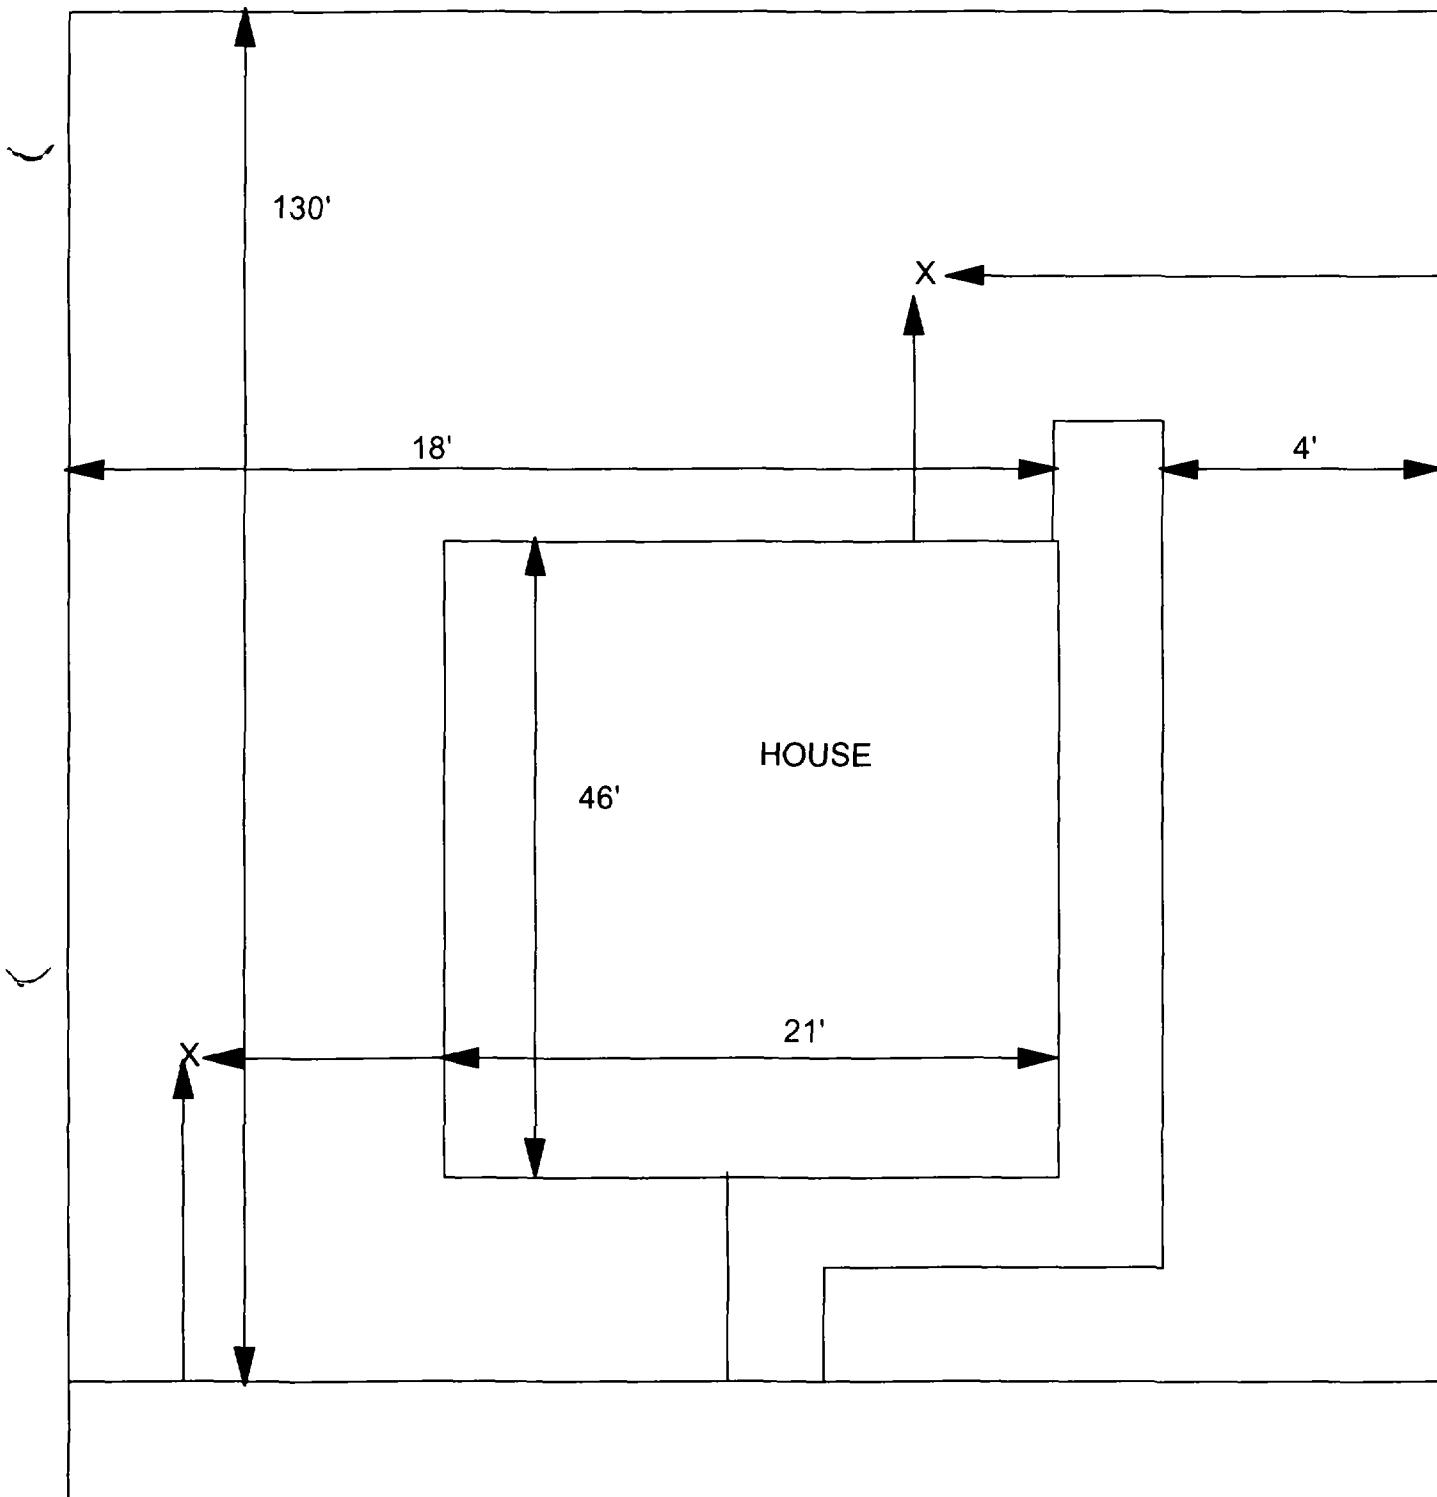

X = SAMPLE POINT

1032
GREENWOOD
28' X 130'

OHM
Corporation
Findlay, Ohio

Drawn By: EDJ	Checked By:
Date: 7/29/98	Approved By:
Scale: NTS	Drawing No:

1

2

3

1100 Greenwood

Action Date: 5/4/98

Loadout: 5/6/98

Restoration Begins: 5/11/98

Restoration Completed: 5/14/98

*Stack emission sites were not sampled for verification due to the fact that a pre-determined depth for excavation was given to OHM by USACE.

*An excavation depth of 12 inches was established by USACE prior to work commencing.

*The excavation of special waste yielded a total of 163.04 cubic yards, which was shipped to WMI-Milam for disposal.

*Equipment utilized during excavation:

*TL-26

*TCM

*X331

*17-KW

*Subcontractors:

*WMI-landfill

*B. Garcia-trucking

*Grantham-trucking

*Schneider Turf Farm

OHM CORPORATION
PROJECT 19531
GRANITE CITY, IL

QUANTITY SUMMARY FOR 1100 Greenwood

SPECIAL WASTE (TONS)	BACKFILL (LOADS)	TOPSOIL (TONS)	CA-6 (TONS)	CA-7 (TONS)	SAND (TONS)	SOD CU.YDS.	CONCRETE	OTHER
211.96	13			29.1		315		

**Sampling Analysis
Project #19531**


0 - 3" Front and Back				
Street/Number Address	A	A	A	A
	PPM	PPM	PPM	PPM
	No.	No.	No.	No.

3 - 6" Front and Back				
Street/Number Address	B	B	B	B
	PPM	PPM	PPM	PPM
	No.	No.	No.	No.

6 - 12" Front and Back				
Street/Number Address	C	C	C	C
	PPM	PPM	PPM	PPM
	No.	No.	No.	No.

Depth Excav. (inch)

1100 Greenwood 1088 1068 1030 993 12

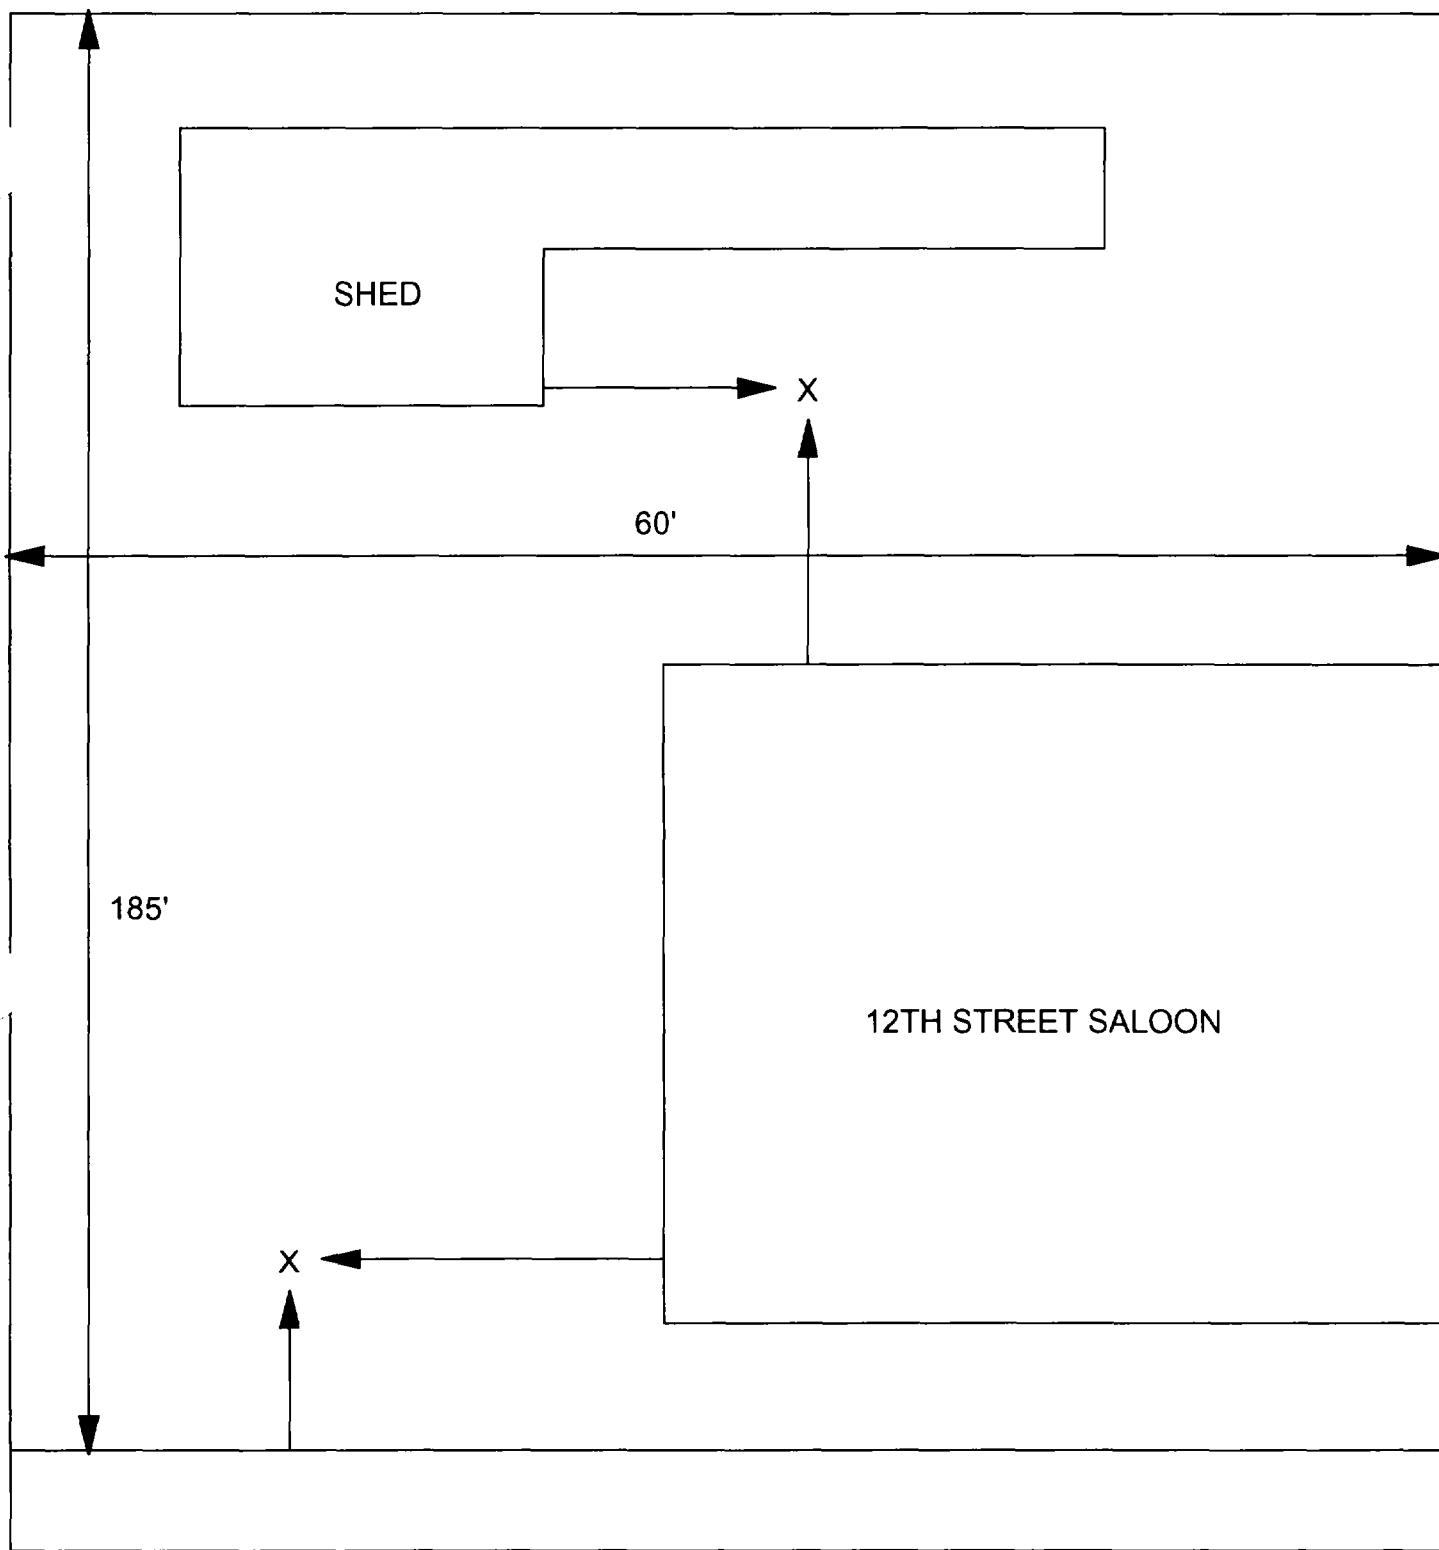

X = SAMPLE POINT

1100 GREENWOOD
60' X 185'

OHM 
Corporation
Findlay, Ohio

Drawn By: **EDJ** Checked By:

Date: **7/29/98** Approved By:

Scale: **NTS** Drawing No:

1

2

3

1102/04 Greenwood

Action Date: 7/11/97

Loadout: 7/14/97

Restoration Begins: 7/17/97

Restoration Completed: 8/1/97

*Stack emission sites were not sampled for verification due to the fact that a pre-determined depth for excavation was given to OHM by USACE.

*An excavation depth of 6 inches was established by USACE prior to work commencing.

*The excavation of special waste yielded a total of 102.63 cubic yards, which was shipped to WMI-Milam for disposal.

*Equipment utilized during excavation:

*TL-26

*TCM

*X331

*17-KW

*Subcontractors:

*WMI-landfill

*B. Garcia-trucking

*Grantham-trucking

*Emerald-turf farm

**OHM CORPORATION
PROJECT 19531
GRANITE CITY, IL**

QUANTITY SUMMARY FOR

1102/04 Greenwood

SPECIAL WASTE (TONS)	BACKFILL (LOADS)	TOPSOIL (TONS)	CA-6 (TONS)	CA-7 (TONS)	SAND (TONS)	SOD CU.YDS.	CONCRETE	OTHER
133.42	6	28.99	29.05	14.35		420		

**Sampling Analysis
Project #19531**

0 - 3" Front and Back

	A		A	
Street/Number	PPM	No.	PPM	No.
Address	No.	No.	No.	No.

1102 Greenwood **529** 279 **706** 305

3 - 6" Front and Back

B		B	
PPM	No.	PPM	No.
No.	No.	PPM	No.

565 210 **516** 230



6 - 12" Front and Back

C	C	C
PPM	PPM	PPM
No.	No.	No.

127 98
153 127

Depth
Excav.
(inch)

6

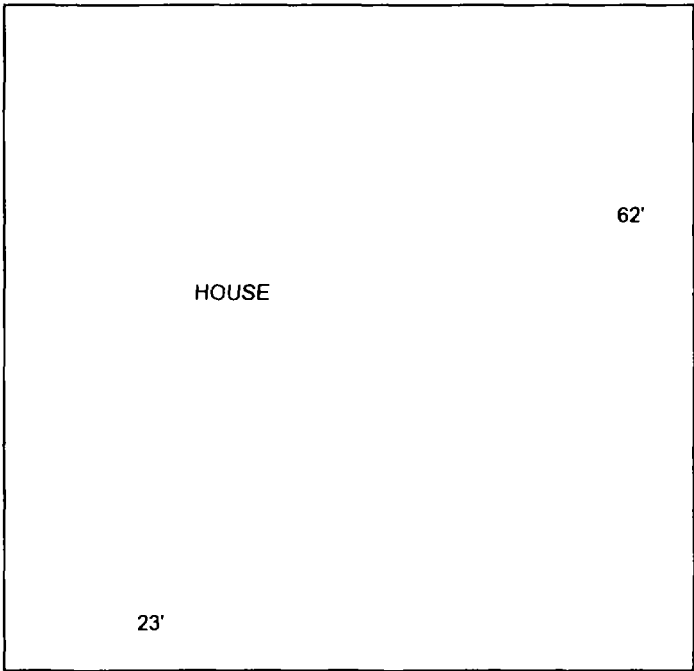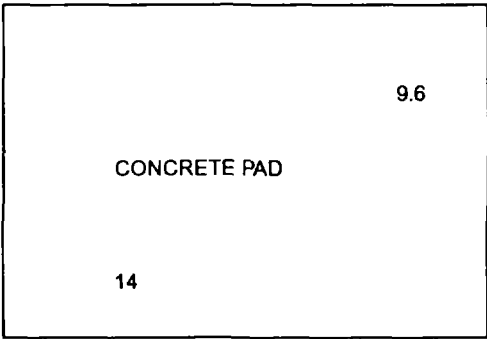

1102/04
GREENWOOD

TOTAL DIMENSIONS:
49 X 165

	OHM Corporation Findlay, Ohio	
	Drawn By: DDL	Checked By:
	Date: 8/12/96	Approved By:
	Scale: NTS	Drawing No:

1

2

3

1108 Greenwood

Action Date: 7/14/97

Loadout: 7/16/97

Restoration Begins: 7/16/97

Restoration Completed: 8/1/97

*Stack emission sites were not sampled for verification due to the fact that a pre-determined depth for excavation was given to OHM by USACE.

*An excavation depth of 6 inches was established by USACE prior to work commencing.

*The excavation of special waste yielded a total of 97.19 cubic yards, which was shipped to WMI-Milam for disposal.

*Equipment utilized during excavation:

*TL-26

*TCM

*X331

*17-KW

*Subcontractors:

*WMI-landfill

*B. Garcia-trucking

*Grantham-trucking

*Emerald-turf farm

**OHM CORPORATION
PROJECT 19531
GRANITE CITY, IL**

QUANTITY SUMMARY FOR

1108 Greenwood

SPECIAL WASTE (TONS)	BACKFILL (LOADS)	TOPSOIL (TONS)	CA-6 (TONS)	CA-7 (TONS)	SAND (TONS)	SOD CU.YDS.	CONCRETE	OTHER
126.35	3	75.41	73.21			300		

**Sampling Analysis
Project #19531**

0 - 3" Front and Back

Street/Number Address	A		A	
	PPM	No.	PPM	No.
1108 Greenwood	596	849		

3 - 6" Front and Back

	B		B	
	PPM	No.	PPM	No.

417 749


6 - 12" Front and Back

	C		C	
	PPM	No.	PPM	No.

174 236

	Depth	
	Excav.	(inch)

6

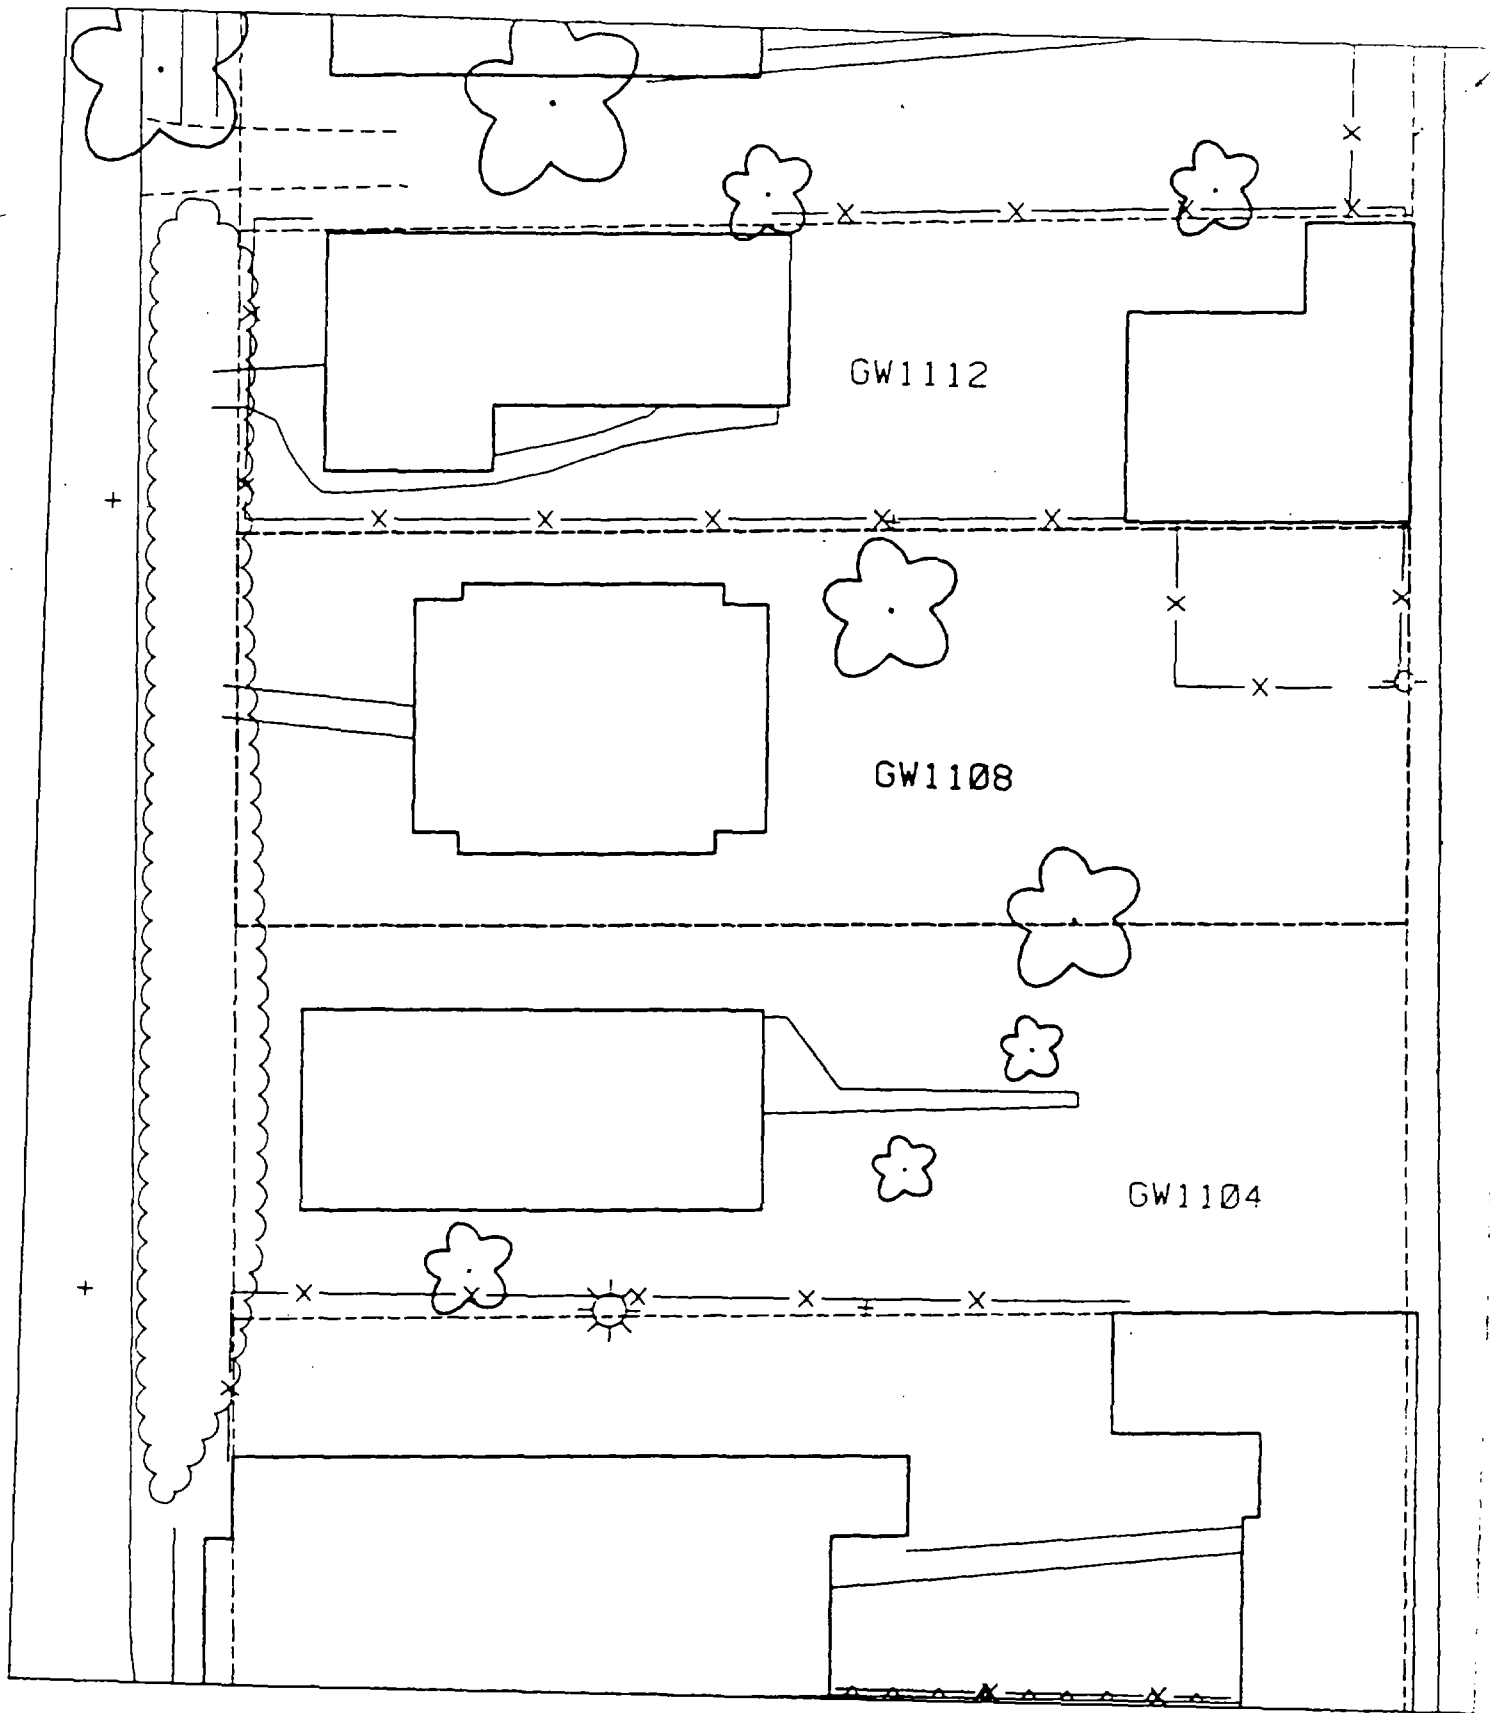

1

2

3

1112 Greenwood

Action Date: 11/22/97

Loadout: 11/25/97

Restoration Begins: 11/26/97

Restoration Completed: 12/3/97

*Stack emission sites were not sampled for verification due to the fact that a pre-determined depth for excavation was given to OHM by USACE.

*An excavation depth of 3 inches was established by USACE prior to work commencing.

*The excavation of special waste yielded a total of 43.34 cubic yards, which was shipped to WMI-Milam for disposal.

*Equipment utilized during excavation:

*TL-26

*TCM

*X331

*17-KW

*Subcontractors:

*WMI-landfill

*B. Garcia-trucking

*Grantham-trucking

*Emerald-turf farm

OHM CORPORATION
 PROJECT 1953I
 GRANITE CITY, IL

QUANTITY SUMMARY FOR

1112 Greenwood

SPECIAL WASTE (TONS)	BACKFILL (LOADS)	TOPSOIL (TONS)	CA-6 (TONS)	CA-7 (TONS)	SAND (TONS)	SOD CU.YDS.	CONCRETE	OTHER
56.35	2	31.86				420		

**Sampling Analysis
Project #19531**

0 - 3" Front and Back

Street/Number Address	A		A	
	PPM	No.	PPM	No.
1112 Greenwood	220	854		
	131	213		
	380	540		

3 - 6" Front and Back

	B		B	
	PPM	No.	PPM	No.
		57		445

6 - 12" Front and Back

	C		C	
	PPM	No.	PPM	No.
		86		174

	Depth	
	Excav.	(inch)
		3

1

2

3

4

1120 Greenwood

Action Date: 7/22/97

Loadout: 1/19/98

Restoration Begins: 1/27/98

Restoration Completed: 1/13/98

*Stack emission sites were not sampled for verification due to the fact that a pre-determined depth for excavation was given to OHM by USACE.

*An excavation depth of 3 inches was established by USACE prior to work commencing.

*The excavation of special waste yielded a total of 161.66 cubic yards, which was shipped to WMI-Milam for disposal.

*Equipment utilized during excavation:

*TL-26

*TCM

*X331

*17-KW

*Subcontractors:

*WMI-landfill

*B. Garcia-trucking

*Granthum-trucking

*Emerald Turf Farm

OHM CORPORATION
PROJECT 19531
GRANITE CITY, IL

QUANTITY SUMMARY FOR

1120 Greenwood

HAZARDOUS WASTE (TONS)	BACKFILL (LOADS)	TOPSOIL (TONS)	CA-6 (TONS)	CA-7 (TONS)	SAND (TONS)	SOD CU.YDS.	CONCRETE	OTHER
210.17	10	13.3	117.03	31.4		360		

**Sampling Analysis
Project #19531**

0 - 3" Front and Back

Street/Number Address	A		A	
	PPM	No.	PPM	No.
1120 Greenwood	202	1152		
	148	495		

3 - 6" Front and Back


B		B	
PPM	No.	PPM	No.

6 - 12" Front and Back

C		C	
PPM	No.	PPM	No.

Depth Excav. (inch)

3

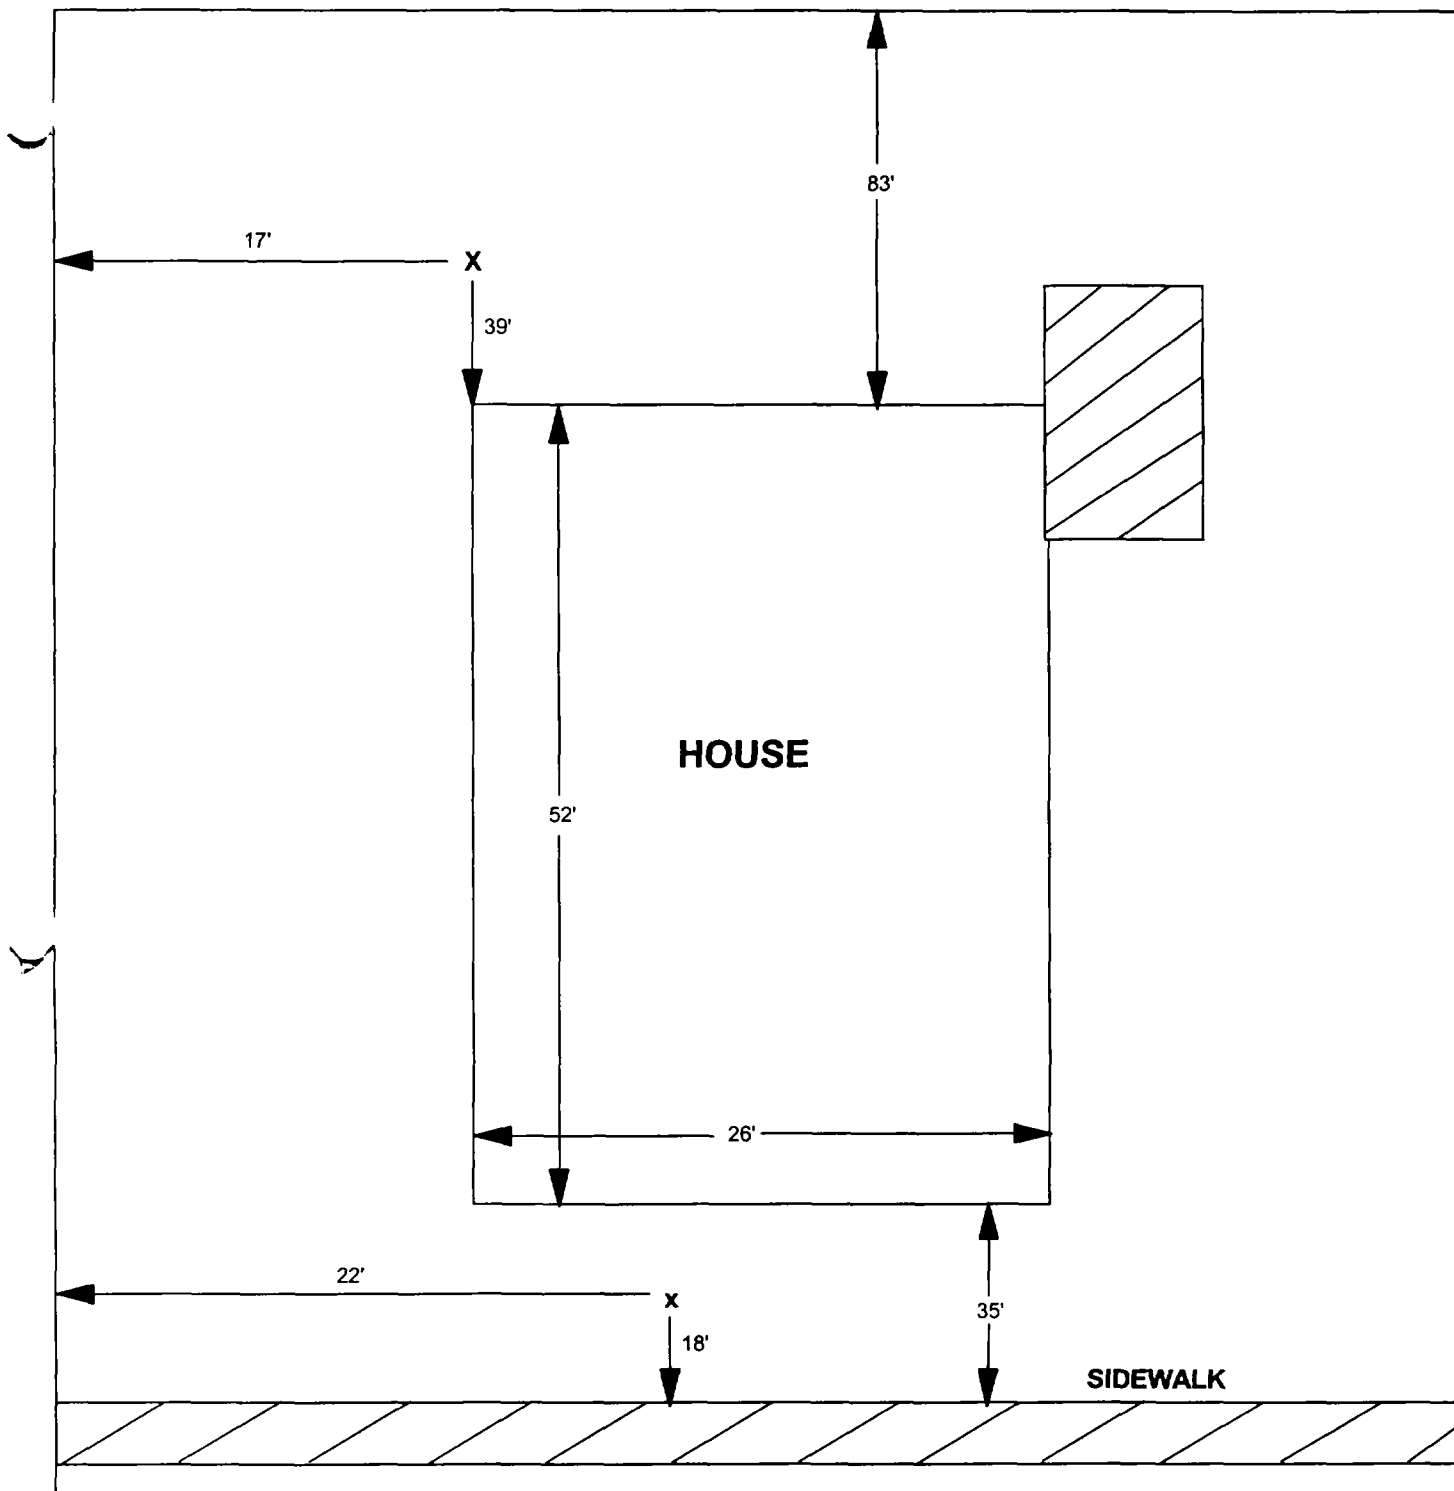

X = SAMPLE POINT

1120 GREENWOOD

**TOTAL
DIMENSIONS
170'X49'**

OHM 
Corporation
Findlay, Ohio

Drawn By: **JG** Checked By:

Date: 8/21/98 Approved By:

Scale: **NTS** Drawing No:

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1133 Greenwood

Action Date: 10/14/97

Loadout: 10/16/97

Restoration Begins: 10/17/97

Restoration Completed: 10/31/97

*Stack emission sites were not sampled for verification due to the fact that a pre-determined depth for excavation was given to OHM by USACE.

*An excavation depth of 6 inches was established by USACE prior to work commencing.

*The excavation of special waste yielded a total of 156.80 cubic yards, which was shipped to WMI-Milam for disposal.

*Equipment utilized during excavation:

*TL-26

*TCM

*X331

*17-KW

*Subcontractors:

*WMI-landfill

*B. Garcia-trucking

*Grantham-trucking

*Emerald-turf farm

OHM CORPORATION
PROJECT 19531
GRANITE CITY, IL

QUANTITY SUMMARY FOR

1133 Greenwood

SPECIAL WASTE (TONS)	BACKFILL (LOADS)	TOPSOIL (TONS)	CA-6 (TONS)	CA-7 (TONS)	SAND (TONS)	SOD CU.YDS.	CONCRETE	OTHER
203.84	14	71.58		15.2		900		

**Sampling Analysis
Project #19531**

0 - 3" Front and Back

	A		A	
Street/Number	PPM	No.	PPM	No.
Address	No.	No.	No.	No.

1133 Greenwood 226 476

3 - 6" Front and Back

B		B	
PPM	No.	PPM	No.
No.	No.	PPM	No.

597 547


6 - 12" Front and Back

C		C	
PPM	No.	PPM	No.
No.	No.	PPM	No.

169 475

Depth
Excav.
(inch)

6

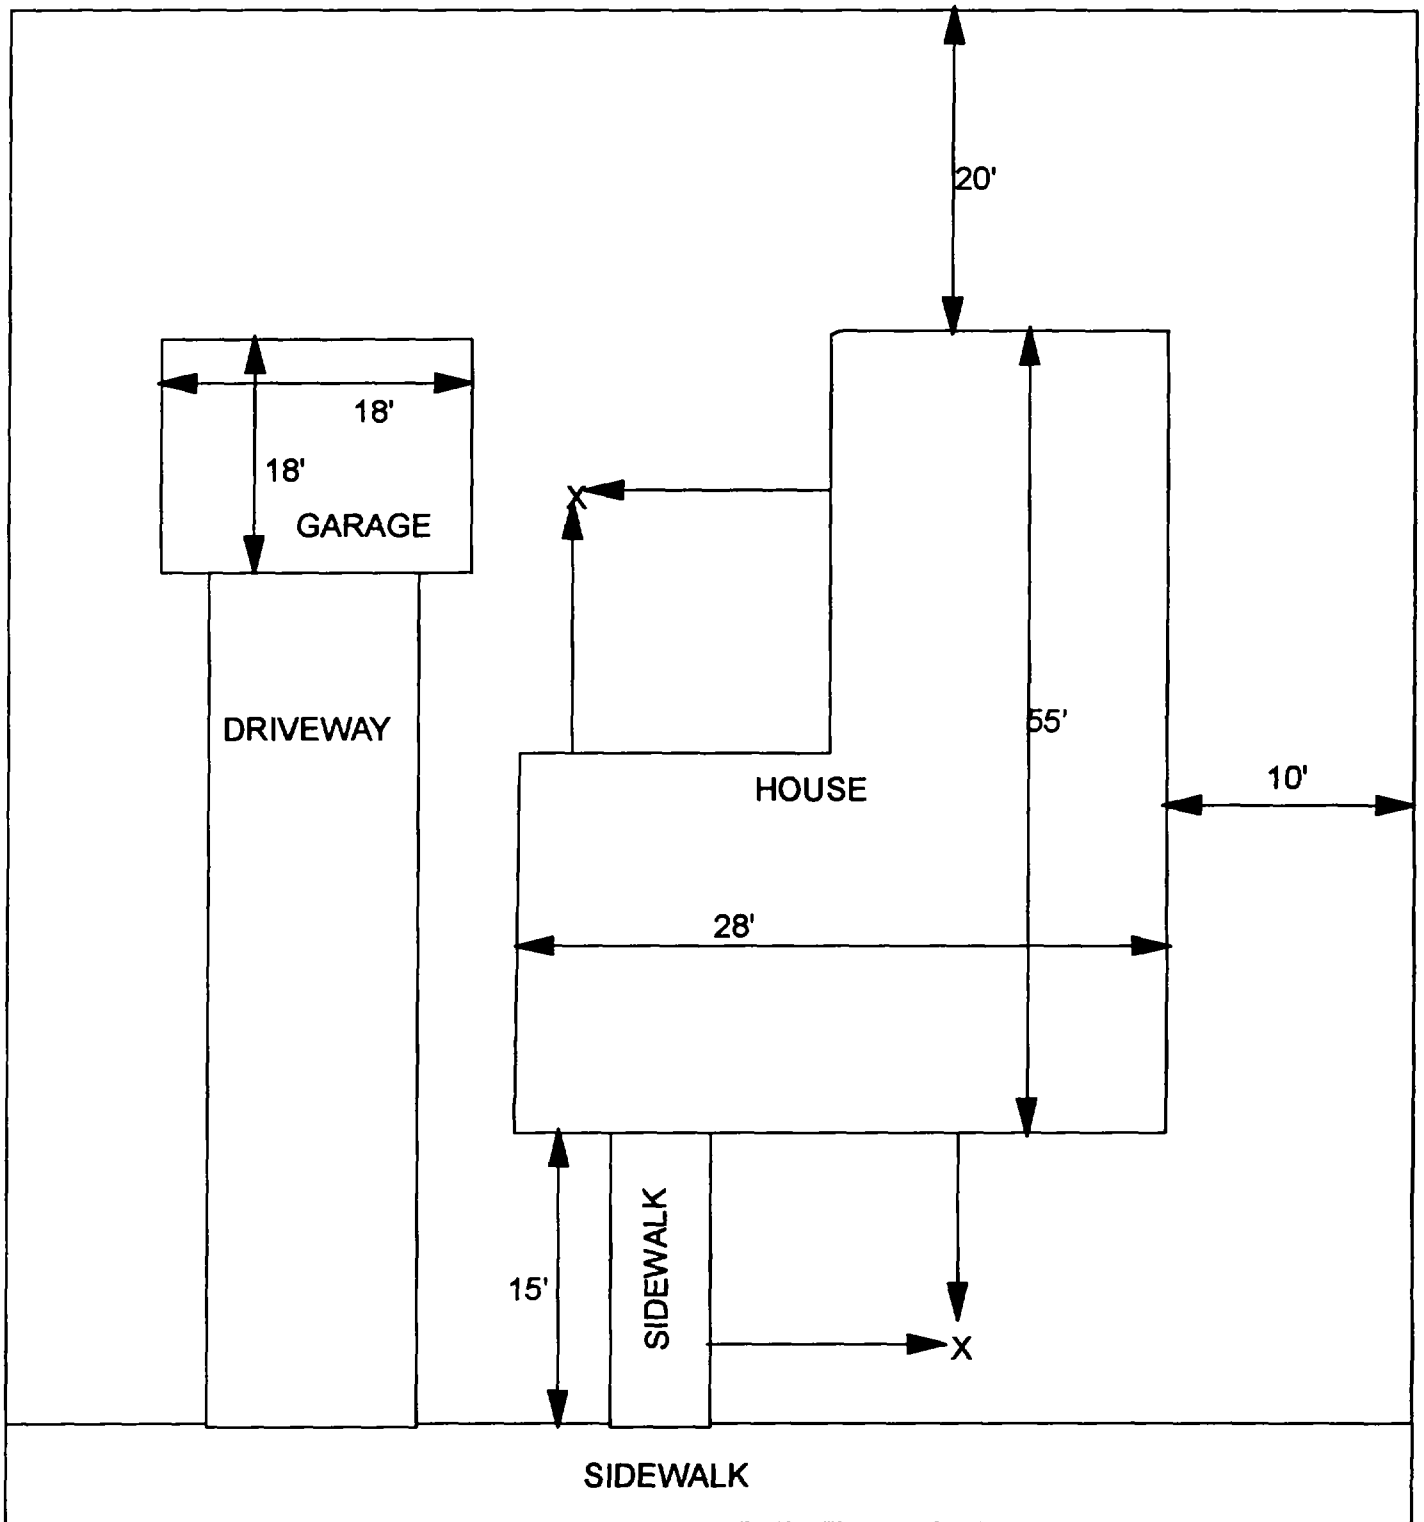

X - SAMPLE POINT

1133 GREENWOOD
56' X 90'

OHM 
Corporation
Findley, Ohio

Drawn By: EDJ	Checked By:
Date: 10/14/98	Approved By:
Scale: NTS	Drawing No:

1

2

3

Action Date: 2/6/98

Loadout: 2/9/98

Restoration Begins: 2/9/98

Restoration Completed: 3/5/98

*Stack emission sites were not sampled for verification due to the fact that a pre-determined depth for excavation was given to OHM by USACE.

*An excavation depth of 3 inches was established by USACE prior to work commencing.

*The excavation of special waste yielded a total of 42.13 cubic yards, which was shipped to WMI-Milam for disposal.

*Equipment utilized during excavation:

*TL-26

*TCM

*X331

*17KW

*Subcontractors:

*WMI-landfill

*B. Garcia-trucking

*Granthum-trucking

*Schneider Turf Farm

OHM CORPORATION
PROJECT 19531
GRANITE CITY, IL

QUANTITY SUMMARY FOR 817 Iowa

SPECIAL WASTE (TONS)	BACKFILL (LOADS)	TOPSOIL (TONS)	CA-6 (TONS)	CA-7 (TONS)	SAND (TONS)	SOD CU.YDS.	CONCRETE	OTHER
54.77	3		14.59	13.1		240		

**Sampling Analysis
Project #19531**

0 - 3" Front and Back

Street/Number Address	A		A	
	PPM	No.	PPM	No.

817 Iowa

613 433

3 - 6" Front and Back

B	B		B	
	PPM	No.	PPM	No.

353 184


6 - 12" Front and Back

C	C		C	
	PPM	No.	PPM	No.

238 352

Depth Excav. (inch)

3

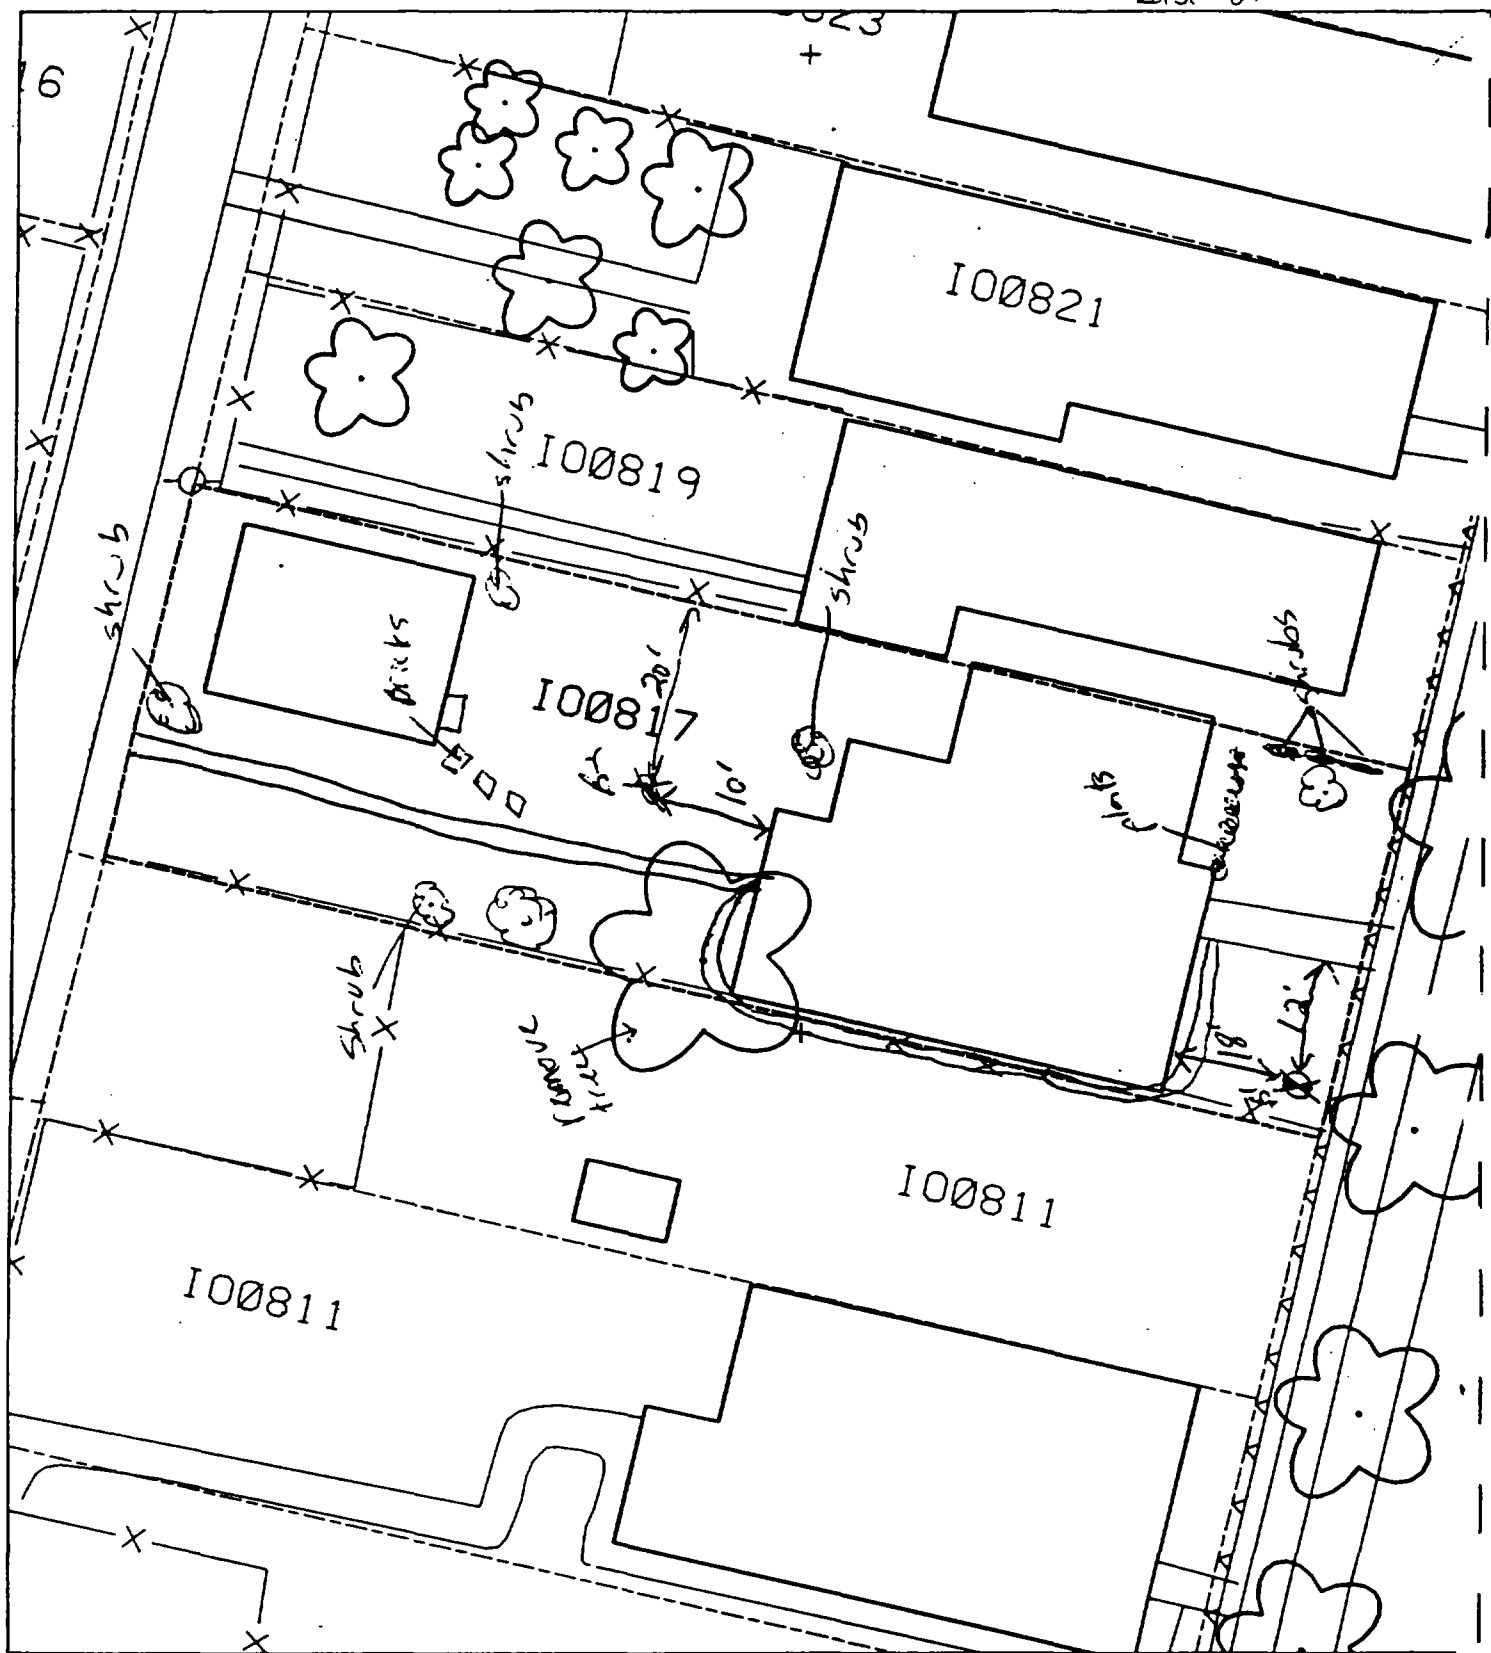

70' paved + house 45;

β^1 - 18' east of house & 12' south of sidewalk.

β^2 - 10' west of wooden deck & 20' south of fence.

—

—

—

Action Date: 2/6/98

Loadout: 2/9/98

Restoration Begins: 2/24/98

Restoration Completed: 3/5/98

*Stack emission sites were not sampled for verification due to the fact that a pre-determined depth for excavation was given to OHM by USACE.

*An excavation depth of 3 inches was established by USACE prior to work commencing.

*The excavation of special waste yielded a total of 19.46 cubic yards, which was shipped to WMI-Milam for disposal.

*Equipment utilized during excavation:

*TL-26

*TCM

*X331

*17-KW

*Subcontractors:

*WMI-landfill

*B. Garcia-trucking

*Grantham-trucking

*Emerald Turf Farm

OHM CORPORATION
PROJECT 19531
GRANITE CITY, IL

QUANTITY SUMMARY FOR 819 Iowa

SPECIAL WASTE (TONS)	BACKFILL (LOADS)	TOPSOIL (TONS)	CA-6 (TONS)	CA-7 (TONS)	SAND (TONS)	SOD CU.YDS.	CONCRETE	OTHER
25.29	2					120		

**Sampling Analysis
Project #19531**

0 - 3" Front and Back

Street/Number	A		A	
	PPM	No.	PPM	No.
Address	No.	No.	No.	No.

819 Iowa 471 190
578 353

3 - 6" Front and Back

B	B		B	
	PPM	No.	PPM	No.
PPM	PPM	No.	PPM	No.

338 250
344 300


6 - 12" Front and Back

C	C	C
PPM	PPM	PPM
No.	No.	No.

305 216
186 364

Depth	Depth	
	Excav.	(inch)
Excav.	Excav.	(inch)

3

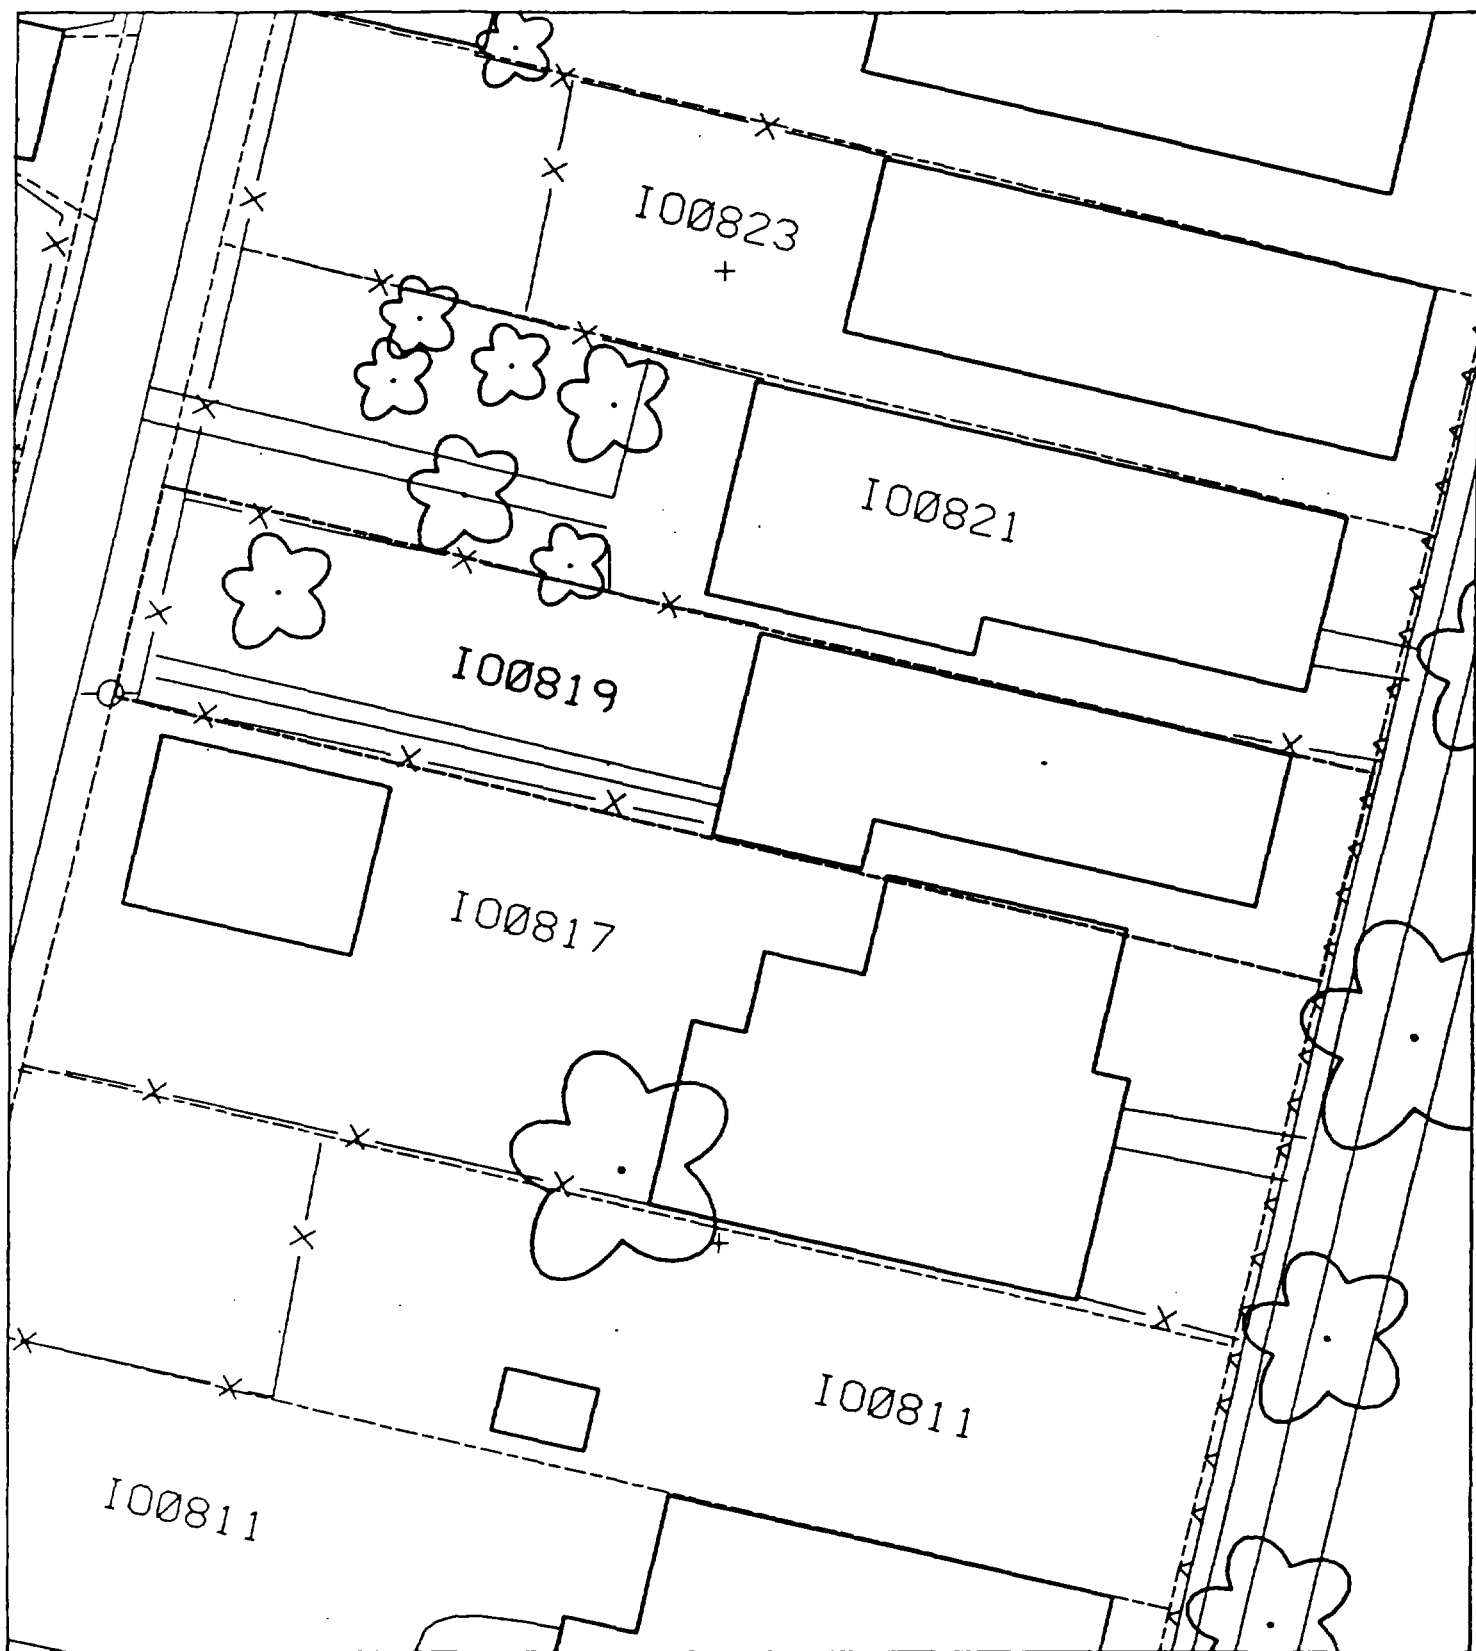

1

2

3

Action Date: 10/14/97

Loadout: 10/16/97

Restoration Begins: 10/17/97

Restoration Completed: 10/31/97

*Stack emission sites were not sampled for verification due to the fact that a pre-determined depth for excavation was given to OHM by USACE.

*An excavation depth of 6 inches was established by USACE prior to work commencing.

*The excavation of special waste yielded a total of 86.93 cubic yards, which was shipped to WMI-Milam for disposal.

*Equipment utilized during excavation:

*TL-26

*TCM

*X331

*17-KW

*Subcontractors:

*WMI-landfill

*B. Garcia-trucking

*Granthum-trucking

*Emerald Turf Farm

OHM CORPORATION
PROJECT 19531
GRANITE CITY, IL

QUANTITY SUMMARY FOR 820 Iowa

SPECIAL WASTE (TONS)	BACKFILL (LOADS)	TOPSOIL (TONS)	CA-6 (TONS)	CA-7 (TONS)	SAND (TONS)	SOD CU.YDS.	CONCRETE	OTHER
113.01	1	21.83	82.9	13.35		240		

**Sampling Analysis
Project #19531**

0 - 3" Front and Back

Street/Number Address	A		A	
	PPM	No.	PPM	No.
820 Iowa	258	292		
	348	416		

3 - 6" Front and Back


	B		B	
	PPM	No.	PPM	No.
	268	256		
	283	1345		
	202	451		

6 - 12" Front and Back

	C		C	
	PPM	No.	PPM	No.
	135	97		
	161	309		

Depth	
Excav.	(inch)

6

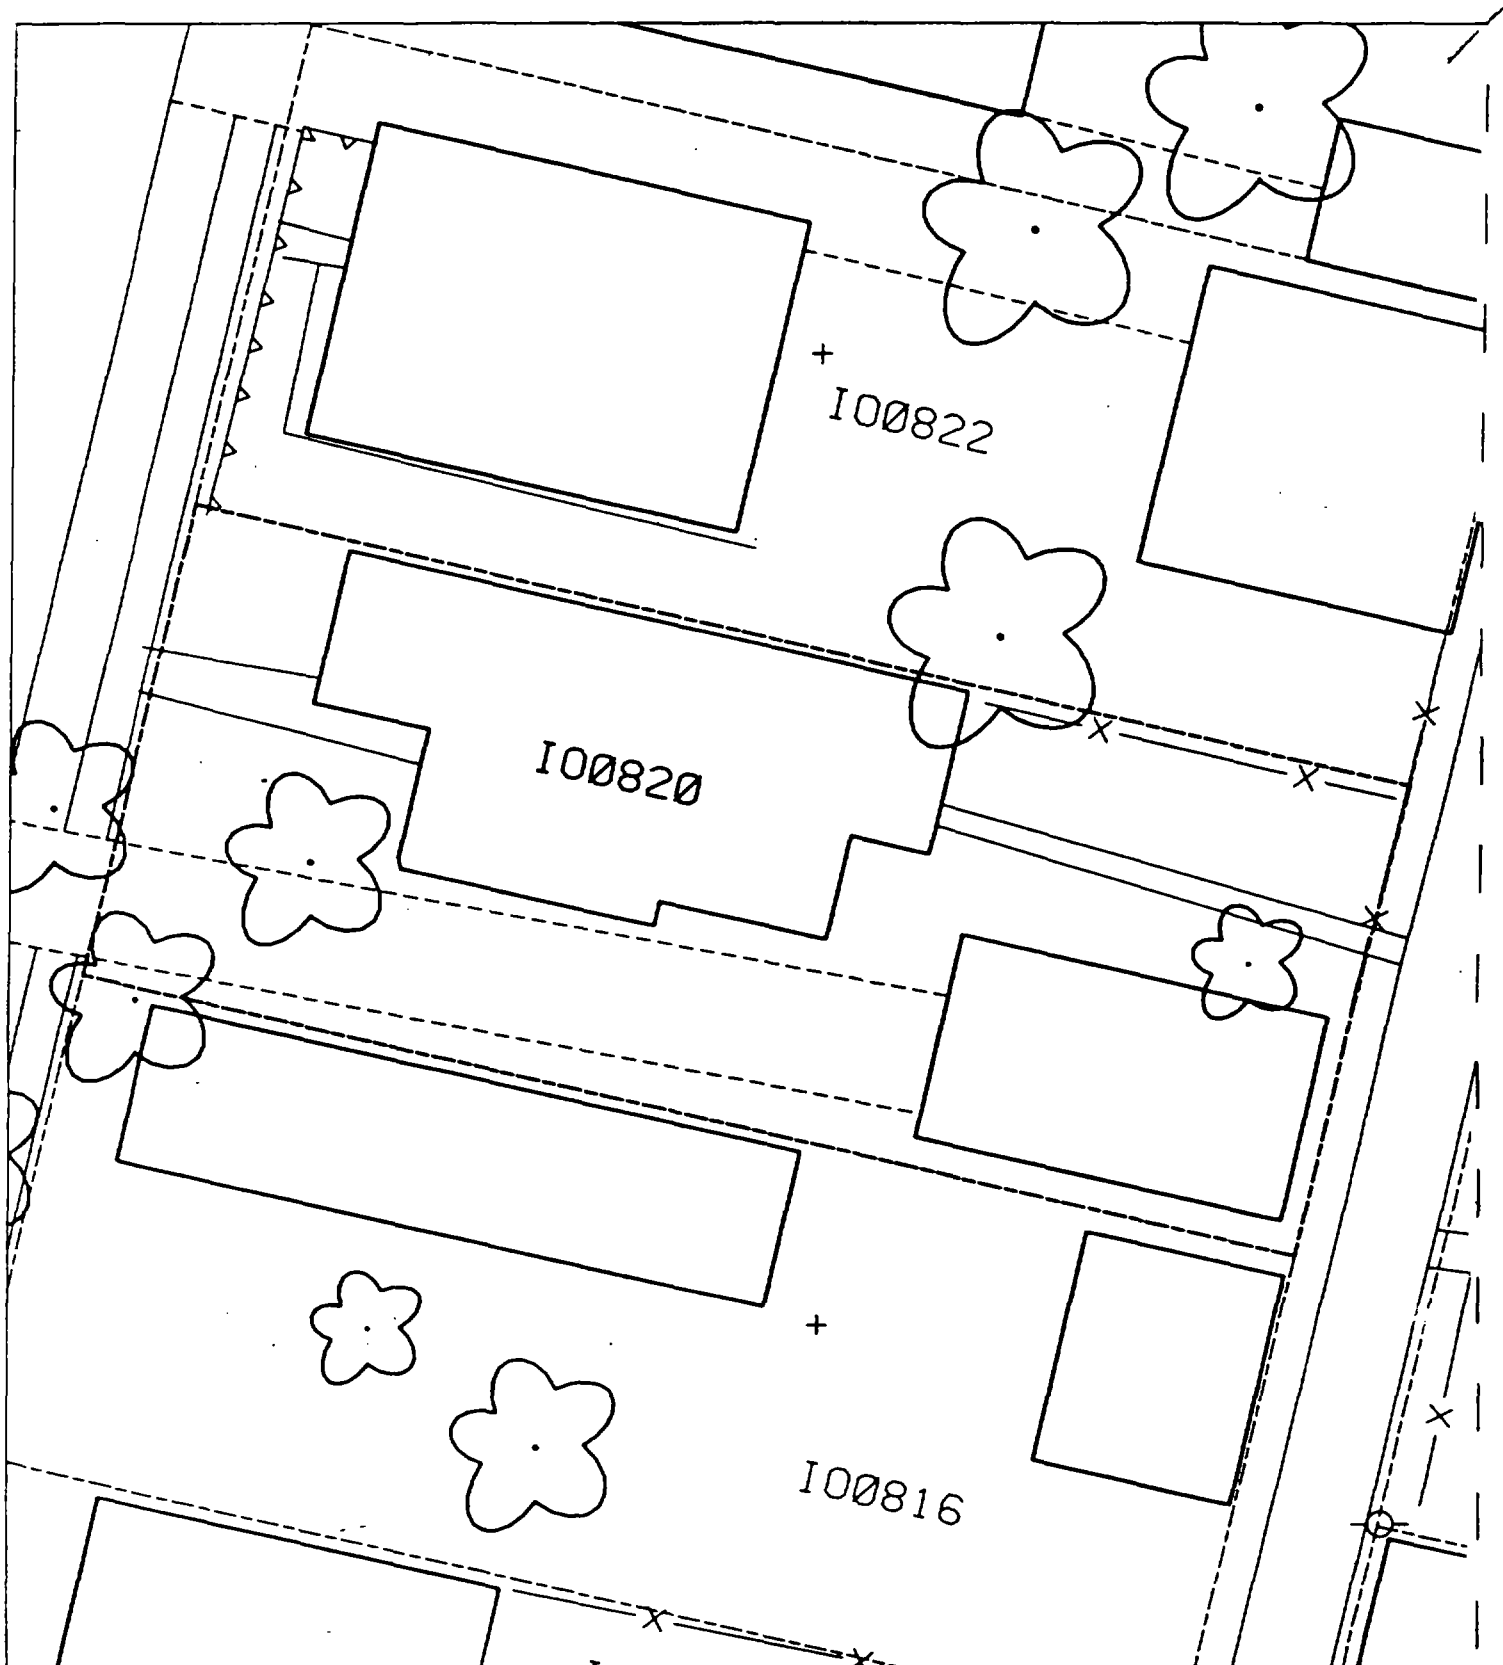

1

2

3

Action Date: 10/14/97

Loadout: 10/17/97

Restoration Begins: 10/18/97

Restoration Completed: 10/31/97

*Stack emission sites were not sampled for verification due to the fact that a pre-determined depth for excavation was given to OHM by USACE.

*An excavation depth of 3 inches was established by USACE prior to work commencing.

*The excavation of special waste yielded a total of 52.70 cubic yards, which was shipped to WMI-Milam for disposal.

*Equipment utilized during excavation:

*TL-26

*TCM

*X331

*17-KW

*Subcontractors:

*WMI-landfill

*B. Garcia-trucking

*Granthum-trucking

*Emerald Turf Farm

OHM CORPORATION
PROJECT 19531
GRANITE CITY, IL

QUANTITY SUMMARY FOR 822 Iowa

SPECIAL WASTE (TONS)	BACKFILL (LOADS)	TOPSOIL (TONS)	CA-6 (TONS)	CA-7 (TONS)	SAND (TONS)	SOD CU.YDS.	CONCRETE	OTHER
68.52	1	30.66		31.7		240		

**Sampling Analysis
Project #19531**

0 - 3" Front and Back

Street/Number Address	A		A	
	PPM	No.	PPM	No.
822 Iowa	471	451		
	469	107		
	452	526		


3 - 6" Front and Back

B	B		B	
	PPM	No.	PPM	No.
348	449			
349	127			
165	266			

6 - 12" Front and Back

C	C		C	
	PPM	No.	PPM	No.
226	294			
94	24			
18	130			

Depth Excav. (inch)
3

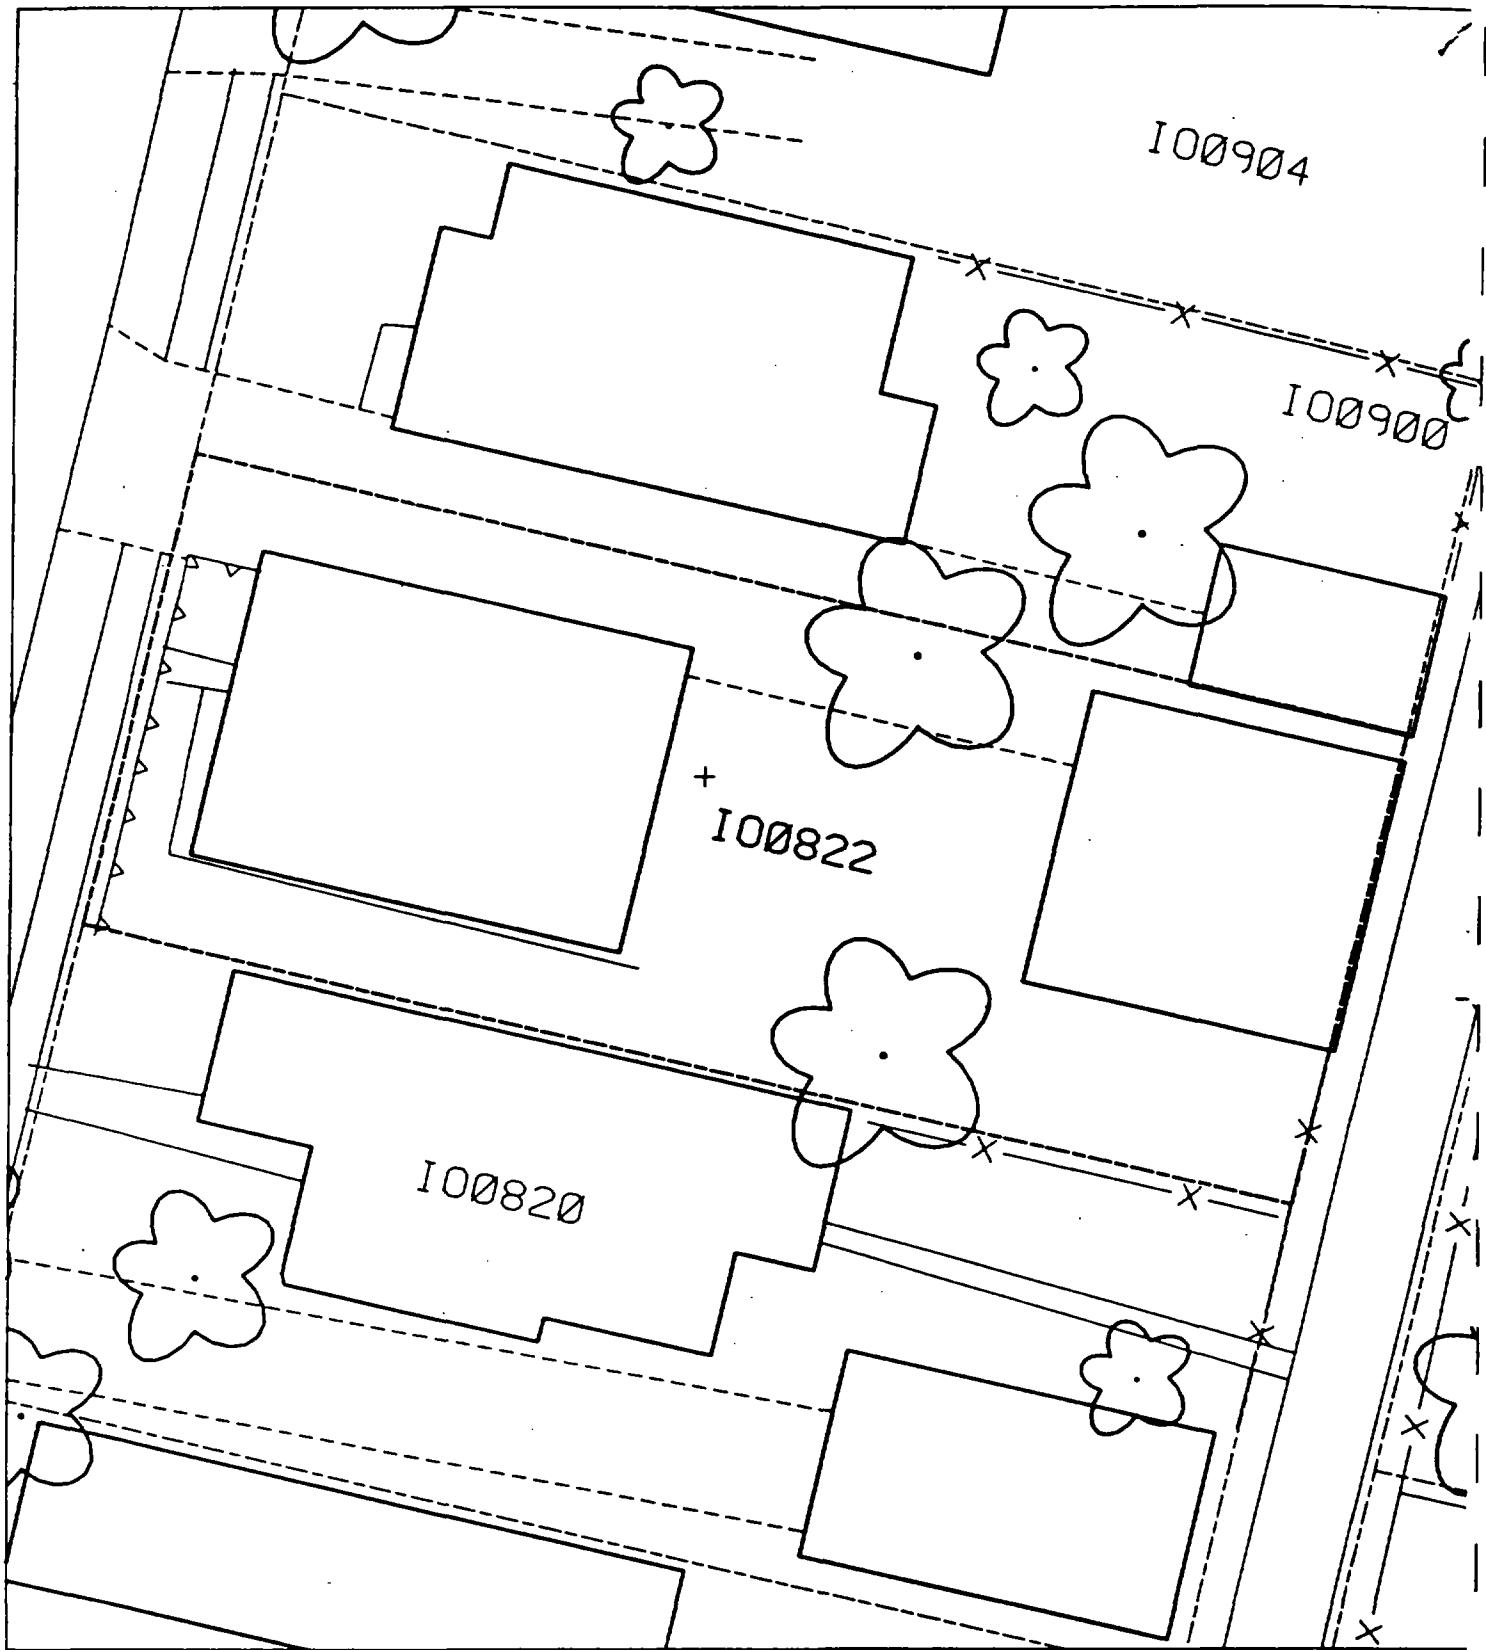

2

3

4

Action Date: 1/31/98

Loadout: 2/2/98

Restoration Begins: 2/3/98

Restoration Completed: 2/12/98

*Stack emission sites were not sampled for verification due to the fact that a pre-determined depth for excavation was given to OHM by USACE.

*An excavation depth of 6 inches was established by USACE prior to work commencing.

*The excavation of special waste yielded a total of 51.62 cubic yards, which was shipped to WMI-Milam for disposal.

*Equipment utilized during excavation:

*TL-26

*TCM

*X331

*17-KW

*Subcontractors:

*WMI-landfill

*B. Garcia-trucking

*Grantham-trucking

*Emerald Turf Farm

OHM CORPORATION
PROJECT 19531
GRANITE CITY, IL

QUANTITY SUMMARY FOR 825 Iowa

SPECIAL WASTE (TONS)	BACKFILL (LOADS)	TOPSOIL (TONS)	CA-6 (TONS)	CA-7 (TONS)	SAND (TONS)	SOD CU.YDS.	CONCRETE	OTHER
67.11	5		29.41			360		

**Sampling Analysis
Project #19531**

0 - 3" Front and Back

Street/Number Address	A		A	
	PPM	No.	PPM	No.

825 Iowa

833 518

3 - 6" Front and Back

B	B		B	
	PPM	No.	PPM	No.

613 438


6 - 12" Front and Back

C	C		C	
	PPM	No.	PPM	No.

269 400

Depth	Depth	
	Excav.	(inch)

6

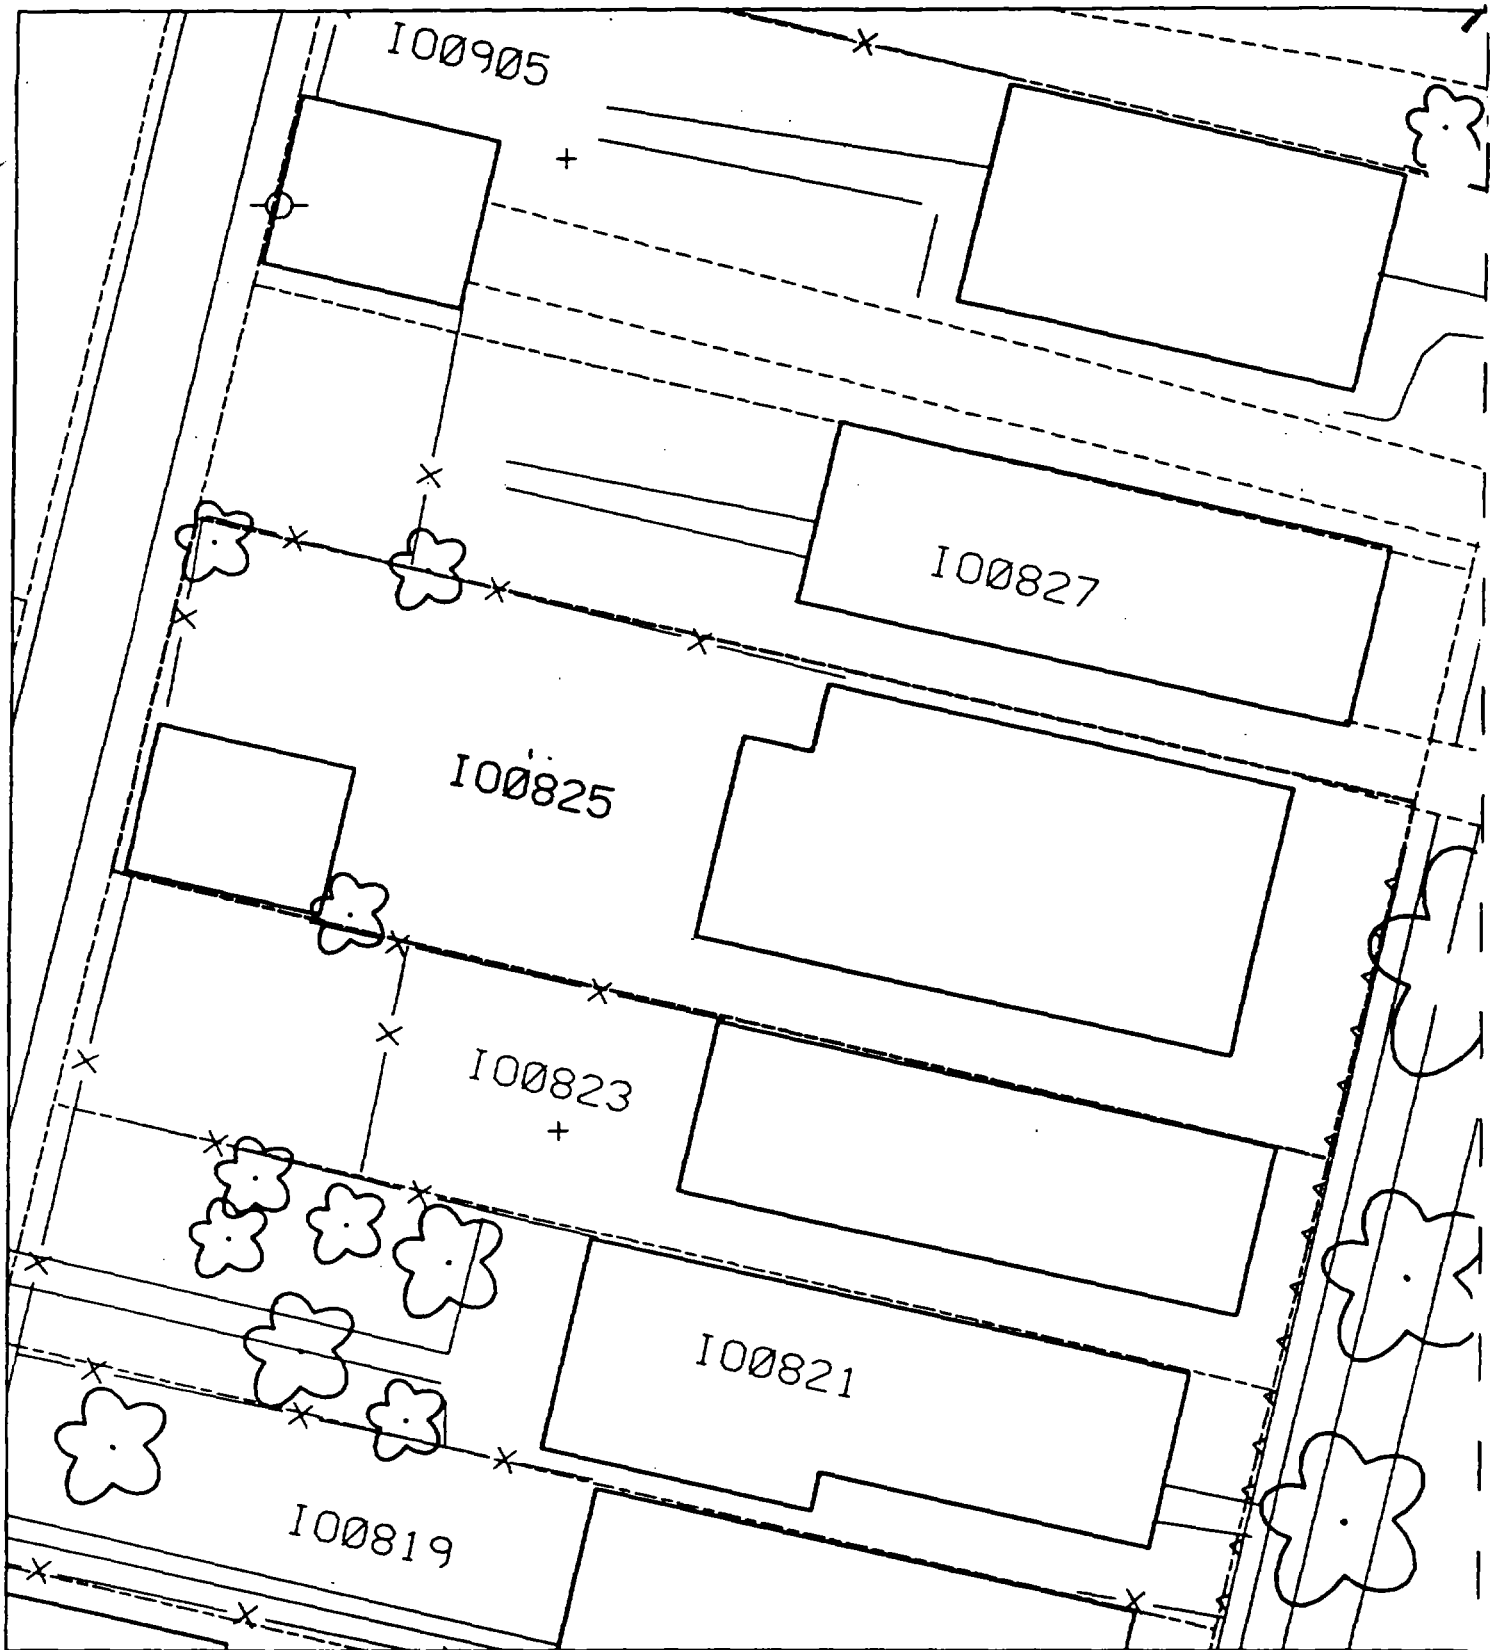

Action Date: 1/28/98

Loadout: 1/29/98

Restoration Begins: 1/29/98

Restoration Completed: 2/12/98

*Stack emission sites were not sampled for verification due to the fact that a pre-determined depth for excavation was given to OHM by USACE.

*An excavation depth of 3 inches was established by USACE prior to work commencing.

*The excavation of special waste yielded a total of 25.63 cubic yards, which was shipped to WMI-Milam for disposal.

*Equipment utilized during excavation:

*TL-26

*TCM

*X331

*17KW

*Subcontractors:

*WMI-landfill

*B. Garcia-trucking

*Granthum-trucking

*Emerald Turf Farm

OHM CORPORATION
 PROJECT 19531
 GRANITE CITY, IL

QUANTITY SUMMARY FOR 911 Iowa

SPECIAL WASTE (TONS)	BACKFILL (LOADS)	TOPSOIL (TONS)	CA-6 (TONS)	CA-7 (TONS)	SAND (TONS)	SOD CU.YDS.	CONCRETE	OTHER
33.32	3					180		

**Sampling Analysis
Project #19531**

0 - 3" Front and Back

Street/Number Address	A		A	
	PPM	No.	PPM	No.
911 Iowa	518	257		
	374	256		
	282	2515		


3 - 6" Front and Back

B		B	
PPM	No.	PPM	No.
387		196	

6 - 12" Front and Back

C		C	
PPM	No.	PPM	No.
124		217	

Depth Excav. (inch)
3

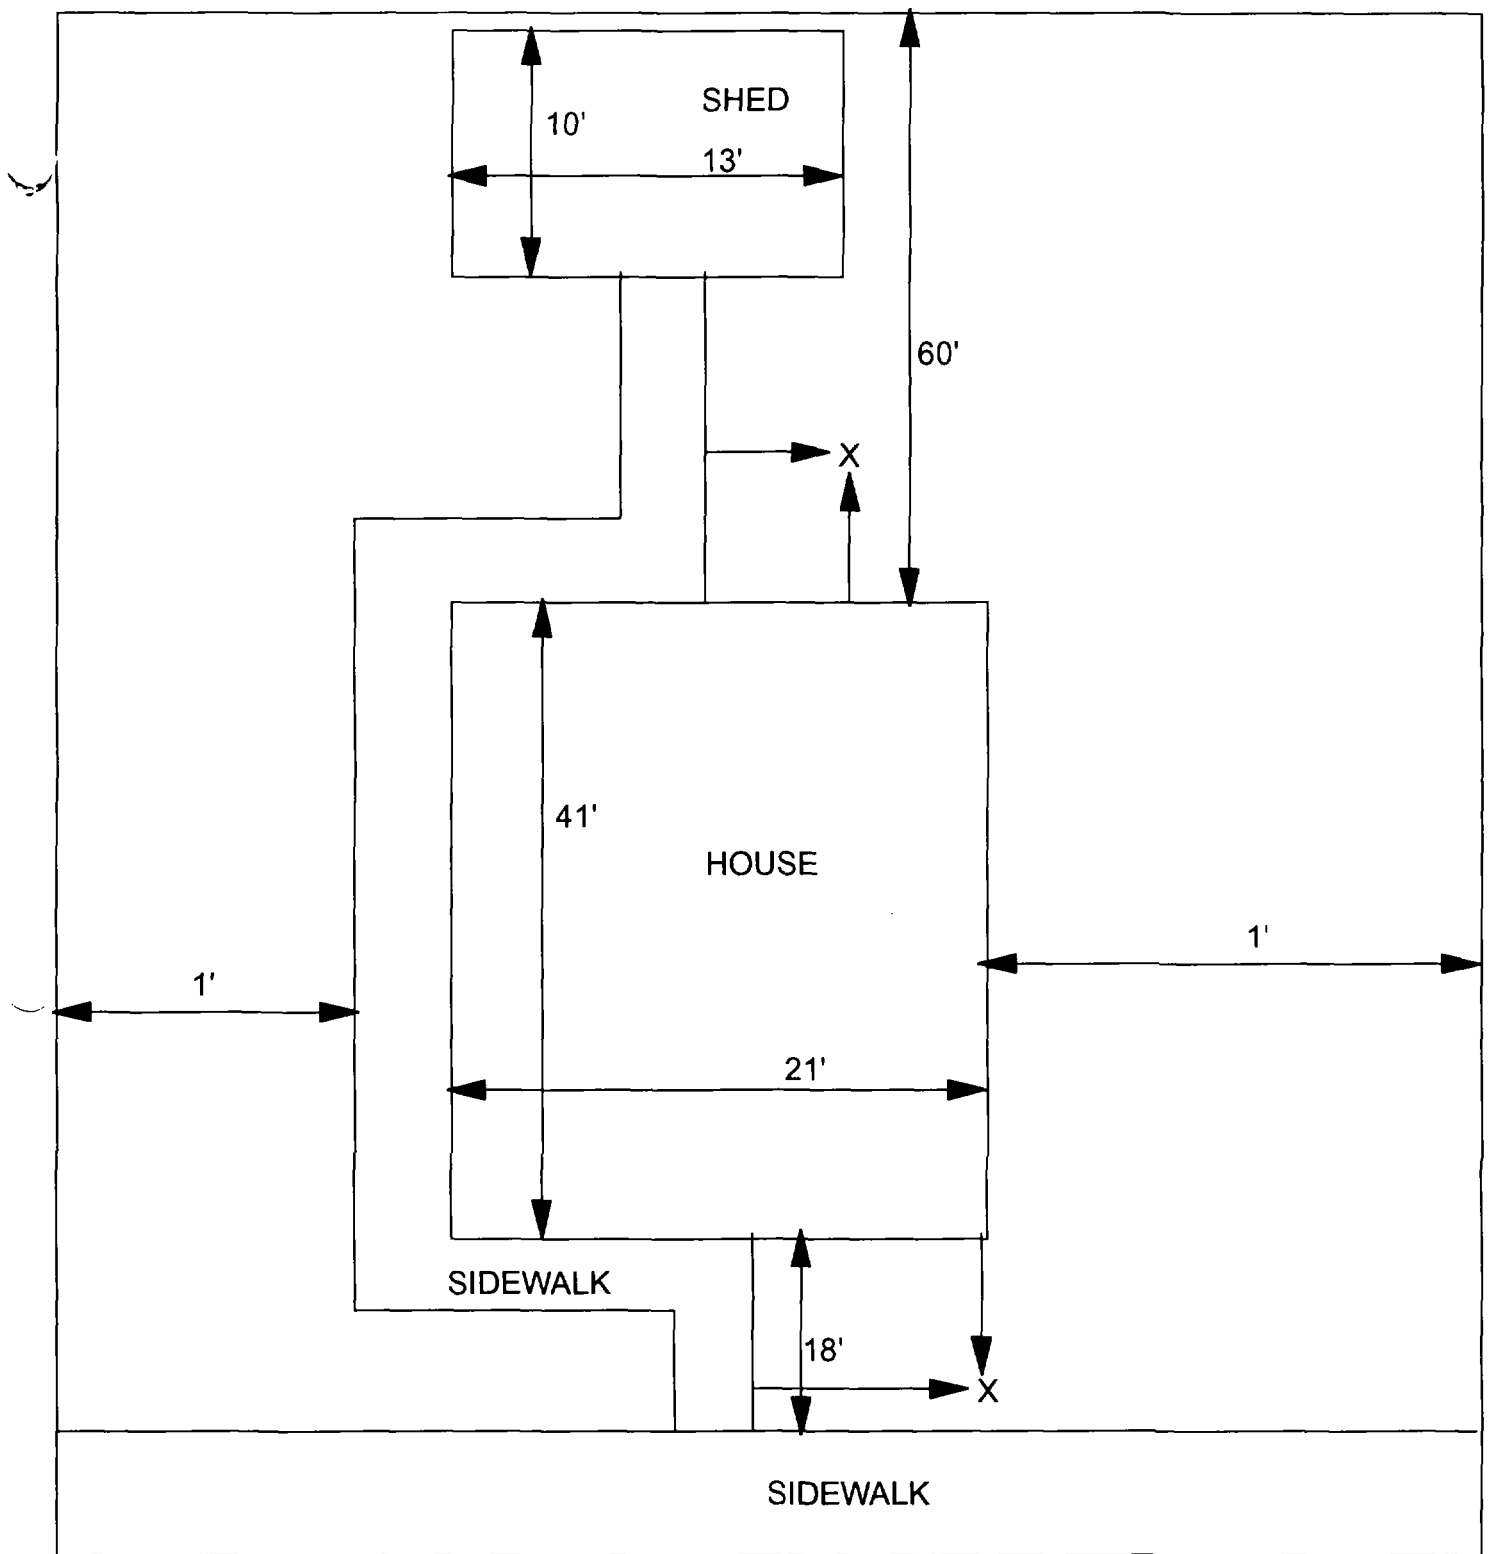

X = SAMPLE POINT

911 IOWA
23' X 119'

OHM Corporation
Findlay, Ohio

Drawn By: EDJ	Checked By:
Date: 7/29/98	Approved By:
Scale: NTS	Drawing No:

Action Date: 1/24/98

Loadout: 1/27/98

Restoration Begins: 1/27/98

Restoration Completed: 2/12/98

*Stack emission sites were not sampled for verification due to the fact that a pre-determined depth for excavation was given to OHM by USACE.

*An excavation depth of 6 inches was established by USACE prior to work commencing.

*The excavation of special waste yielded a total of 92.31 cubic yards, which was shipped to WMI-Milam for disposal.

*Equipment utilized during excavation:

*TL-26

*TCM

*X331

*17-KW

*Subcontractors:

*WMI-landfill

*B. Garcia-trucking

*Grantham-trucking

*Emerald Turf Farm

OHM CORPORATION
 PROJECT 19531
 GRANITE CITY, IL

QUANTITY SUMMARY FOR 915/17 Iowa

SPECIAL WASTE (TONS)	BACKFILL (LOADS)	TOPSOIL (TONS)	CA-6 (TONS)	CA-7 (TONS)	SAND (TONS)	SOD CU.YDS.	CONCRETE	OTHER
120.01	3	87.95		12.85		360		

Sampling Analysis Project #19531

0 - 3" Front and Back

	A		A	
Street/Number	PPM	No.	PPM	No.
Address	No.	No.	No.	No.

915/17 Iowa
371 73
773 274
96 821

3 - 6" Front and Back

B	B	B
PPM	PPM	PPM
No.	No.	No.

242 656
427 452
582 337


6 - 12" Front and Back

C	C	C
PPM	PPM	PPM
No.	No.	No.

148 78
234 112

Depth
Excav.
(inch)

6

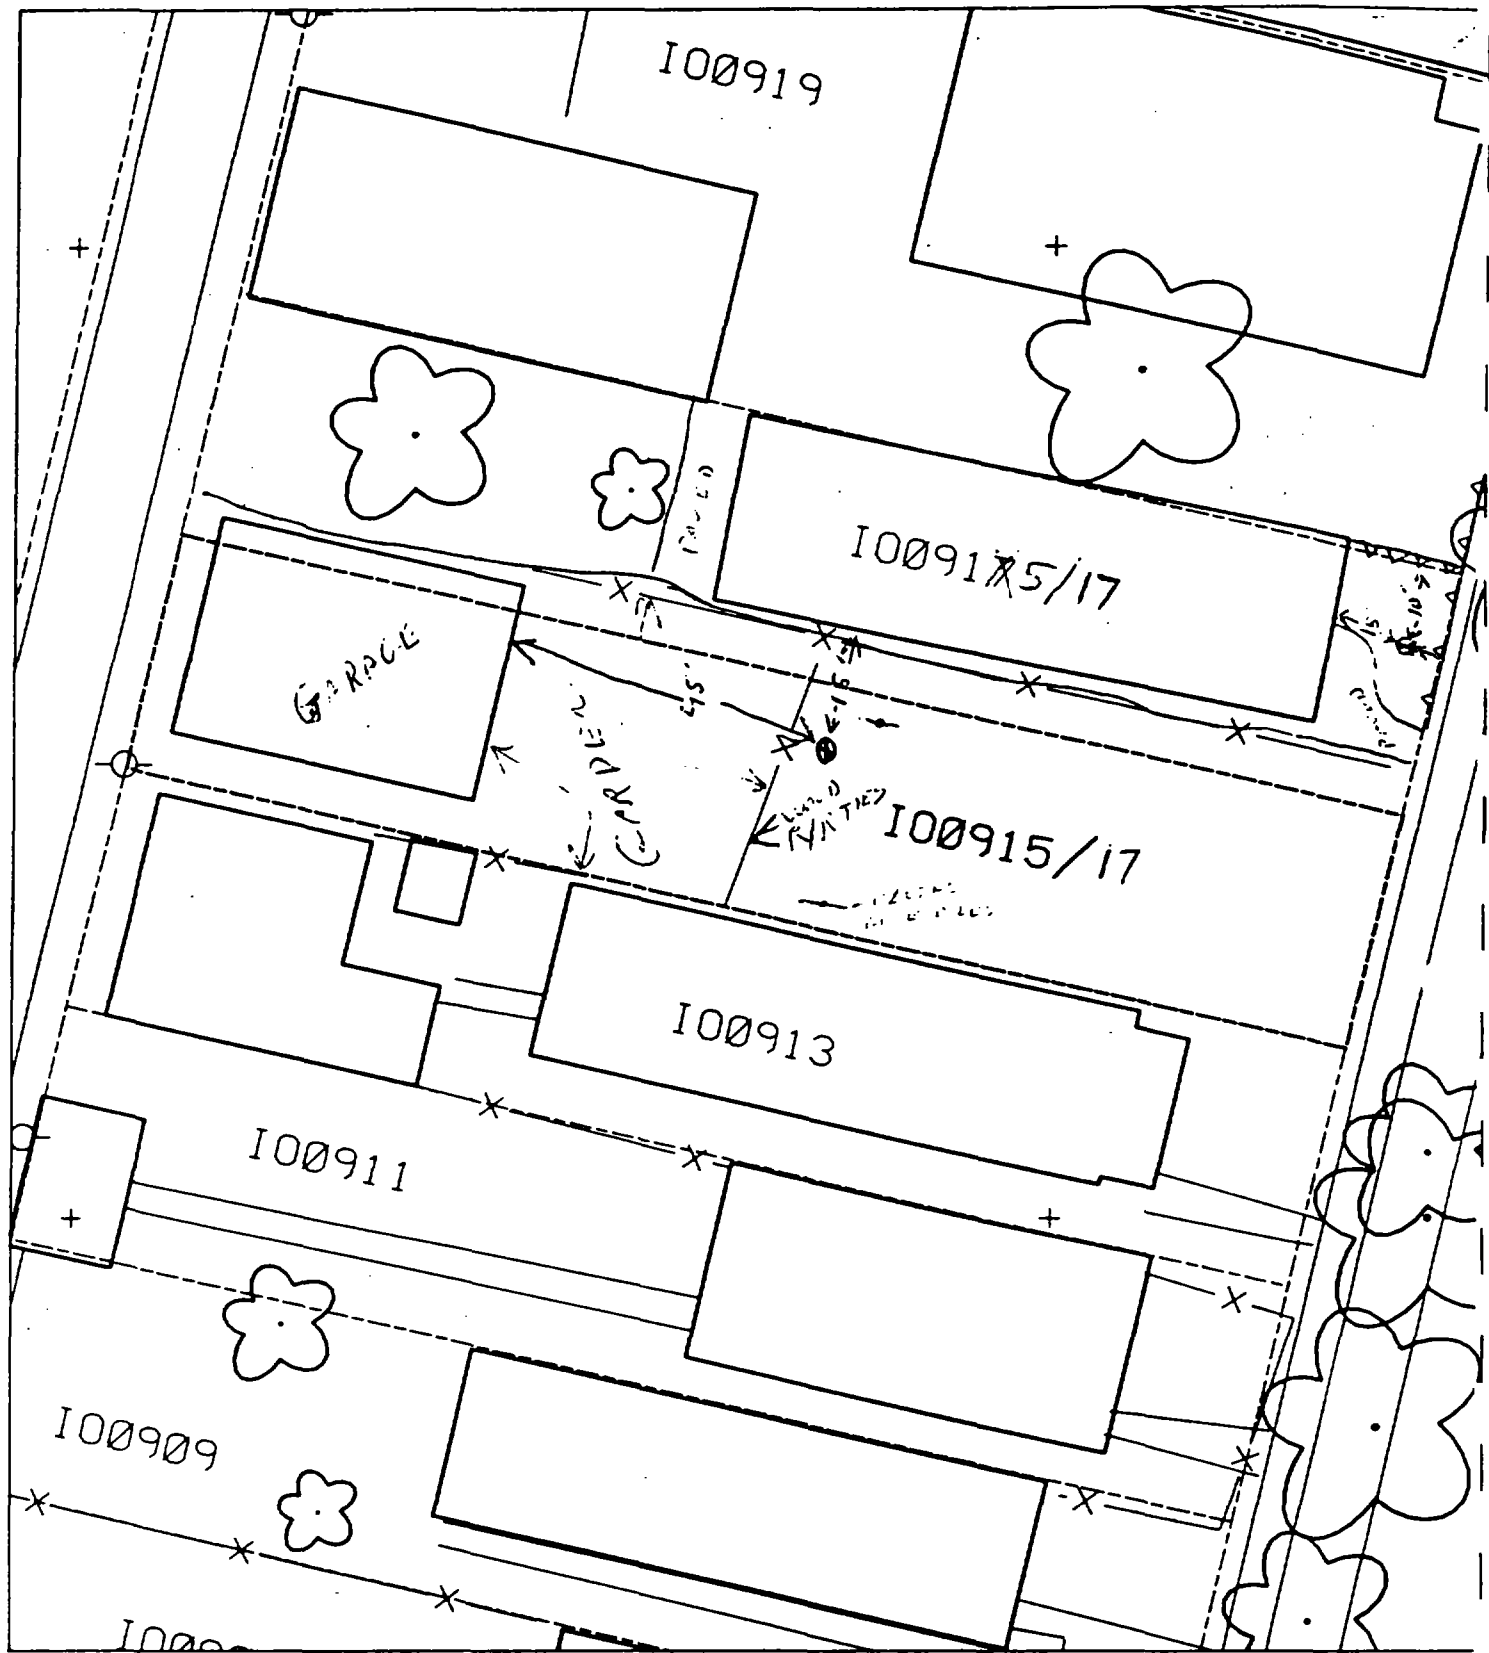

15' - 15' EAST HOUSE & 10' SOUTH
OF FENCE

15' - 15' SOUTH HOUSE & 45' EAST
OF GARAGE

65' 2' paved & house

1

2

3

Action Date: 10/30/97

Loadout: 11/4/97

Restoration Begins: 11/4/97

Restoration Completed: 11/17/97

*Stack emission sites were not sampled for verification due to the fact that a pre-determined depth for excavation was given to OHM by USACE.

*An excavation depth of 6 inches was established by USACE prior to work commencing.

*The excavation of special waste yielded a total of 191.80 cubic yards, which was shipped to WMI-Milam for disposal.

*Equipment utilized during excavation:

*TL-26

*TCM

*X331

*17-KW

*Subcontractors:

*WMI-landfill

*B. Garcia-trucking

*Granthum-trucking

*Emerald Turf Farm

OHM CORPORATION
PROJECT 19531
GRANITE CITY, IL

QUANTITY SUMMARY FOR 916 Iowa

SPECIAL WASTE (TONS)	BACKFILL (LOADS)	TOPSOIL (TONS)	CA-6 (TONS)	CA-7 (TONS)	SAND (TONS)	SOD CU.YDS.	CONCRETE	OTHER
249.34	24		28.15			1200		

**Sampling Analysis
Project #19531**

0 - 3" Front and Back			
A	A	A	A
Street/Number	PPM	PPM	PPM
Address	No.	No.	No.

916 Iowa 596 371

3 - 6" Front and Back			
B	B	B	B
PPM	PPM	PPM	PPM
No.	No.	No.	No.


456 923

6 - 12" Front and Back			
C	C	C	C
PPM	PPM	PPM	PPM
No.	No.	No.	No.

60 100

Depth
Excav.
(inch)

6

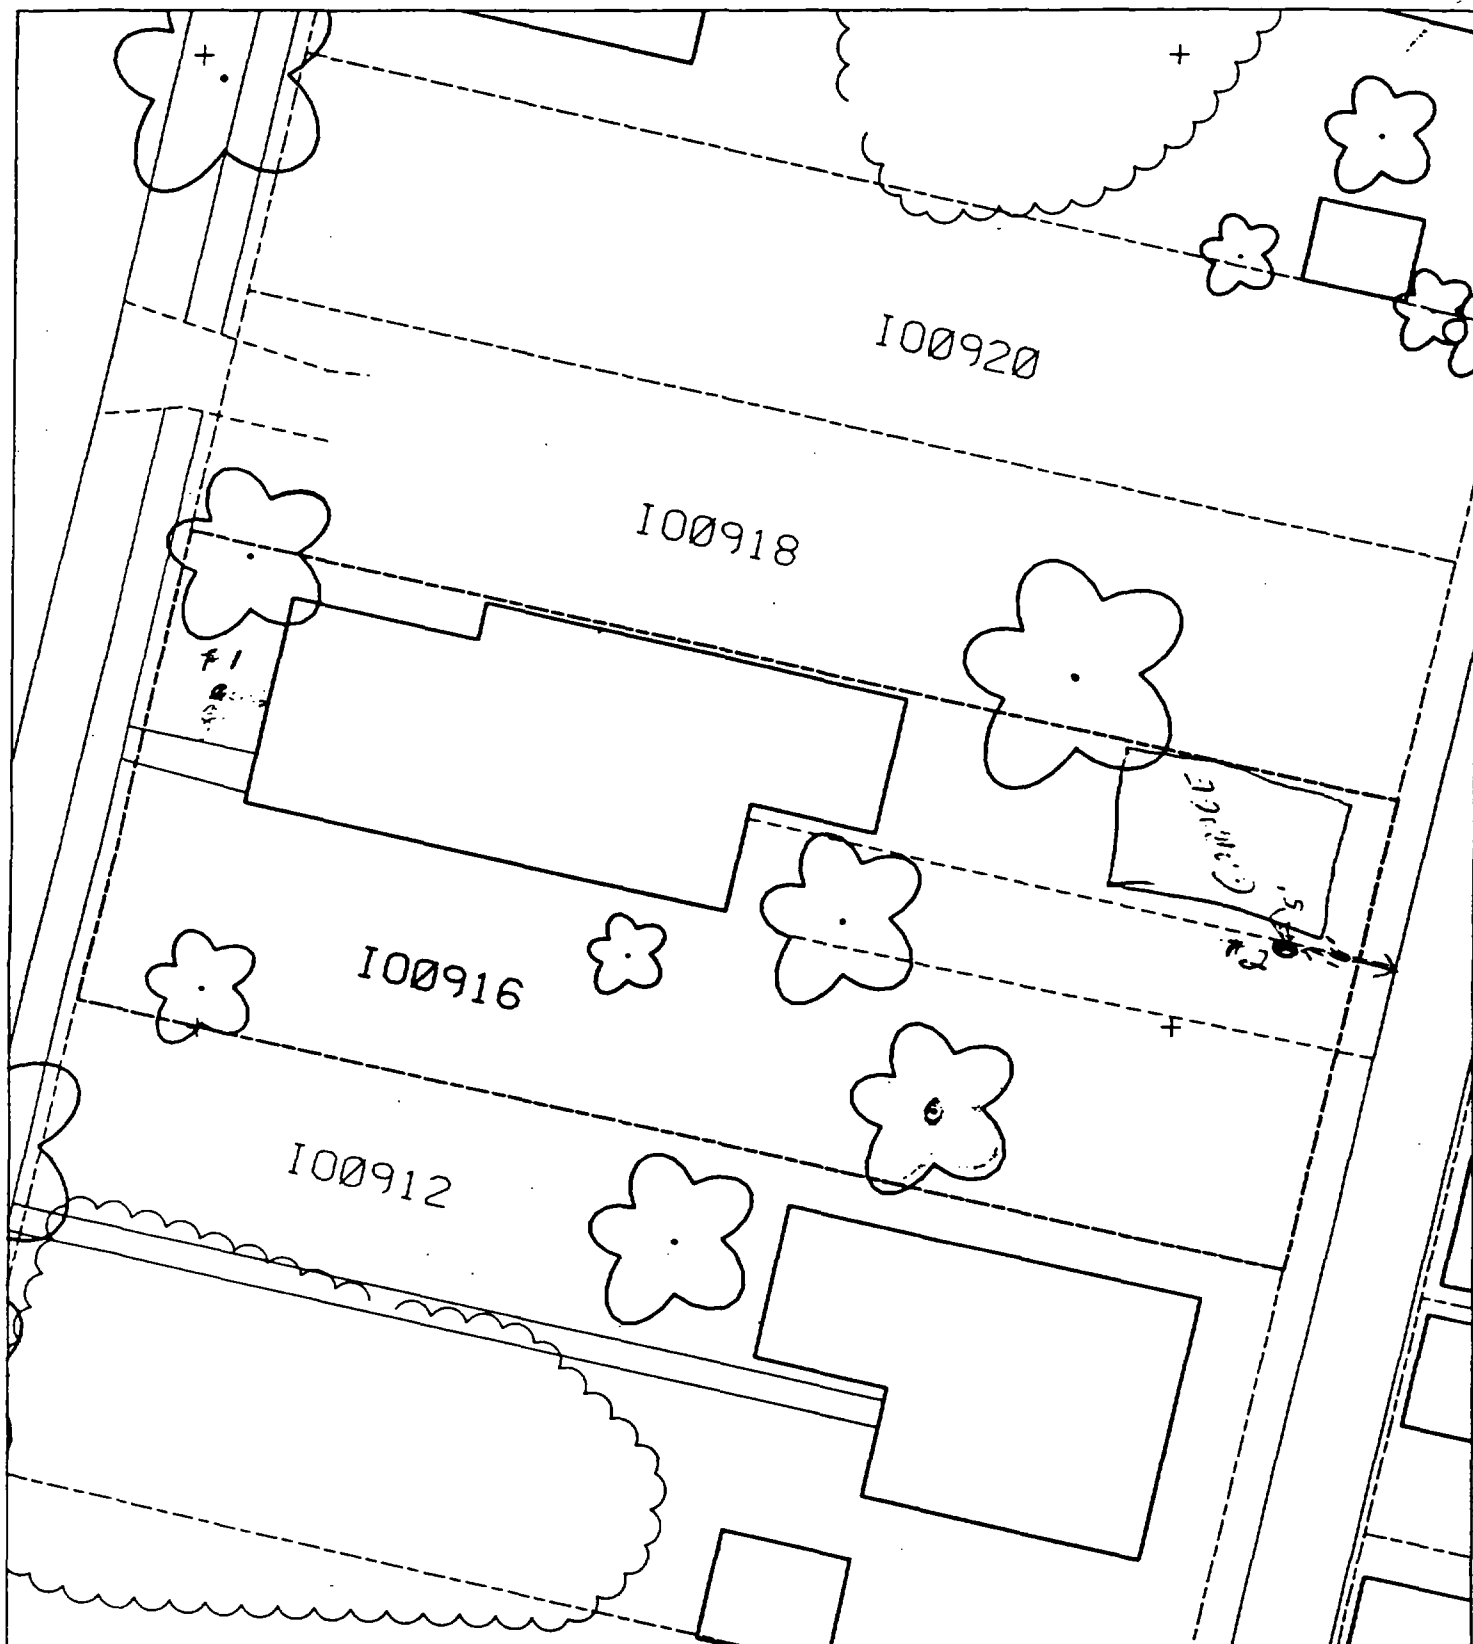

1 - 10' WEST OF HOUSE &
8' NORTH OF SIDEWALK.

B - 5' SOUTH OF GARAGE
16' WEST OF ALLEY.

45
3 75' 70' yard & house
OFF

)

)

)

Action Date: 11/14/97

Loadout: 11/17/97

Restoration Begins: 11/17/97

Restoration Completed: 11/19/97

*Stack emission sites were not sampled for verification due to the fact that a pre-determined depth for excavation was given to OHM by USACE.

*An excavation depth of 12 inches was established by USACE prior to work commencing.

*The excavation of special waste yielded a total of 149.15 cubic yards, which was shipped to WMI-Milam for disposal.

*Equipment utilized during excavation:

*TL-26

*TCM

*X331

*17-KW

*Subcontractors:

*WMI-landfill

*B. Garcia-trucking

*Granthum-trucking

*Schneider Turf Farm

OHM CORPORATION
 PROJECT 19531
 GRANITE CITY, IL

QUANTITY SUMMARY FOR 922 Iowa

SPECIAL WASTE (TONS)	BACKFILL (LOADS)	TOPSOIL (TONS)	CA-6 (TONS)	CA-7 (TONS)	SAND (TONS)	SOD CU.YDS.	CONCRETE	OTHER
193.9	13	18.08		14.1		420		

**Sampling Analysis
Project #19531**

0 - 3" Front and Back

Street/Number Address	A		A	
	PPM	No.	PPM	No.
922 Iowa	364	522		


3 - 6" Front and Back

	B		B	
	PPM	No.	PPM	No.
	451	492		

6 - 12" Front and Back

	C		C	
	PPM	No.	PPM	No.
	290	509		
	225	405		

	Depth	
	Excav.	(inch)
		12

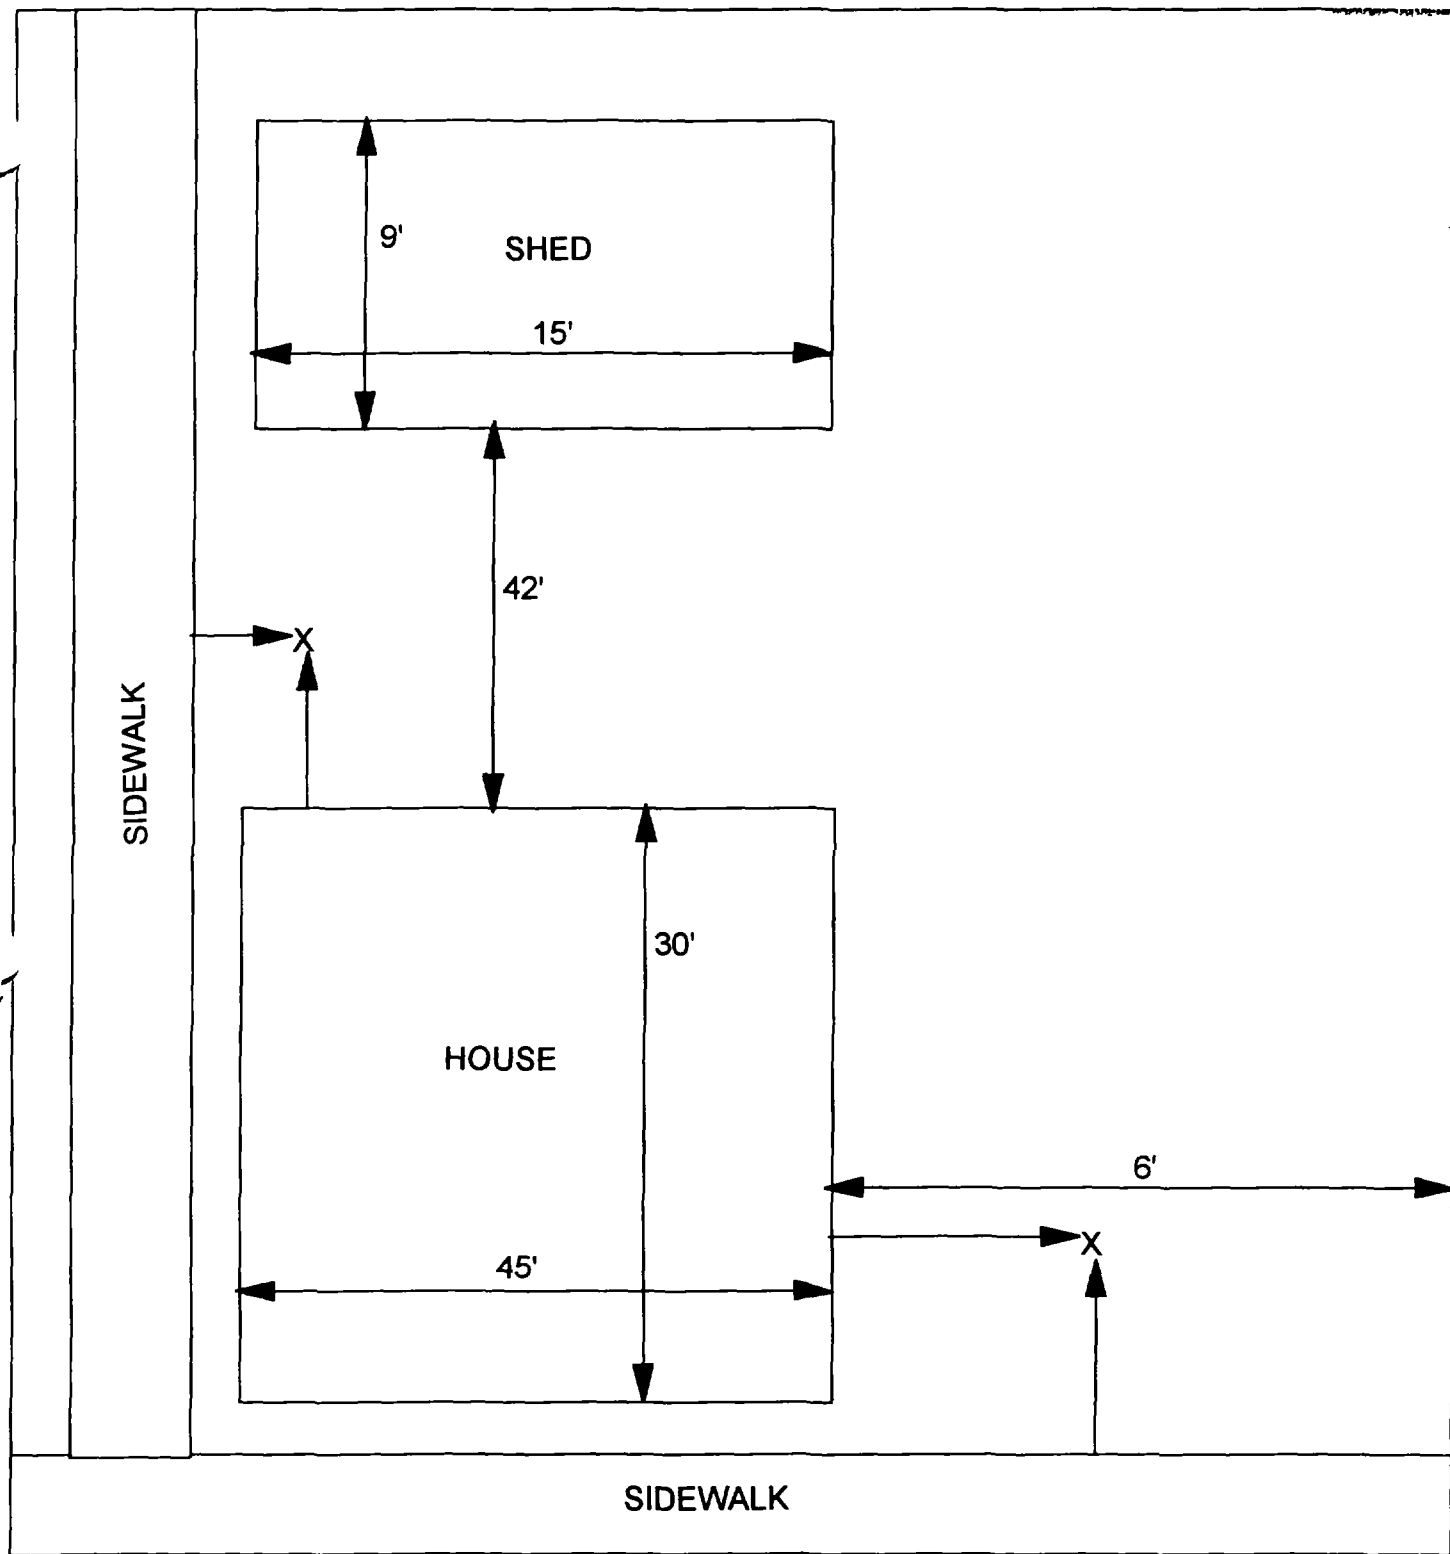

X - SAMPLE POINT

922 IOWA
54' X 91'

OHM 
Corporation
Findlay, Ohio

Drawn By: EDJ	Checked By:
Date: 10/14/98	Approved By:
Scale: NTS	Drawing No:

1

2

3

Action Date: 12/29/97

Loadout: 12/30/97

Restoration Begins: 12/31/97

Restoration Completed: 1/30/98

*Stack emission sites were not sampled for verification due to the fact that a pre-determined depth for excavation was given to OHM by USACE.

*An excavation depth of 3 inches was established by USACE prior to work commencing.

*The excavation of special waste yielded a total of 83.22 cubic yards, which was shipped to WMI-Milam for disposal.

*Equipment utilized during excavation:

*TL-26

*TCM

*X331

*17-KW

*Subcontractors:

*WMI-landfill

*B. Garcia-trucking

*Granthum-trucking

*Highland Turf Farm

OHM CORPORATION
 PROJECT 19531
 GRANITE CITY, IL

QUANTITY SUMMARY FOR 925 Iowa

SPECIAL WASTE (TONS)	BACKFILL (LOADS)	TOPSOIL (TONS)	CA-6 (TONS)	CA-7 (TONS)	SAND (TONS)	SOD CU.YDS.	CONCRETE	OTHER
108.19	9			7.5		700		

**Sampling Analysis
Project #19531**

0 - 3" Front and Back

Street/Number Address	A		A	
	PPM	No.	PPM	No.
925 Iowa	1198	33	138	130
	685		523	


3 - 6" Front and Back

B		B	
PPM	No.	PPM	No.
336		242	

6 - 12" Front and Back

C		C	
PPM	No.	PPM	No.
45		33	

Depth Excav. (inch)
3

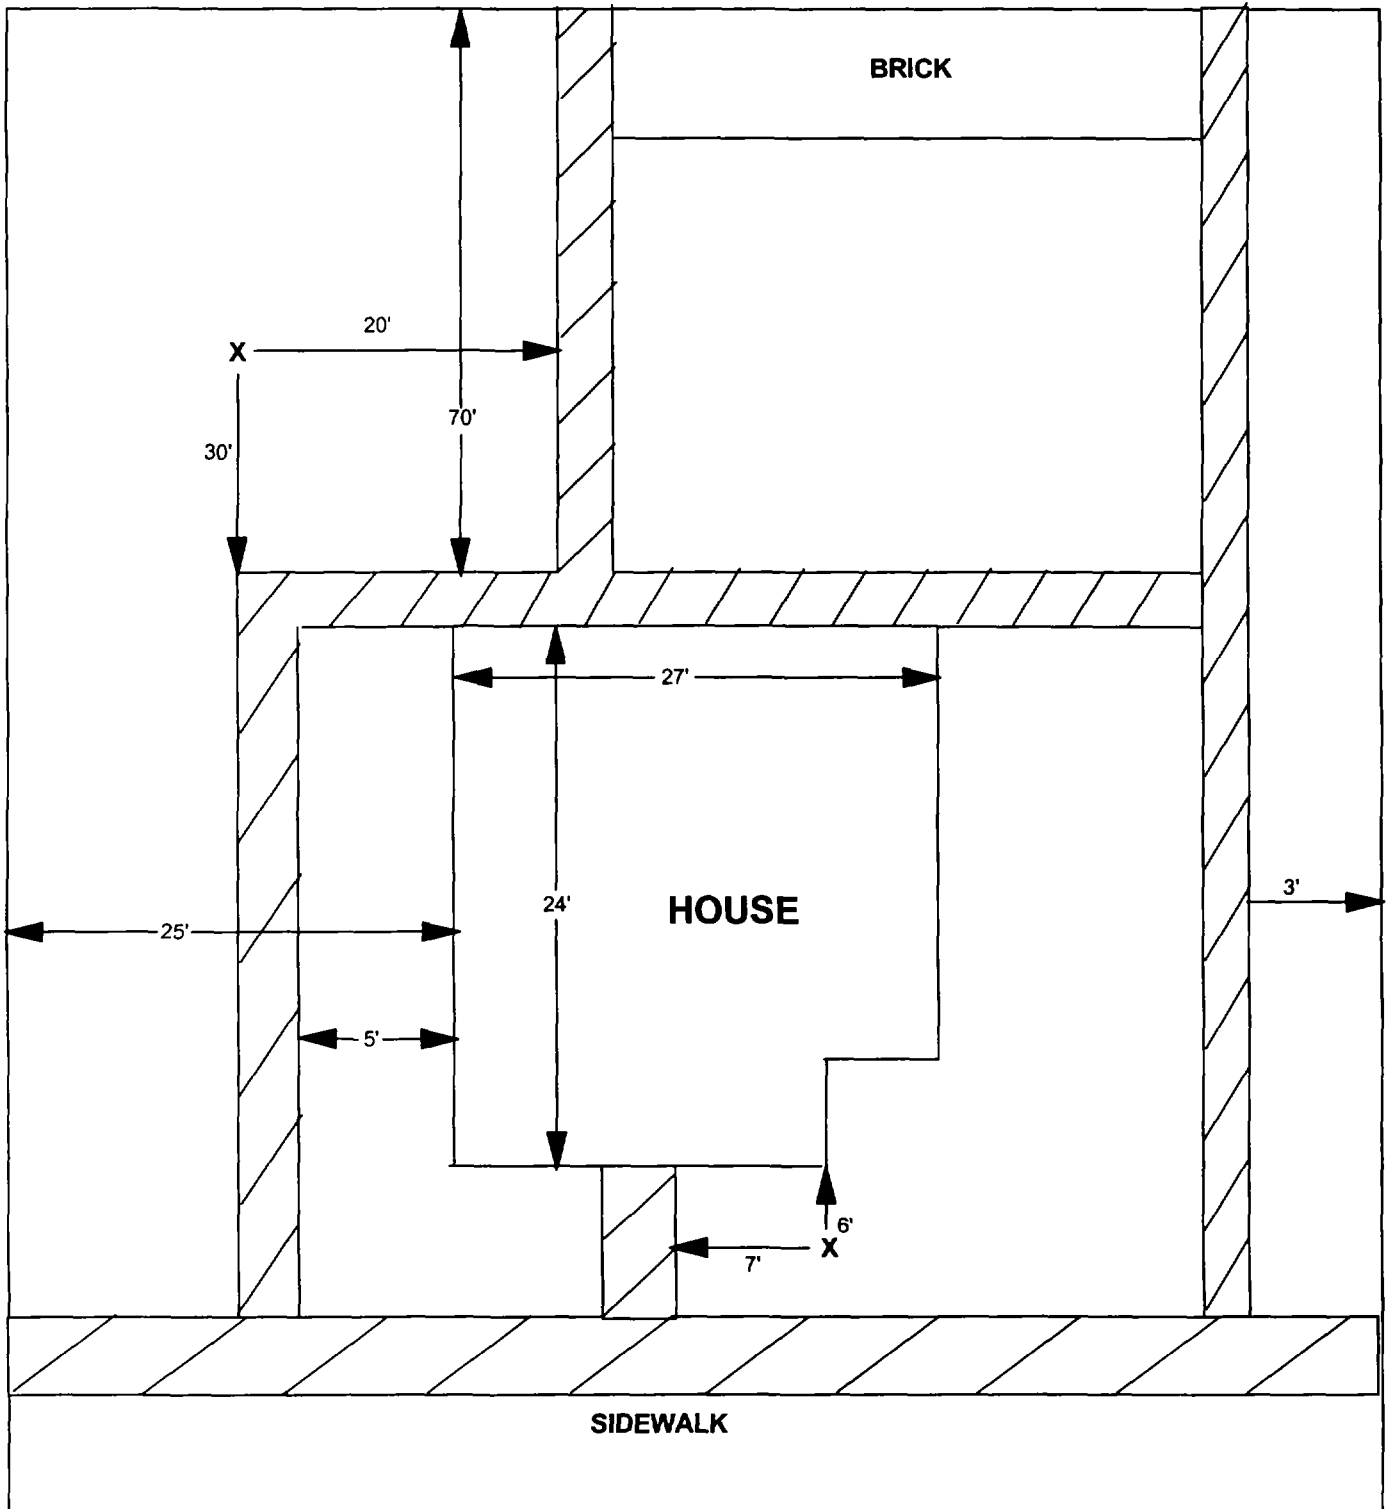

X = SAMPLE POINT

925 IOWA

**TOTAL
DIMENSIONS
108'X58'**

OHM 
Corporation
Findlay, Ohio

Drawn By: **JG** Checked By:

Date: **8/20/98** Approved By:

Scale: **NTS** Drawing No:

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.)

.)

Action Date: 12/6/97

Loadout: 12/8/97

Restoration Begins: 12/9/97

Restoration Completed: 12/19/97

*Stack emission sites were not sampled for verification due to the fact that a pre-determined depth for excavation was given to OHM by USACE.

*An excavation depth of 12 inches was established by USACE prior to work commencing.

*The excavation of special waste yielded a total of 44.86 cubic yards, which was shipped to WMI-Milam for disposal.

*Equipment utilized during excavation:

*TL-26

*TCM

*X331

*17-KW

*Subcontractors:

*WMI-landfill

*B. Garcia-trucking

*Granthum-trucking

*Emerald Turf Farm

OHM CORPORATION
PROJECT 19531
GRANITE CITY, IL

QUANTITY SUMMARY FOR 1004/06 Iowa

SPECIAL WASTE (TONS)	BACKFILL (LOADS)	TOPSOIL (TONS)	CA-6 (TONS)	CA-7 (TONS)	SAND (TONS)	SOD CU.YDS.	CONCRETE	OTHER
58.33	2	13.92	58.05	12.85		180		

Sampling Analysis
Project #19531

0 - 3" Front and Back

Street/Number Address	A			
	PPM	PPM	PPM	PPM
	No.	No.	No.	No.

1004/06 Iowa 549 537 514

3 - 6" Front and Back

	B			
	PPM	PPM	PPM	PPM
	No.	No.	No.	No.

376 197 457

6 - 12" Front and Back

	C			
	PPM	PPM	PPM	PPM
	No.	No.	No.	No.

699 115 300
399 992

	Depth Excav. (inch)

12

101012A

101008

GRAVEL

GRAVEL

101004/1006

← 20' → 31
↑ 13' TREE
↓ CONC

101002

70% PAVED

B₁ - 01
2nd EAST OF HOUSE
131 NORTH OF SIDEWALK

DOE TO FLOWERS

)

)

)

Action Date: 12/5/97

Loadout: 12/8/97

Restoration Begins: 12/9/97

Restoration Completed: 12/19/97

*Stack emission sites were not sampled for verification due to the fact that a pre-determined depth for excavation was given to OHM by USACE.

*An excavation depth of 12 inches was established by USACE prior to work commencing.

*The excavation of special waste yielded a total of 137.43 cubic yards, which was shipped to WMI-Milam for disposal.

*Equipment utilized during excavation:

*TL-26

*TCM

*X331

*17-KW

*Subcontractors:

*WMI-landfill

*B. Garcia-trucking

*Grantham-trucking

*Emerald-turf farm

**OHM CORPORATION
PROJECT 19531
GRANITE CITY, IL**

QUANTITY SUMMARY FOR

1008 Iowa

SPECIAL WASTE (TONS)	BACKFILL (LOADS)	TOPSOIL (TONS)	CA-6 (TONS)	CA-7 (TONS)	SAND (TONS)	SOD CU.YDS.	CONCRETE	OTHER
178.66	6	28.07	91.66			81		

**Sampling Analysis
Project #19531**

0 - 3" Front and Back

Street/Number Address	A		A	
	PPM	No.	PPM	No.
1008 Iowa	715	2692		


3 - 6" Front and Back

B		B	
PPM	No.	PPM	No.
492	3101		

6 - 12" Front and Back

C		C	
PPM	No.	PPM	No.
317	1167		
452	986		

Depth Excav. (inch)
12

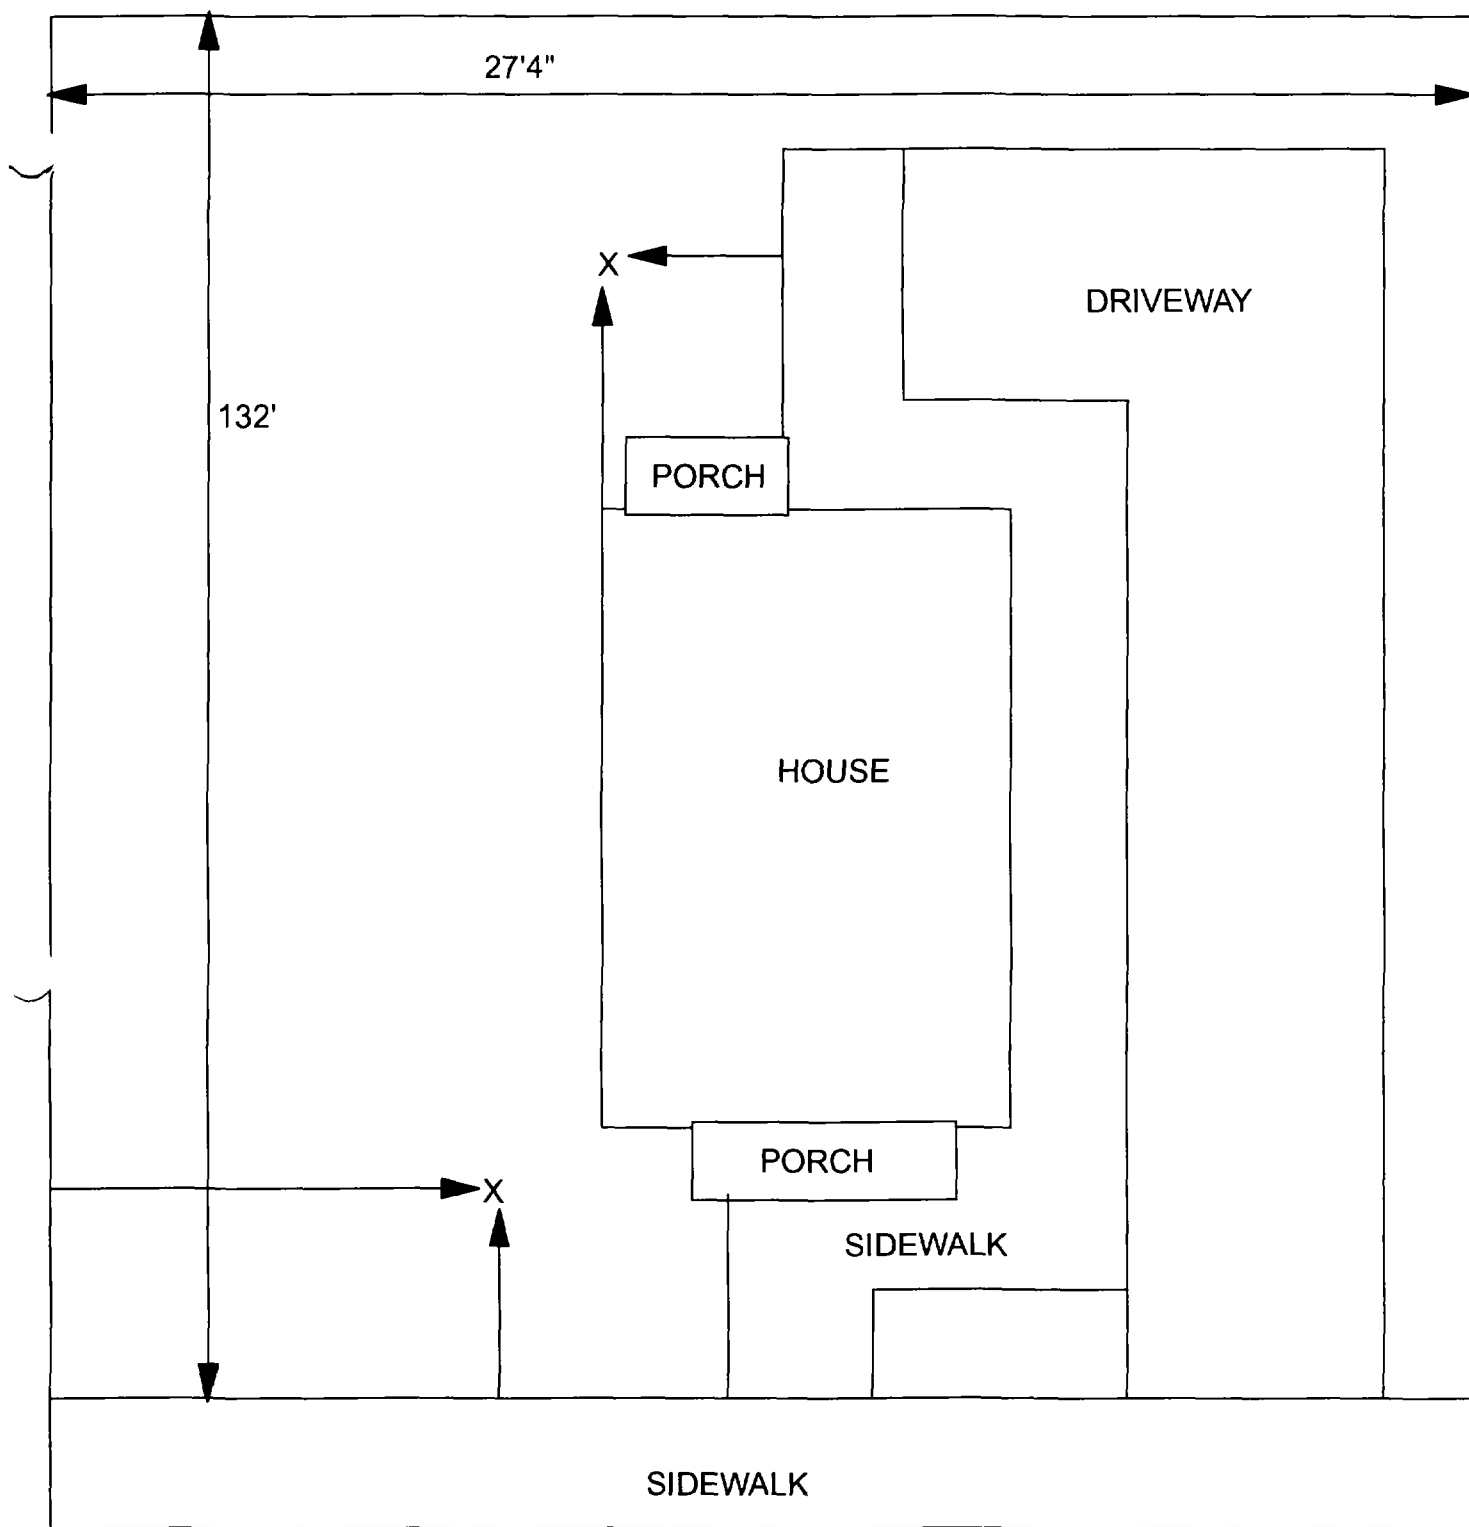

X = SAMPLE POINT

1008 IOWA
27'4" X 132'

OHM 
Corporation
Findlay, Ohio

Drawn By: EDJ	Checked By:
Date: 7/29/98	Approved By:
Scale: NTS	Drawing No:

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—

Action Date: 12/13/97

Loadout: 12/16/97

Restoration Begins: 12/16/97

Restoration Completed: 12/19/97

*Stack emission sites were not sampled for verification due to the fact that a pre-determined depth for excavation was given to OHM by USACE.

*An excavation depth of 12 inches was established by USACE prior to work commencing.

*The excavation of special waste yielded a total of 58.39 cubic yards, which was shipped to WMI-Milam for disposal.

*Equipment utilized during excavation:

*TL-26

*TCM

*X331

*17-KW

*Subcontractors:

*WMI-landfill

*B. Garcia-trucking

*Grantham-trucking

*Emerald-turf farm

OHM CORPORATION
PROJECT 19531
GRANITE CITY, IL

QUANTITY SUMMARY FOR

1013 Iowa

SPECIAL WASTE (TONS)	BACKFILL (LOADS)	TOPSOIL (TONS)	CA-6 (TONS)	CA-7 (TONS)	SAND (TONS)	SOD CU.YDS.	CONCRETE	OTHER
75.91	4	31.23				240		

**Sampling Analysis
Project #19531**

Street/Number Address	0 - 3" Front and Back			
	A		A	
	PPM	No.	PPM	No.

1013 Iowa

150
243

746
758

3 - 6" Front and Back	B		B	
	PPM		PPM	
	No.	No.	No.	No.

192
247

740
2740



6 - 12" Front and Back	C		C	
	PPM		PPM	
	No.	No.	No.	No.

233
136

763
607


Depth Excav. (inch)

12

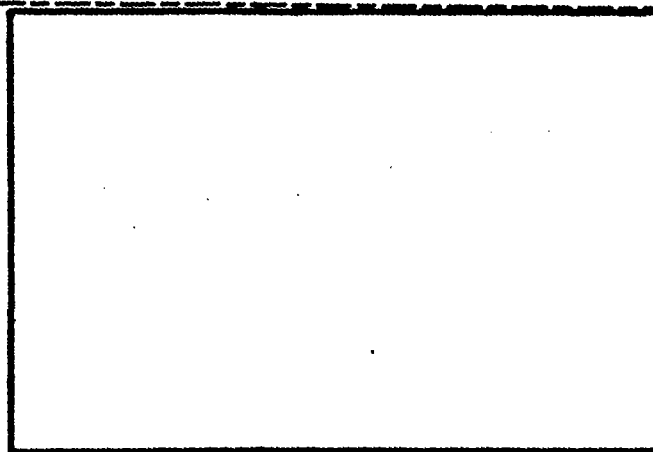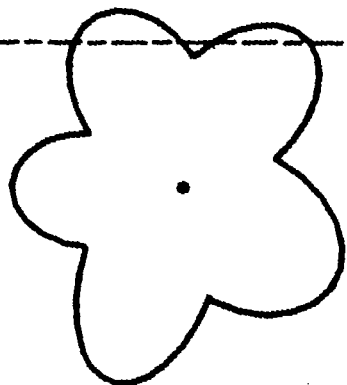

I01015


013

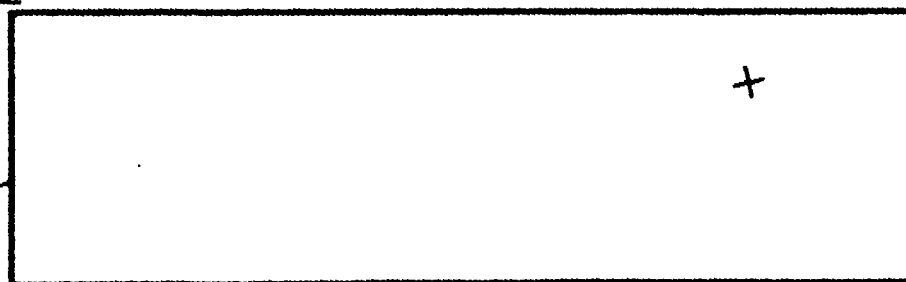


I01011

B2

7'-
10'

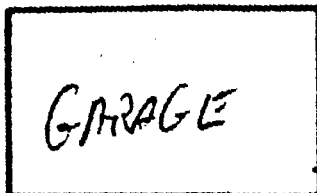

B1
4' ← 13' -

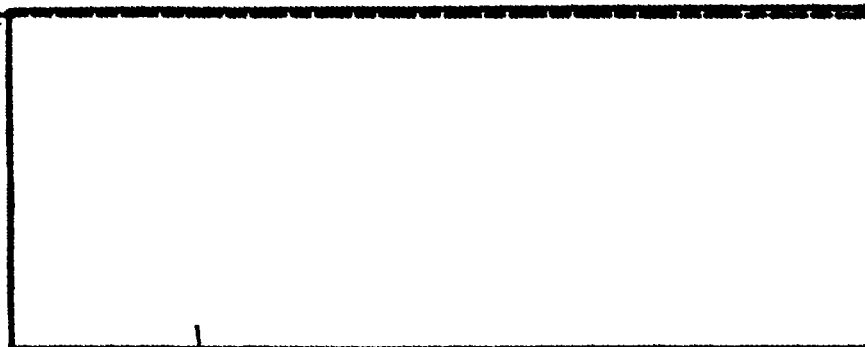

Action Date: 3/30/98

Loadout: 4/2/98

Restoration Begins: 4/2/98

Restoration Completed: 4/9/98

*Stack emission sites were not sampled for verification due to the fact that a pre-determined depth for excavation was given to OHM by USACE.

*An excavation depth of 6 inches was established by USACE prior to work commencing.

*The excavation of special waste yielded a total of 64.86 cubic yards, which was shipped to WMI-Milam for disposal.

*Equipment utilized during excavation:

*TL-26

*TCM

*X331

*17-KW

*Subcontractors:

*WMI-landfill

*B. Garcia-trucking

*Grantham-trucking

*Emerald Turf Farm

OHM CORPORATION
 PROJECT 19531
 GRANITE CITY, IL

QUANTITY SUMMARY FOR 1015 Iowa

SPECIAL WASTE (TONS)	BACKFILL (LOADS)	TOPSOIL (TONS)	CA-6 (TONS)	CA-7 (TONS)	SAND (TONS)	SOD CU.YDS.	CONCRETE	OTHER
84.33	7					300		

**Sampling Analysis
Project #19531**

0 - 3" Front and Back

Street/Number Address	A	
	PPM	No.
1015 Iowa	607	464


3 - 6" Front and Back

B	B	
	PPM	No.
603	184	
476	127	

6 - 12" Front and Back

C	C	
	PPM	No.
393	113	

Depth	
Excav.	(inch)
	6

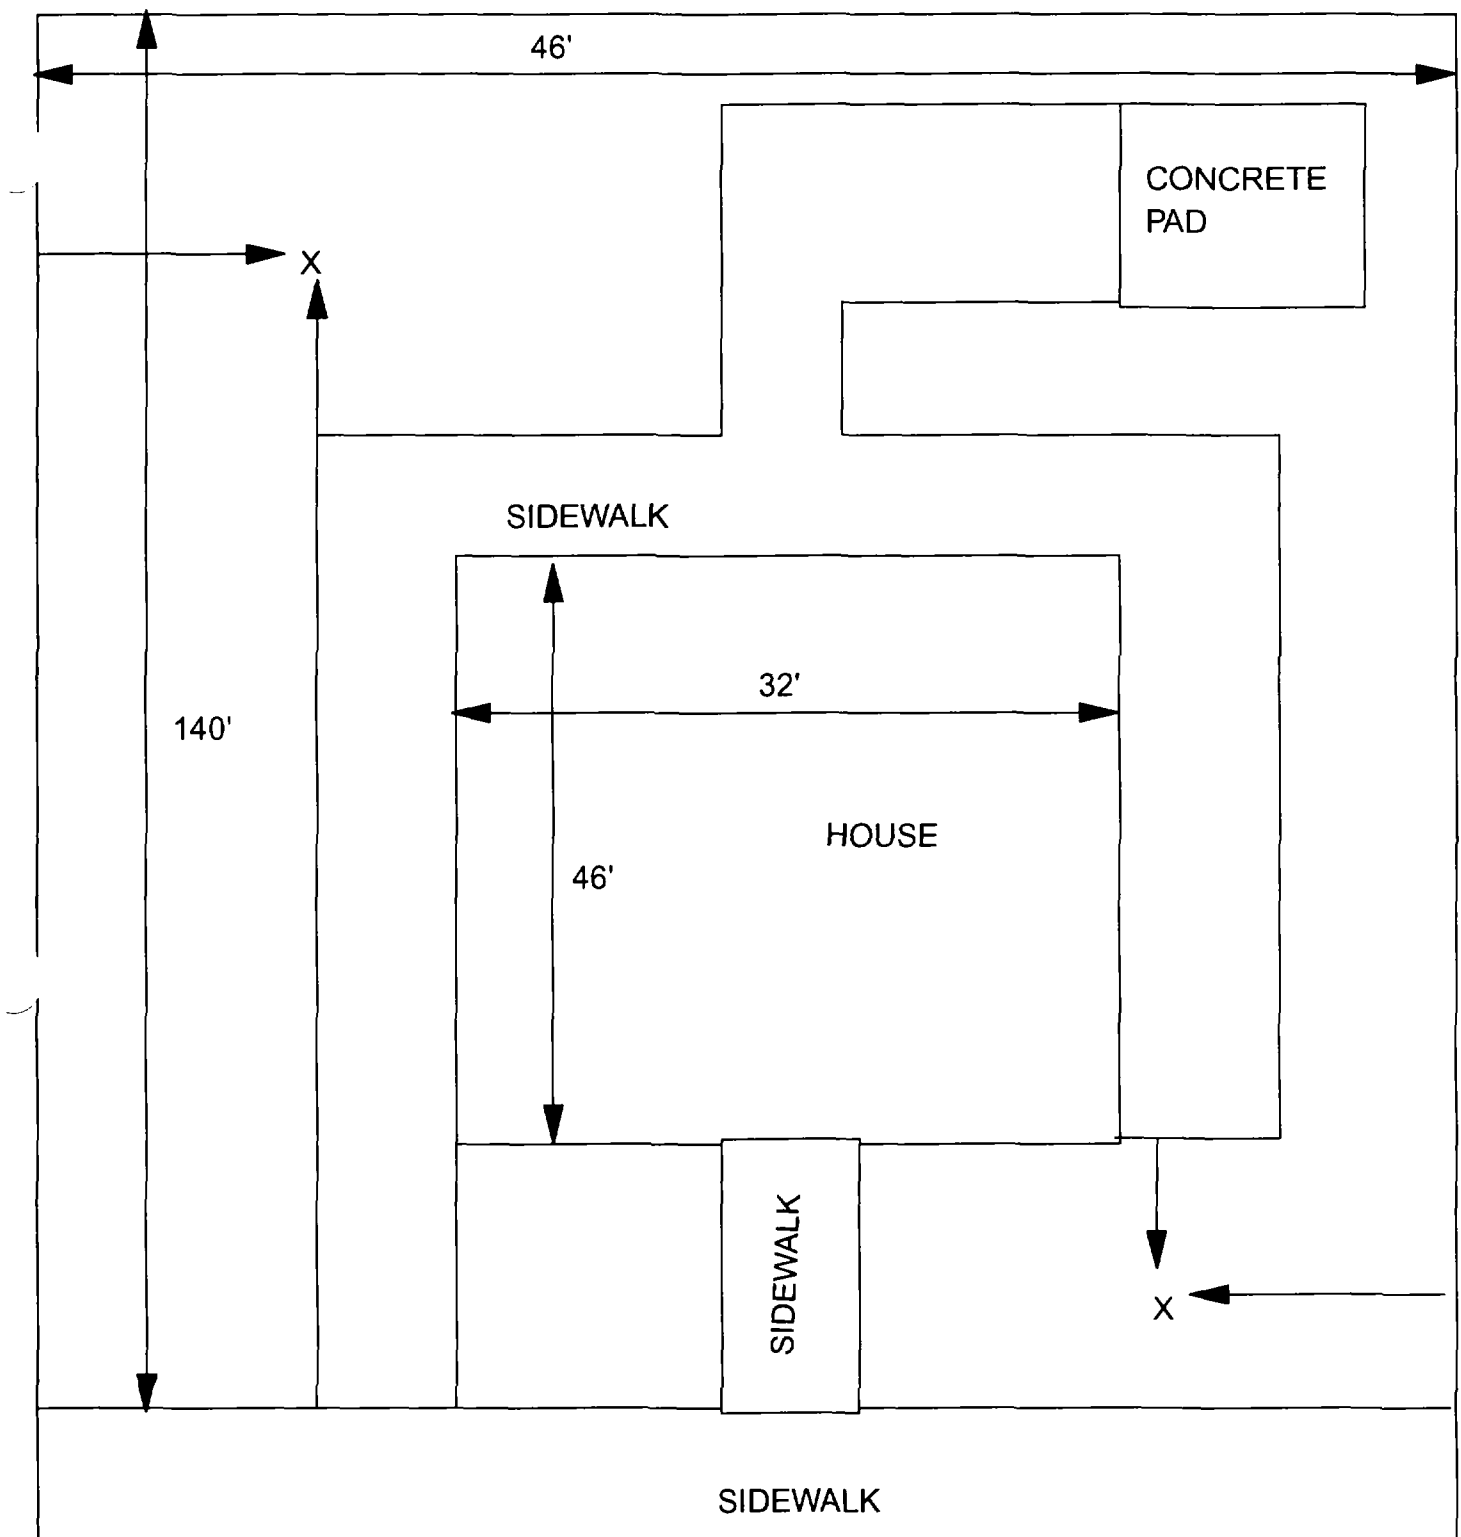

X = SAMPLE POINT

1015 IOWA
46' X 140'

OHM 
Corporation
Findlay, Ohio

Drawn By: **EDJ**

Checked By:

Date: **7/29/98**

Approved By:

Scale: **NTS**

Drawing No:

1

2

3

Action Date: 4/13/98

Loadout: 4/20/98

Restoration Begins: 4/21/98

Restoration Completed: 4/25/98

*Stack emission sites were not sampled for verification due to the fact that a pre-determined depth for excavation was given to OHM by USACE.

*An excavation depth of 6 inches was established by USACE prior to work commencing.

*The excavation of special waste yielded a total of 114.18 cubic yards, which was shipped to WMI-Milam for disposal.

*Equipment utilized during excavation:

*TL-26

*TCM

*X331

*17-KW

*Subcontractors:

*WMI-landfill

*B. Garcia-trucking

*Grantham-trucking

*Emerald Turf Farm

OHM CORPORATION
PROJECT 19531
GRANITE CITY, IL

QUANTITY SUMMARY FOR 1030 Iowa

SPECIAL WASTE (TONS)	BACKFILL (LOADS)	TOPSOIL (TONS)	CA-6 (TONS)	CA-7 (TONS)	SAND (TONS)	SOD CU.YDS.	CONCRETE	OTHER
148.44	12	24.49				600		

**Sampling Analysis
Project #19531**

0 - 3" Front and Back

Street/Number Address	A			
	A		A	
	PPM	No.	PPM	No.

1030 Iowa

496
1234

492
316

233

3 - 6" Front and Back

	B		B	
	PPM		PPM	
	No.	No.	No.	No.

398
679

447
311

301

6 - 12" Front and Back

	C		C	
	PPM		PPM	
	No.	No.	No.	No.

213
282

155
368


211

Depth
Excav.
(inch)

6



54+41

I01116

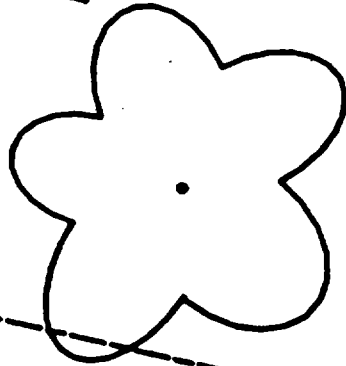


I01030


+

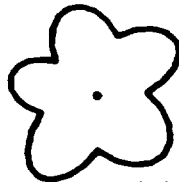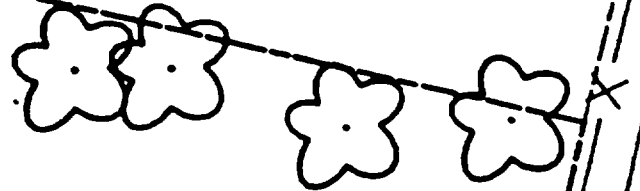

B2

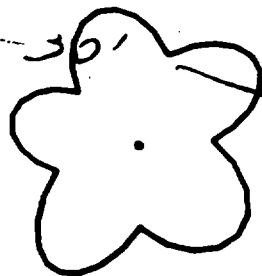

11'
10'

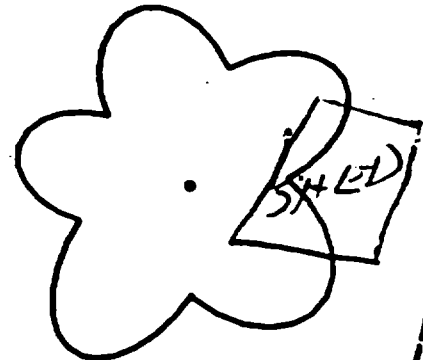

conc

I01026



—

—

—

Action Date: 4/6/98

Loadout: 4/7/98

Restoration Begins: 4/7/98

Restoration Completed: 4/25/98

*Stack emission sites were not sampled for verification due to the fact that a pre-determined depth for excavation was given to OHM by USACE.

*An excavation depth of 3 inches was established by USACE prior to work commencing.

*The excavation of special waste yielded a total of 145.75 cubic yards, which was shipped to WMI-Milam for disposal.

*Equipment utilized during excavation:

*TL-26

*TCM

*X331

*17-KW

*Subcontractors:

*WMI-landfill

*B. Garcia-trucking

*Grantham-trucking

*Emerald Turf Farm

OHM CORPORATION
PROJECT 19531
GRANITE CITY, IL

QUANTITY SUMMARY FOR 1109 Iowa

SPECIAL WASTE (TONS)	BACKFILL (LOADS)	TOPSOIL (TONS)	CA-6 (TONS)	CA-7 (TONS)	SAND (TONS)	SOD CU.YDS.	CONCRETE	OTHER
189.48	10	28	25.35			900		

**Sampling Analysis
Project #19531**

0 - 3" Front and Back

Street/Number Address	A		A	
	PPM	No.	PPM	No.
1109 Iowa	203	335		
	648	811		

3 - 6" Front and Back



	B		B	
	PPM	No.	PPM	No.
	133	408		
	361	103		

6 - 12" Front and Back


	C		C	
	PPM	No.	PPM	No.
	39	355		
	743	40		
	281	64		

Depth
Excav.
(inch)

3

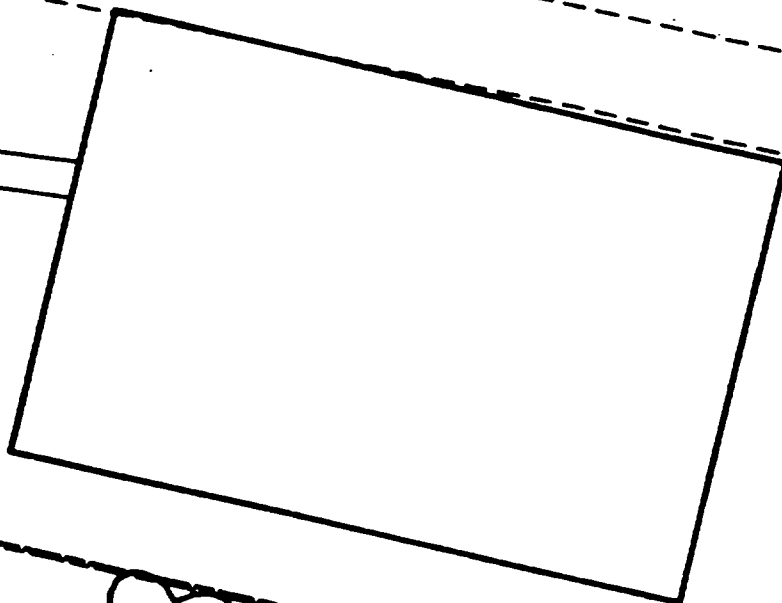
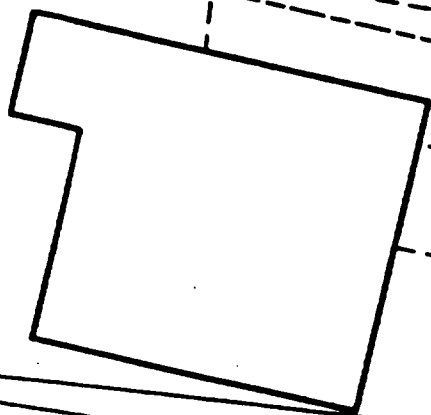


I01115

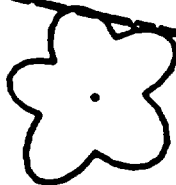

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I01109

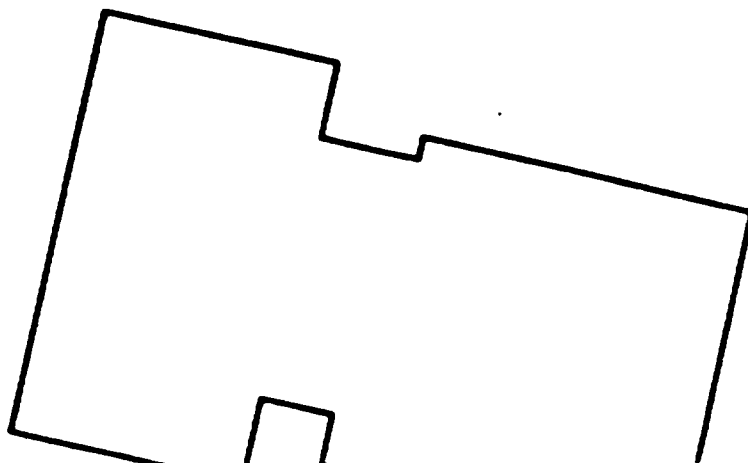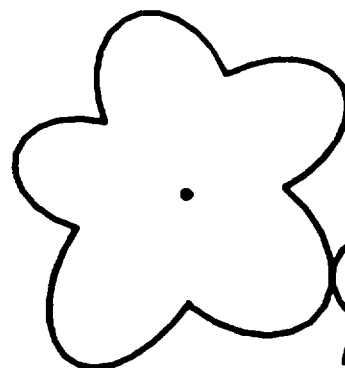

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Action Date: 4/6/98

Loadout: 4/8/98

Restoration Begins: 4/9/98

Restoration Completed: 4/21/98

*Stack emission sites were not sampled for verification due to the fact that a pre-determined depth for excavation was given to OHM by USACE.

*An excavation depth of 12 inches was established by USACE prior to work commencing.

*The excavation of special waste yielded a total of 120.40 cubic yards, which was shipped to WMI-Milam for disposal.

*Equipment utilized during excavation:

*TL-26

*TCM

*X331

*17-KW

*Subcontractors:

*WMI-landfill

*B. Garcia-trucking

*Grantham-trucking

*Emerald Turf Farm

OHM CORPORATION
PROJECT 19531
GRANITE CITY, IL

QUANTITY SUMMARY FOR 1115 Iowa

SPECIAL WASTE (TONS)	BACKFILL (LOADS)	TOPSOIL (TONS)	CA-6 (TONS)	CA-7 (TONS)	SAND (TONS)	SOD CU.YDS.	CONCRETE	OTHER
156.52	14	33.65	13.2			300		

**Sampling Analysis
Project #19531**

0 - 3" Front and Back

Street/Number Address	A		A	
	PPM	No.	PPM	No.
1115 Iowa	462	354		
	626	404		

3 - 6" Front and Back



	B		B	
	PPM	No.	PPM	No.
	412	399		
	489	219		

6 - 12" Front and Back


	C		C	
	PPM	No.	PPM	No.
	137	267		
	1058	257		
	650	246		

Depth
Excav.
(inch)

12

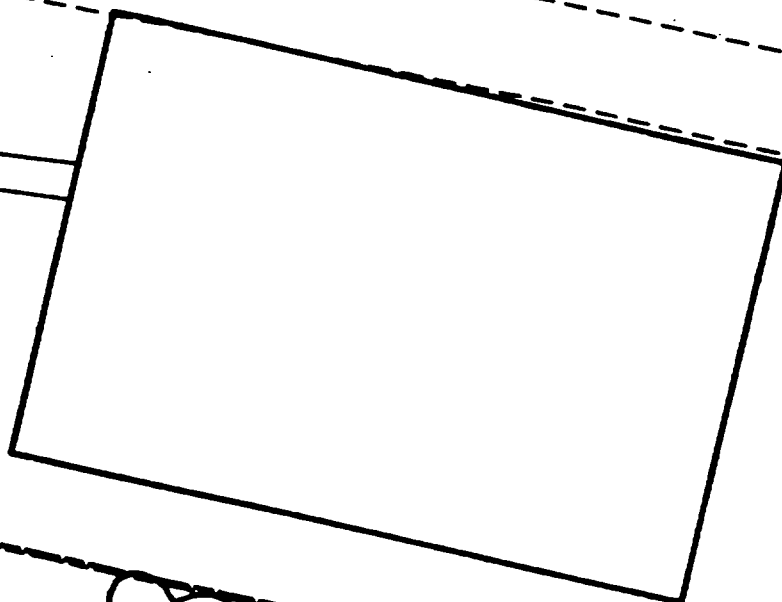
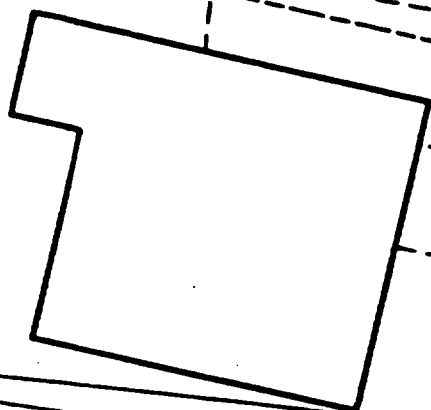


I01115

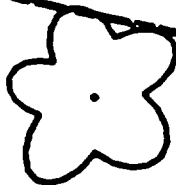

+

I01109

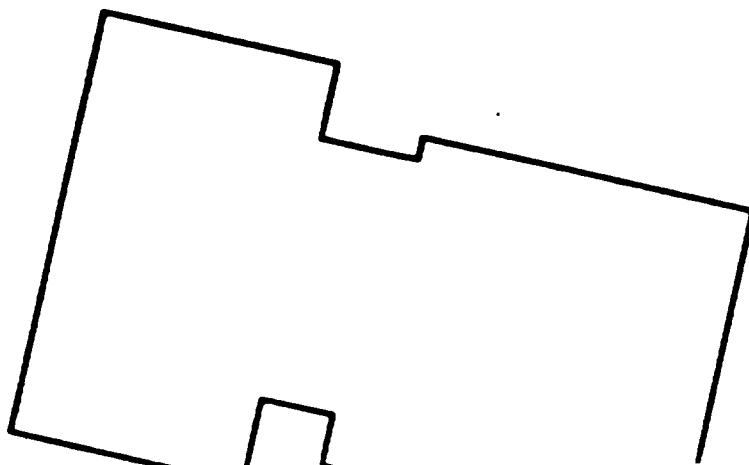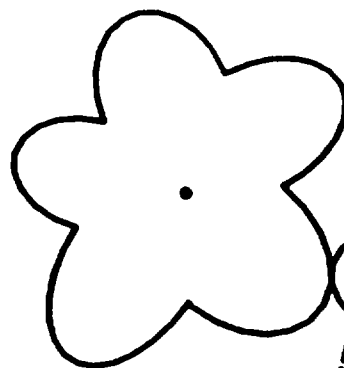

1

2

3

Action Date: 12/29/97

Loadout: 1/2/98

Restoration Begins: 1/2/98

Restoration Completed: 2/9/98

*Stack emission sites were not sampled for verification due to the fact that a pre-determined depth for excavation was given to OHM by USACE.

*An excavation depth of 12 inches was established by USACE prior to work commencing.

*The excavation of special waste yielded a total of 155.64 cubic yards, which was shipped to WMI-Milam for disposal.

*Equipment utilized during excavation:

*TL-26

*TCM

*X331

*17-KW

*Subcontractors:

*WMI-landfill

*B. Garcia-trucking

*Grantham-trucking

*Emerald-turf farm

**OHM CORPORATION
PROJECT 19531
GRANITE CITY, IL**

QUANTITY SUMMARY FOR

1117 Iowa

SPECIAL WASTE (TONS)	BACKFILL (LOADS)	TOPSOIL (TONS)	CA-6 (TONS)	CA-7 (TONS)	SAND (TONS)	SOD CU.YDS.	CONCRETE	OTHER
202.34	14		70.24	30.22		420		

Sampling Analysis
Project #19531

0 - 3" Front and Back

Street/Number Address	A		A	
	PPM	No.	PPM	No.

3 - 6" Front and Back

B	B		B	
	PPM	No.	PPM	No.

6 - 12" Front and Back

C	C		C	
	PPM	No.	PPM	No.

Depth	
Excav.	(inch)


1117 Iowa

412 639

567 740

593 567

12

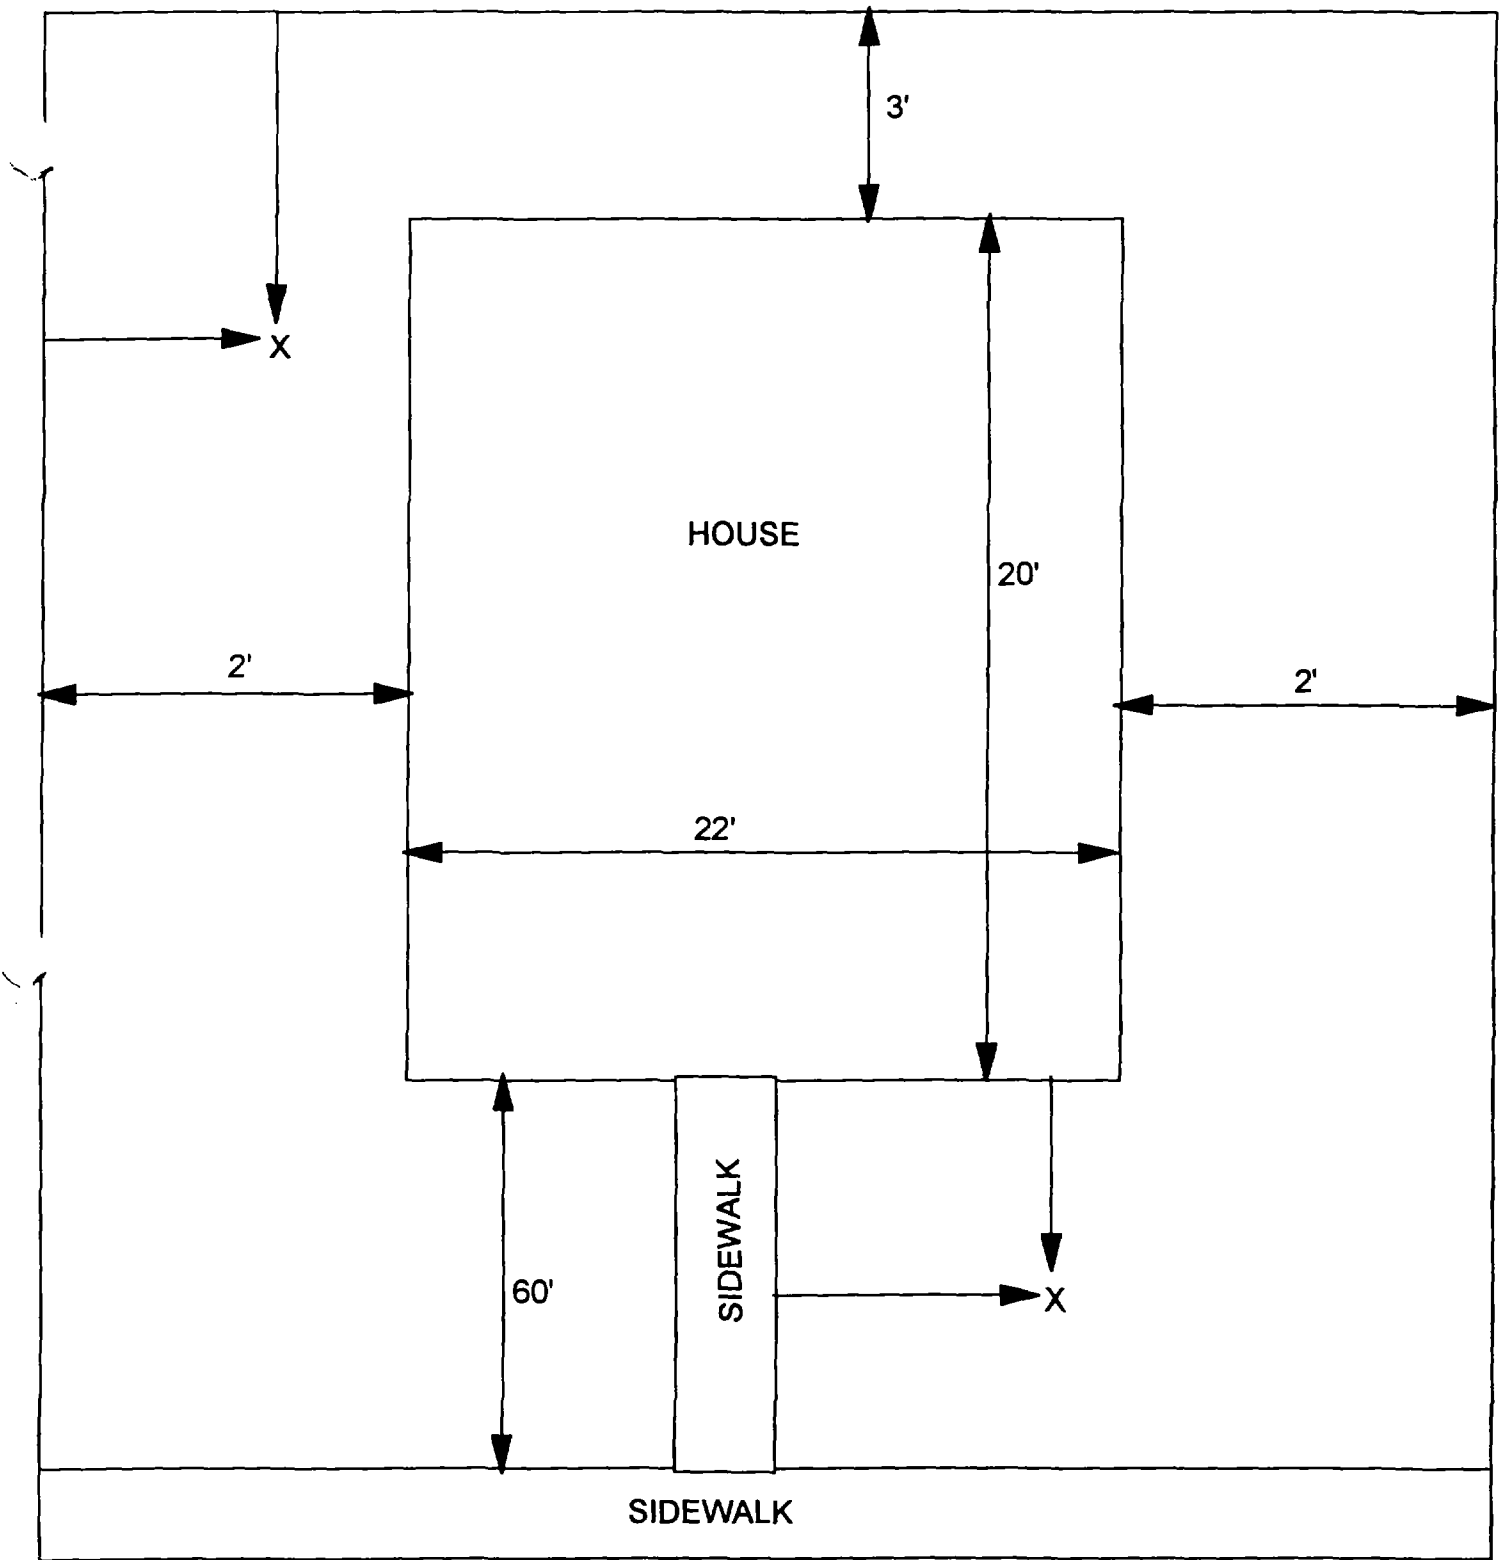

X - SAMPLE POINT

1117 IOWA
26' X 88'

OHM 
Corporation
Findley, Ohio

Drawn By: **EDJ**

Checked By:

Date: **10/14/98**

Approved By:

Scale: **NTS**

Drawing No:

1

2

3

Action Date: 1/15/98

— Loadout: 1/19/98

Restoration Begins: 1/20/98

Restoration Completed: 2/9/98

*Stack emission sites were not sampled for verification due to the fact that a pre-determined depth for excavation was given to OHM by USACE.

*An excavation depth of 12 inches was established by USACE prior to work commencing.

*The excavation of special waste yielded a total of 275.60 cubic yards, which was shipped to WMI-Milam for disposal.

*Equipment utilized during excavation:

*TL-26

*TCM

*X331

*17-KW

*Subcontractors:

*WMI-landfill

*B. Garcia-trucking

*Granthum-trucking

*Emerald Turf Farm

OHM CORPORATION
PROJECT 19531
GRANITE CITY, IL

QUANTITY SUMMARY FOR 1124 Iowa

SPECIAL WASTE (TONS)	BACKFILL (LOADS)	TOPSOIL (TONS)	CA-6 (TONS)	CA-7 (TONS)	SAND (TONS)	SOD CU.YDS.	CONCRETE	OTHER
358.28	30			15.45		780		

**Sampling Analysis
Project #19531**

0 - 3" Front and Back

Street/Number Address	A		A	
	PPM	No.	PPM	No.
1124 Iowa	175	821	222	467


3 - 6" Front and Back

B	B		B	
	PPM	No.	PPM	No.
78	705	950	204	305
			233	

6 - 12" Front and Back

C	C		C	
	PPM	No.	PPM	No.
19	1377	460	175	215
			165	

Depth	
Excav.	(inch)
	12

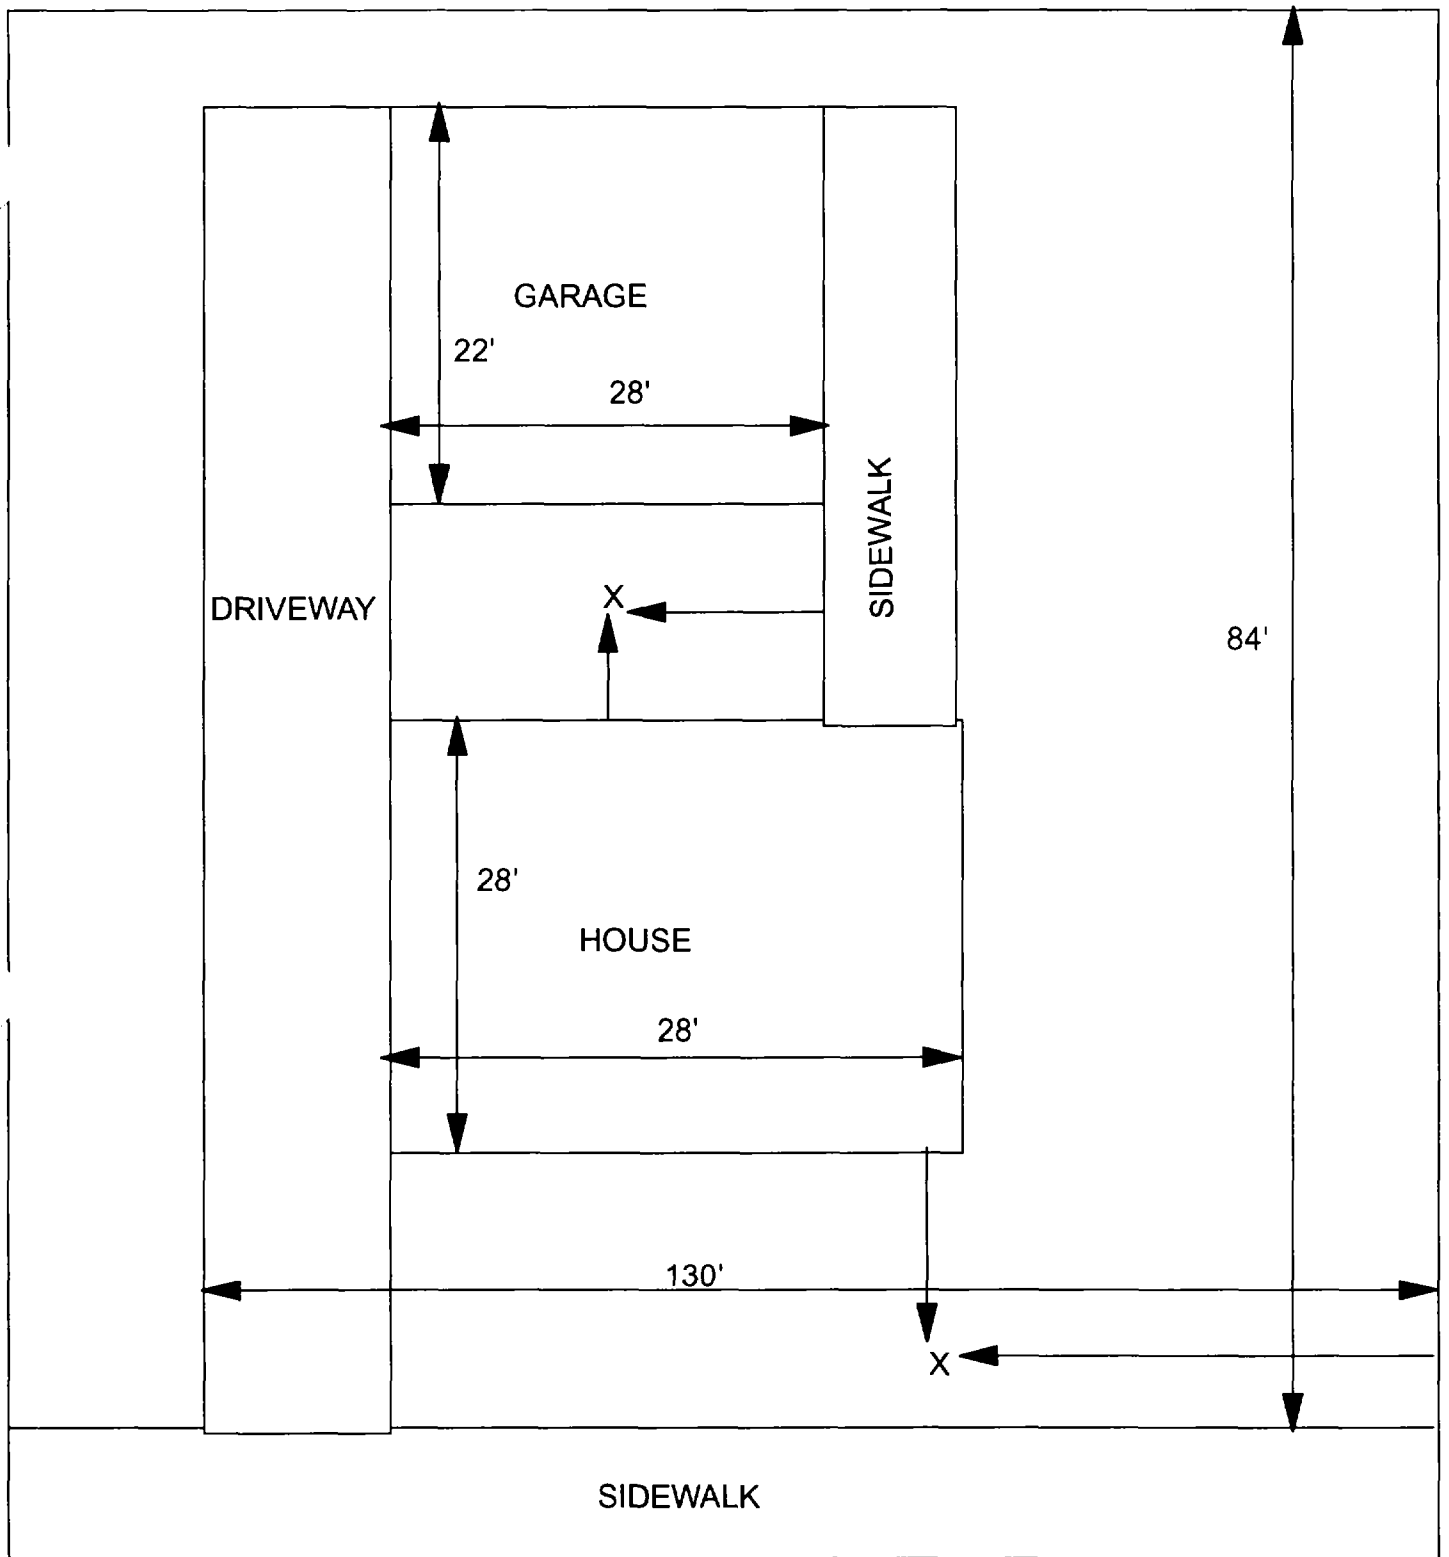

X = SAMPLE POINT

1124 IOWA
84' X 130'


OHM 
Corporation
Findlay, Ohio

Drawn By: EDJ	Checked By:
Date: 7/29/98	Approved By:
Scale: NTS	Drawing No:

2

3

4

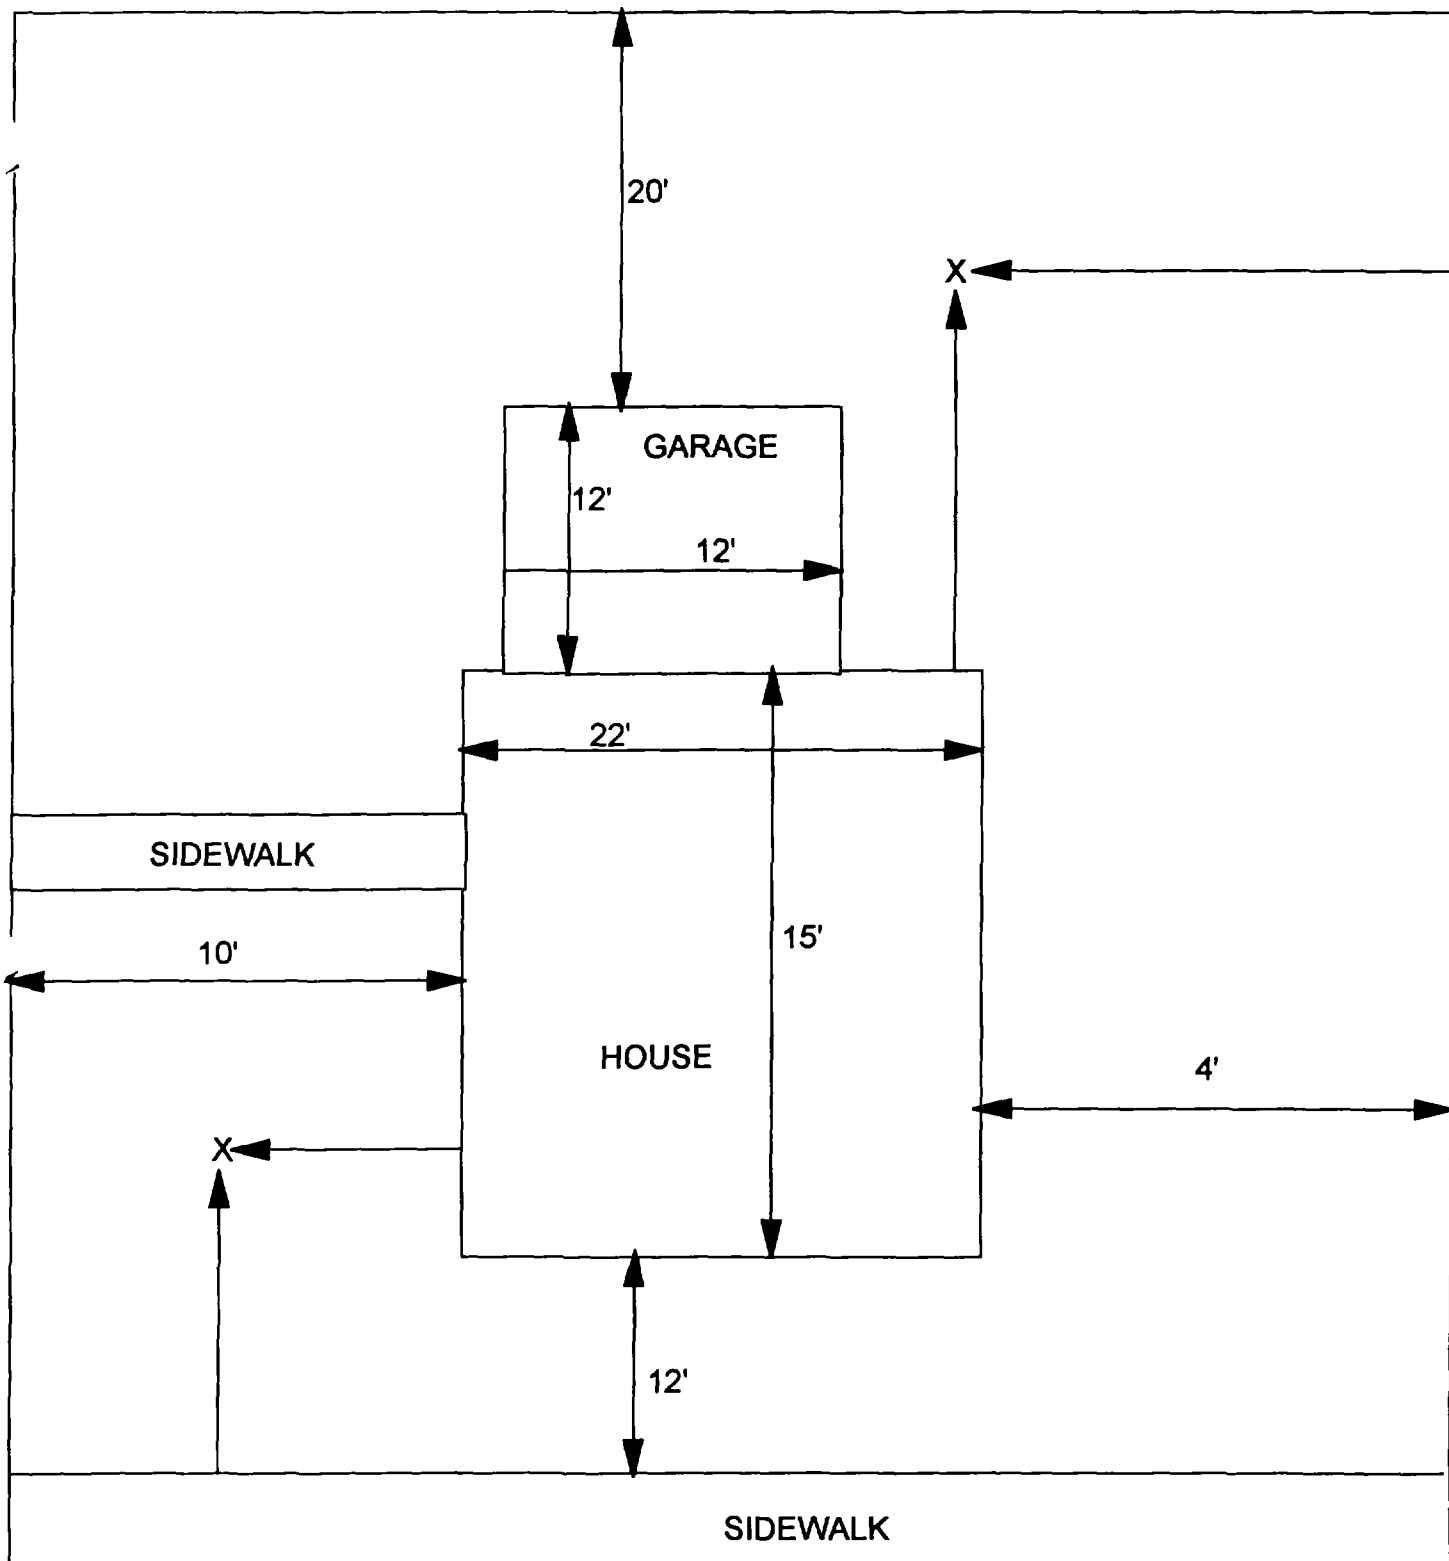

X - SAMPLE POINT

1201 IOWA
36' X 59'

OHM 
Corporation
Findlay, Ohio

Drawn By: EDJ	Checked By:
Date: 10/14/98	Approved By:
Scale: NTS	Drawing No:

Action Date: 9/24/97

Loadout: 9/26/97

Restoration Begins: 9/29/97

Restoration Completed: 10/25/9

*Stack emission sites were not sampled for verification due to the fact that a pre-determined depth for excavation was given to OHM by USACE.

*An excavation depth of 12 inches was established by USACE prior to work commencing.

*The excavation of special waste yielded a total of 62.91 cubic yards, which was shipped to WMI-Milam for disposal.

*Equipment utilized during excavation:

*TL-26	*TCM
*X331	
*17-KW	

*Subcontractors:

- *WMI-landfill
- *B. Garcia-trucking
- *Granthum-trucking
- *Emerald Turf Farm

OHM CORPORATION
PROJECT 19531
GRANITE CITY, IL

QUANTITY SUMMARY FOR 1201 Iowa

SPECIAL WASTE (TONS)	BACKFILL (LOADS)	TOPSOIL (TONS)	CA-6 (TONS)	CA-7 (TONS)	SAND (TONS)	SOD CU.YDS.	CONCRETE	OTHER
81.79	8	61.64	13.45	13.8		540		

**Sampling Analysis
Project #19531**

0 - 3" Front and Back

Street/Number Address	A		A	
	PPM	No.	PPM	No.
1201 Iowa	451	503		

3 - 6" Front and Back

	B		B	
	PPM	No.	PPM	No.
	391	92		

6 - 12" Front and Back

	C		C	
	PPM	No.	PPM	No.
	558	67		
	455	174		

Depth	
Excav.	
(inch)	

12

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Action Date: 3/11/98

Loadout: 3/12/98

Restoration Begins: 3/13/98

Restoration Completed: 3/27/98

*Stack emission sites were not sampled for verification due to the fact that a pre-determined depth for excavation was given to OHM by USACE.

*An excavation depth of 3 inches was established by USACE prior to work commencing.

*The excavation of special waste yielded a total of 41.16 cubic yards, which was shipped to WMI-Milam for disposal.

*Equipment utilized during excavation:

*TL-26

*TCM

*X331

*17-KW

*Subcontractors:

*WMI-landfill

*B. Garcia-trucking

*Grantham-trucking

*Emerald-turf farm

**OHM CORPORATION
PROJECT 19531
GRANITE CITY, IL**

QUANTITY SUMMARY FOR

1205 Iowa

SPECIAL WASTE (TONS)	BACKFILL (LOADS)	TOPSOIL (TONS)	CA-6 (TONS)	CA-7 (TONS)	SAND (TONS)	SOD CU.YDS.	CONCRETE	OTHER
53.51	5		13.9			300		

**Sampling Analysis
Project #19531**

0 - 3" Front and Back

Street/Number Address	A		A	
	PPM	No.	PPM	No.
1205 Iowa	283		215	
	588		395	
	806			


3 - 6" Front and Back

B		B	
PPM	No.	PPM	No.
252		185	
446			

6 - 12" Front and Back

C		C	
PPM	No.	PPM	No.
319		172	
281			

Depth Excav. (inch)
3

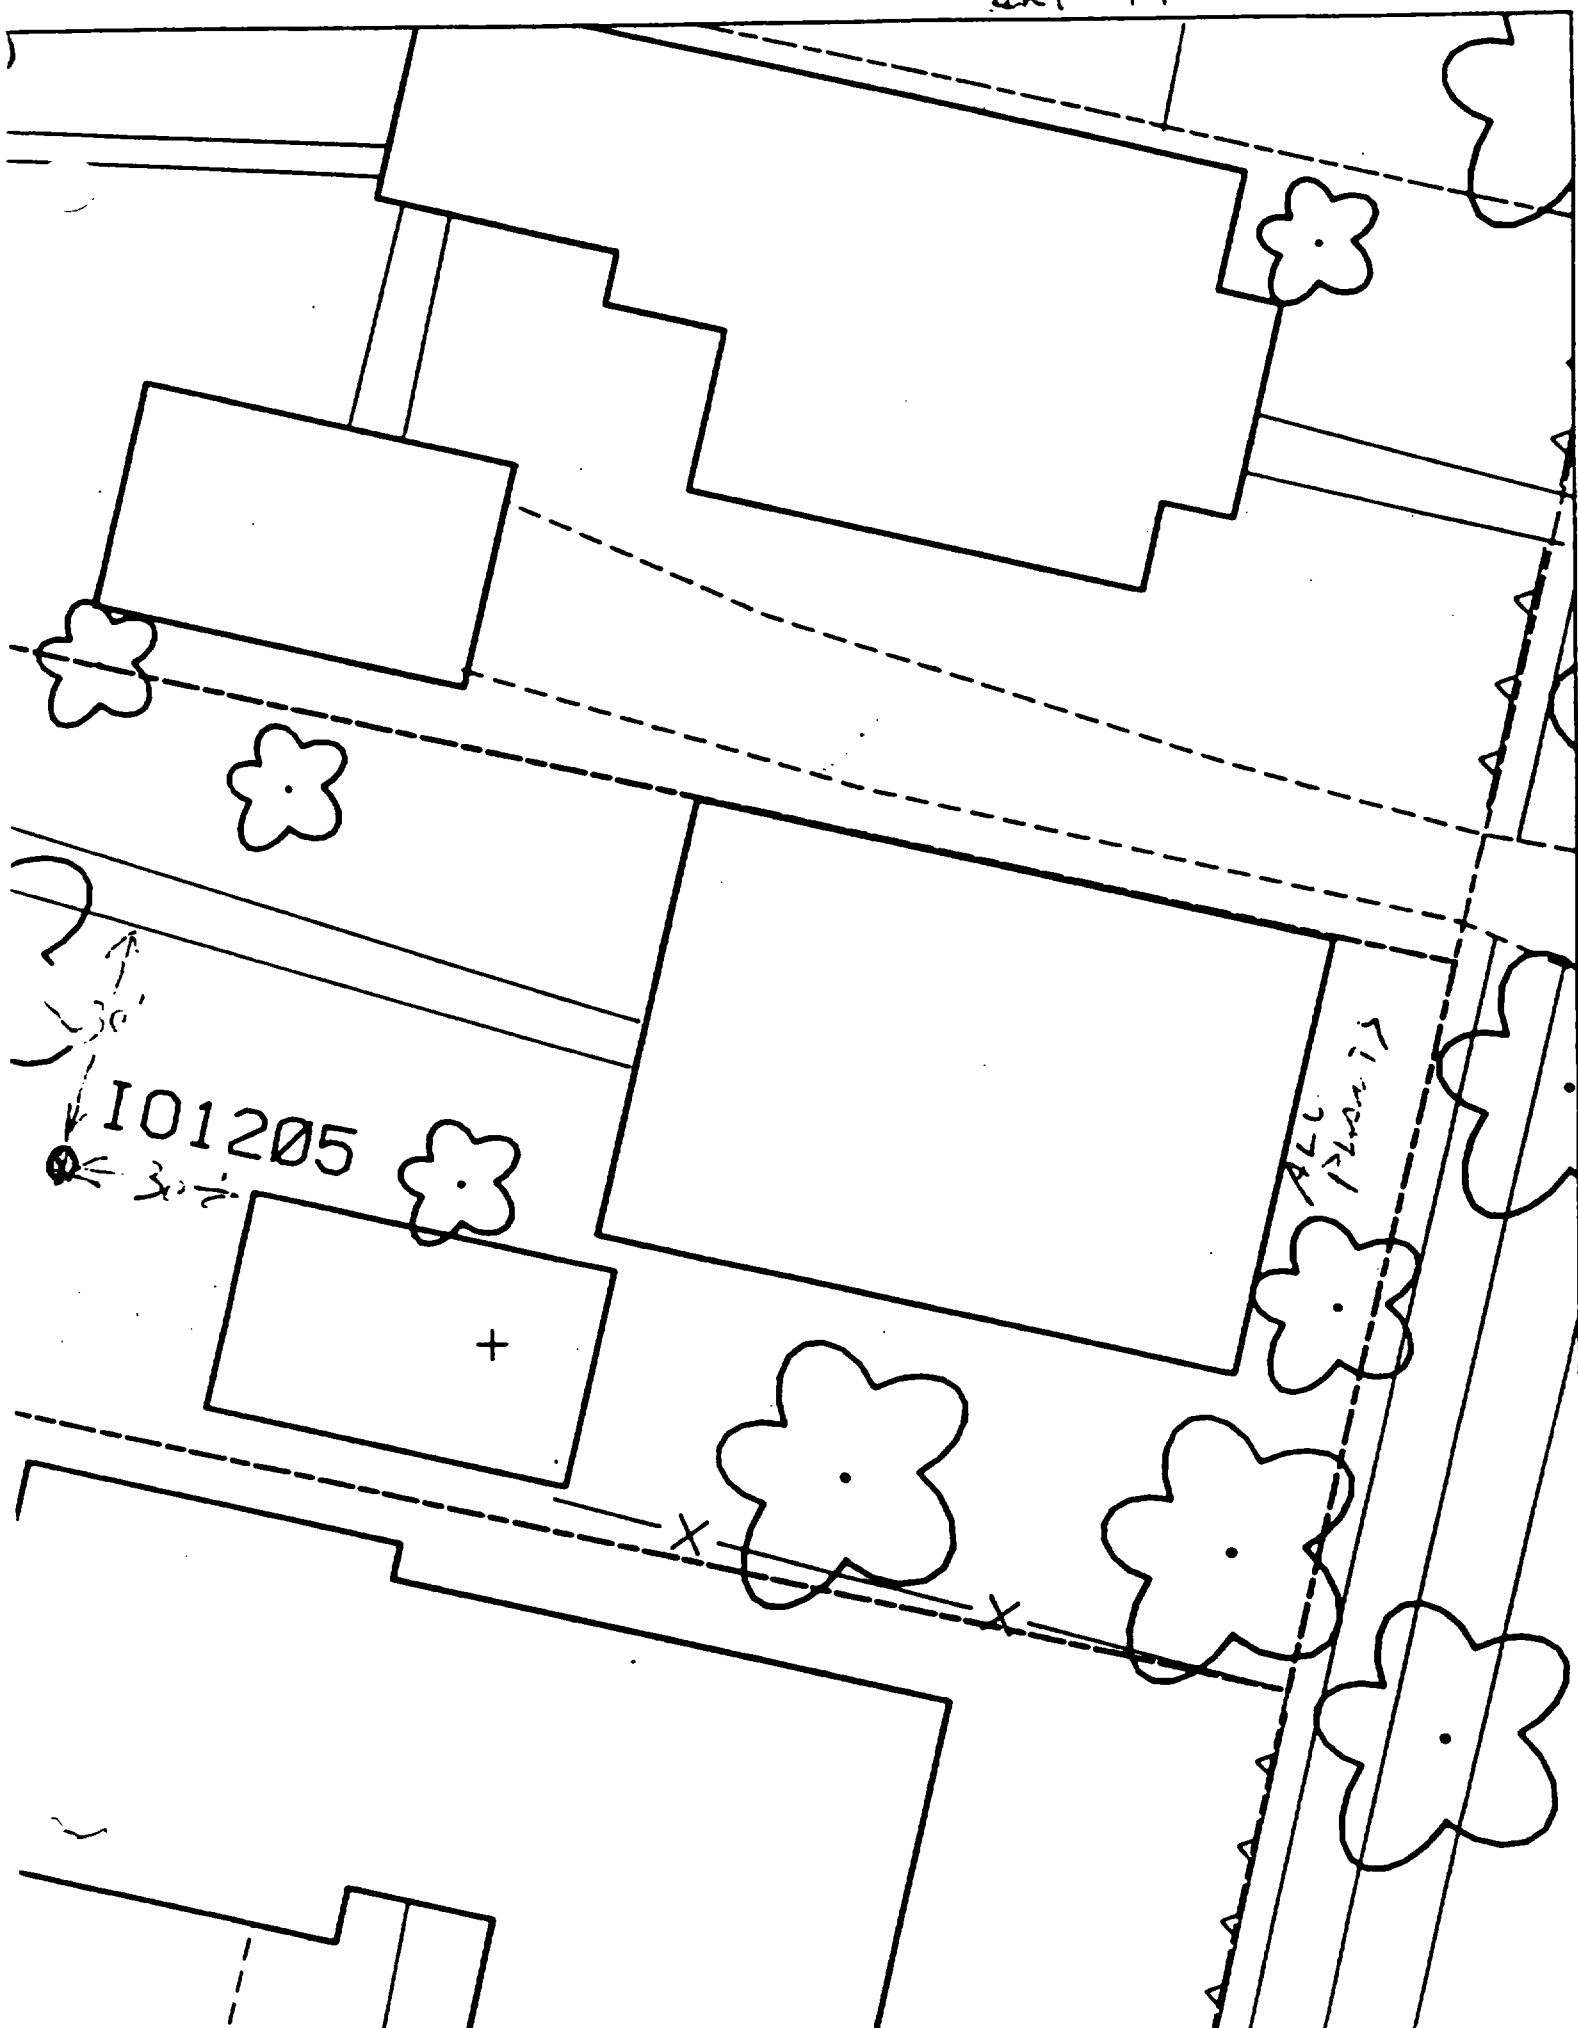

and 11

101205

ALL PLANTS

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1211 Iowa

Action Date: 9/16/97

Loadout: 9/19/97

Restoration Begins: 9/22/97

Restoration Completed: 10/6/97

*Stack emission sites were not sampled for verification due to the fact that a pre-determined depth for excavation was given to OHM by USACE.

*An excavation depth of 6 inches was established by USACE prior to work commencing.

*The excavation of special waste yielded a total of 65.93 cubic yards, which was shipped to WMI-Milam for disposal.

*Equipment utilized during excavation:

*TL-26

*TCM

*X331

*17-KW

*Subcontractors:

*WMI-landfill

*B. Garcia-trucking

*Granthum-trucking

*Schneider Turf Farm

OHM CORPORATION
PROJECT 19531
GRANITE CITY, IL

QUANTITY SUMMARY FOR 1211 Iowa

SPECIAL WASTE (TONS)	BACKFILL (LOADS)	TOPSOIL (TONS)	CA-6 (TONS)	CA-7 (TONS)	SAND (TONS)	SOD CU.YDS.	CONCRETE	OTHER
85.72	4	29.23				480		

**Sampling Analysis
Project #19531**

0 - 3" Front and Back

Street/Number Address	A		A	
	PPM	No.	PPM	No.
1211 Iowa	445		926	


3 - 6" Front and Back

B	B		B	
	PPM	No.	PPM	No.
297	770			
188	356			
389	355			
1351	3766			

6 - 12" Front and Back

C	C		C	
	PPM	No.	PPM	No.
129	356			

Depth	
Excav.	(inch)
	6

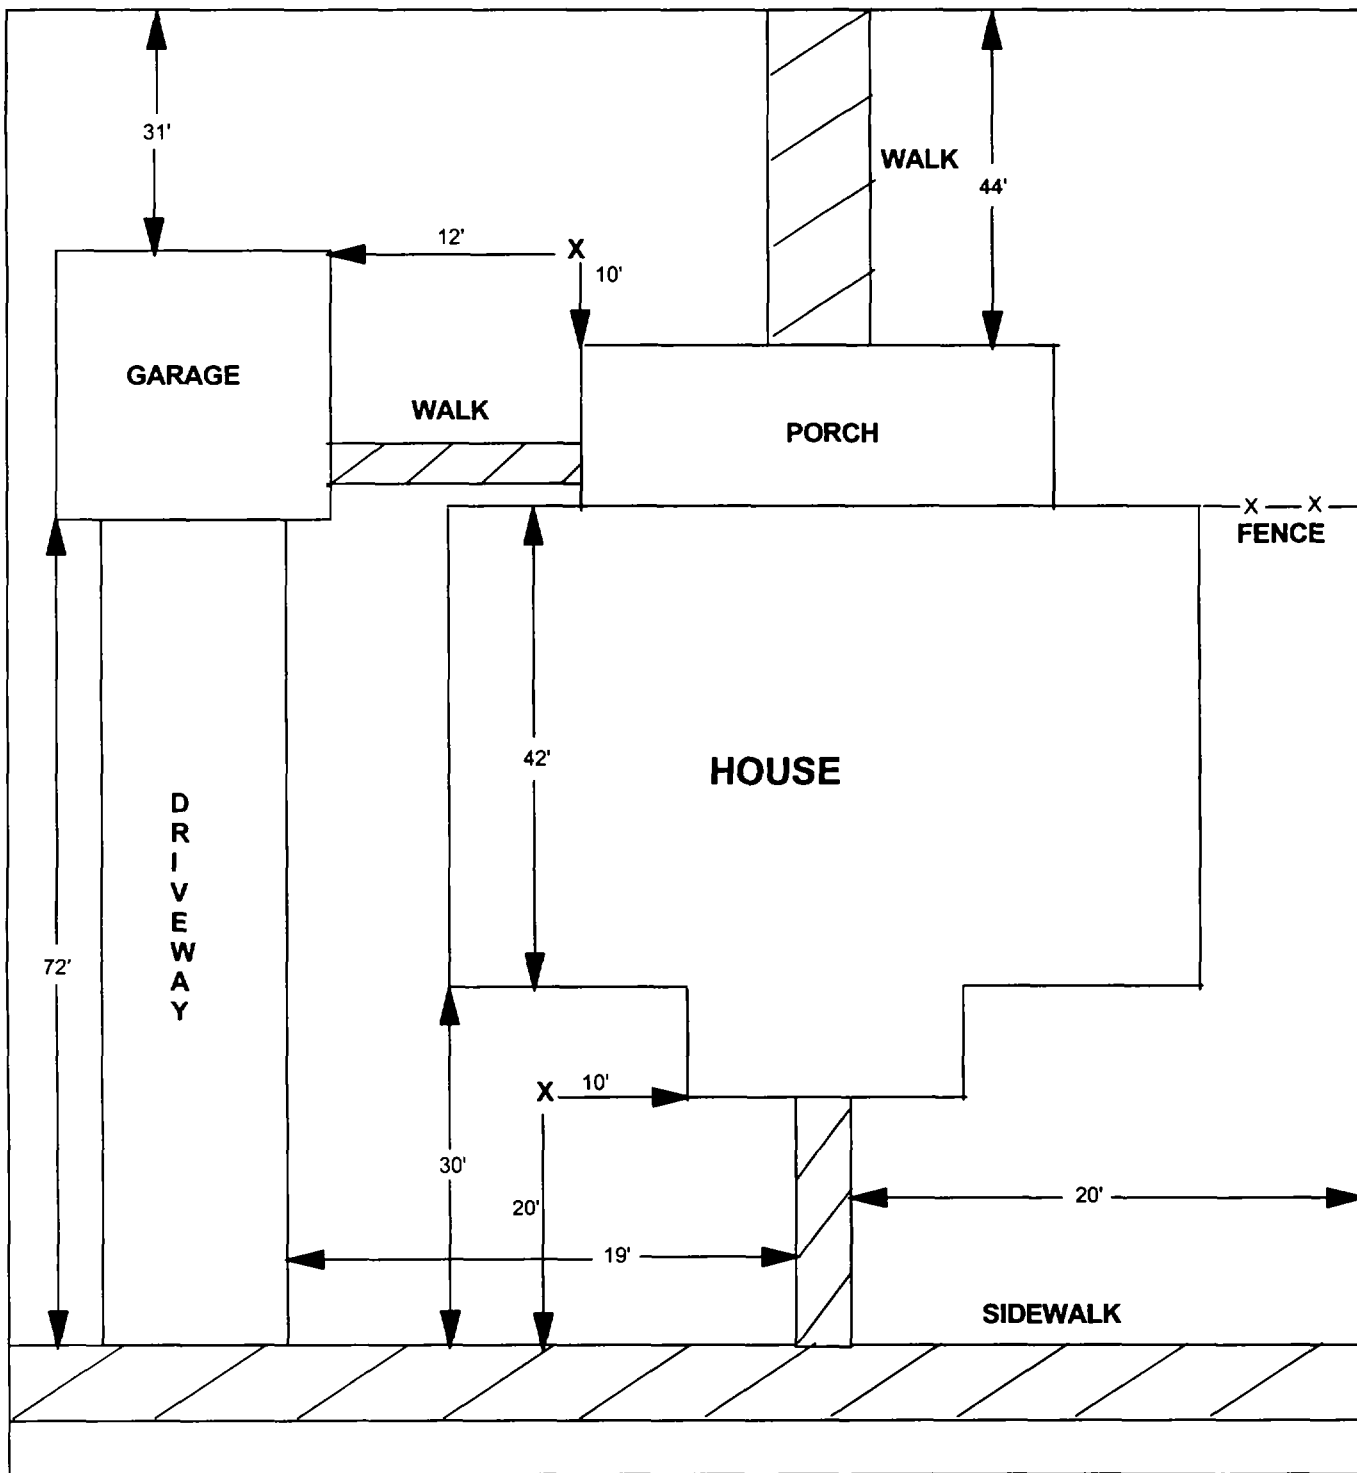

X = SAMPLE POINT

1211 IOWA

**TOTAL
DIMENSIONS
131'X46'**

OHM 
Corporation
Findlay, Ohio

Drawn By: JG	Checked By:
Date: 8/25/98	Approved By:
Scale: NTS	Drawing No:

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Action Date: 9/16/97

Loadout: 9/20/97

Restoration Begins: 9/20/97

Restoration Completed: 10/6/97

*Stack emission sites were not sampled for verification due to the fact that a pre-determined depth for excavation was given to OHM by USACE.

*An excavation depth of 12 inches was established by USACE prior to work commencing.

*The excavation of special waste yielded a total of 95.60 cubic yards, which was shipped to WMI-Milam for disposal.

*Equipment utilized during excavation:

*TL-26

*TCM

*X331

*17-KW

*Subcontractors:

*WMI-landfill

*B. Garcia-trucking

*Granthum-trucking

*Schneider Turf Farm

OHM CORPORATION
PROJECT 19531
GRANITE CITY, IL

QUANTITY SUMMARY FOR 1213 Iowa

SPECIAL WASTE (TONS)	BACKFILL (LOADS)	TOPSOIL (TONS)	CA-6 (TONS)	CA-7 (TONS)	SAND (TONS)	SOD CU.YDS.	CONCRETE	OTHER
124.29	6	29.04	44.85	15.3		300		

**Sampling Analysis
Project #19531**

0 - 3" Front and Back

Street/Number Address	A		A	
	PPM	No.	PPM	No.
1213 Iowa	500	360		
	527	33		

3 - 6" Front and Back

B	B		B	
	PPM	No.	PPM	No.
333		248		
226		20		



6 - 12" Front and Back

C	C		C	
	PPM	No.	PPM	No.
287		513		
101		642		


Depth Excav. (inch)
12

101213⁺

x

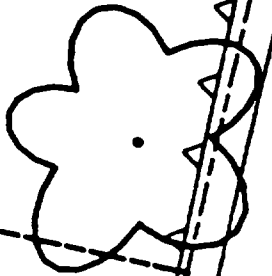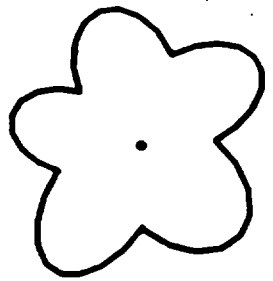

01205

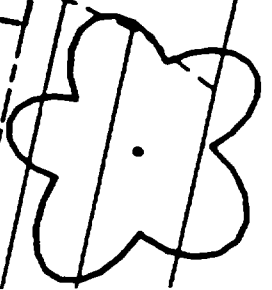

1

2

3

Action Date: 12/2/97

Loadout: 12/6/97

Restoration Begins: 12/6/97

Restoration Completed: 12/20/97

*Stack emission sites were not sampled for verification due to the fact that a pre-determined depth for excavation was given to OHM by USACE.

*An excavation depth of 12 inches was established by USACE prior to work commencing.

*The excavation of special waste yielded a total of 102.88 cubic yards, which was shipped to WMI-Milam for disposal.

*Equipment utilized during excavation:

*TL-26

*TCM

*X331

*17-KW

*Subcontractors:

*WMI-landfill

*B. Garcia-trucking

*Grantham-trucking

*Emerald-turf farm

**OHM CORPORATION
PROJECT 19531
GRANITE CITY, IL**

QUANTITY SUMMARY FOR

1227 Iowa

SPECIAL WASTE (TONS)	BACKFILL (LOADS)	TOPSOIL (TONS)	CA-6 (TONS)	CA-7 (TONS)	SAND (TONS)	SOD CU.YDS.	CONCRETE	OTHER
133.75	12					506		

Sampling Analysis
 Project #19531


0 - 3" Front and Back			
A		A	
Street/Number	PPM	PPM	PPM
Address	No.	No.	No.

3 - 6" Front and Back			
B		B	
PPM	PPM	PPM	PPM
No.	No.	No.	No.

6 - 12" Front and Back			
C		C	
PPM	PPM	PPM	PPM
No.	No.	No.	No.

Depth
Excav.
(inch)

1227 Iowa	594	514	539	426	375	543	12
					364	533	

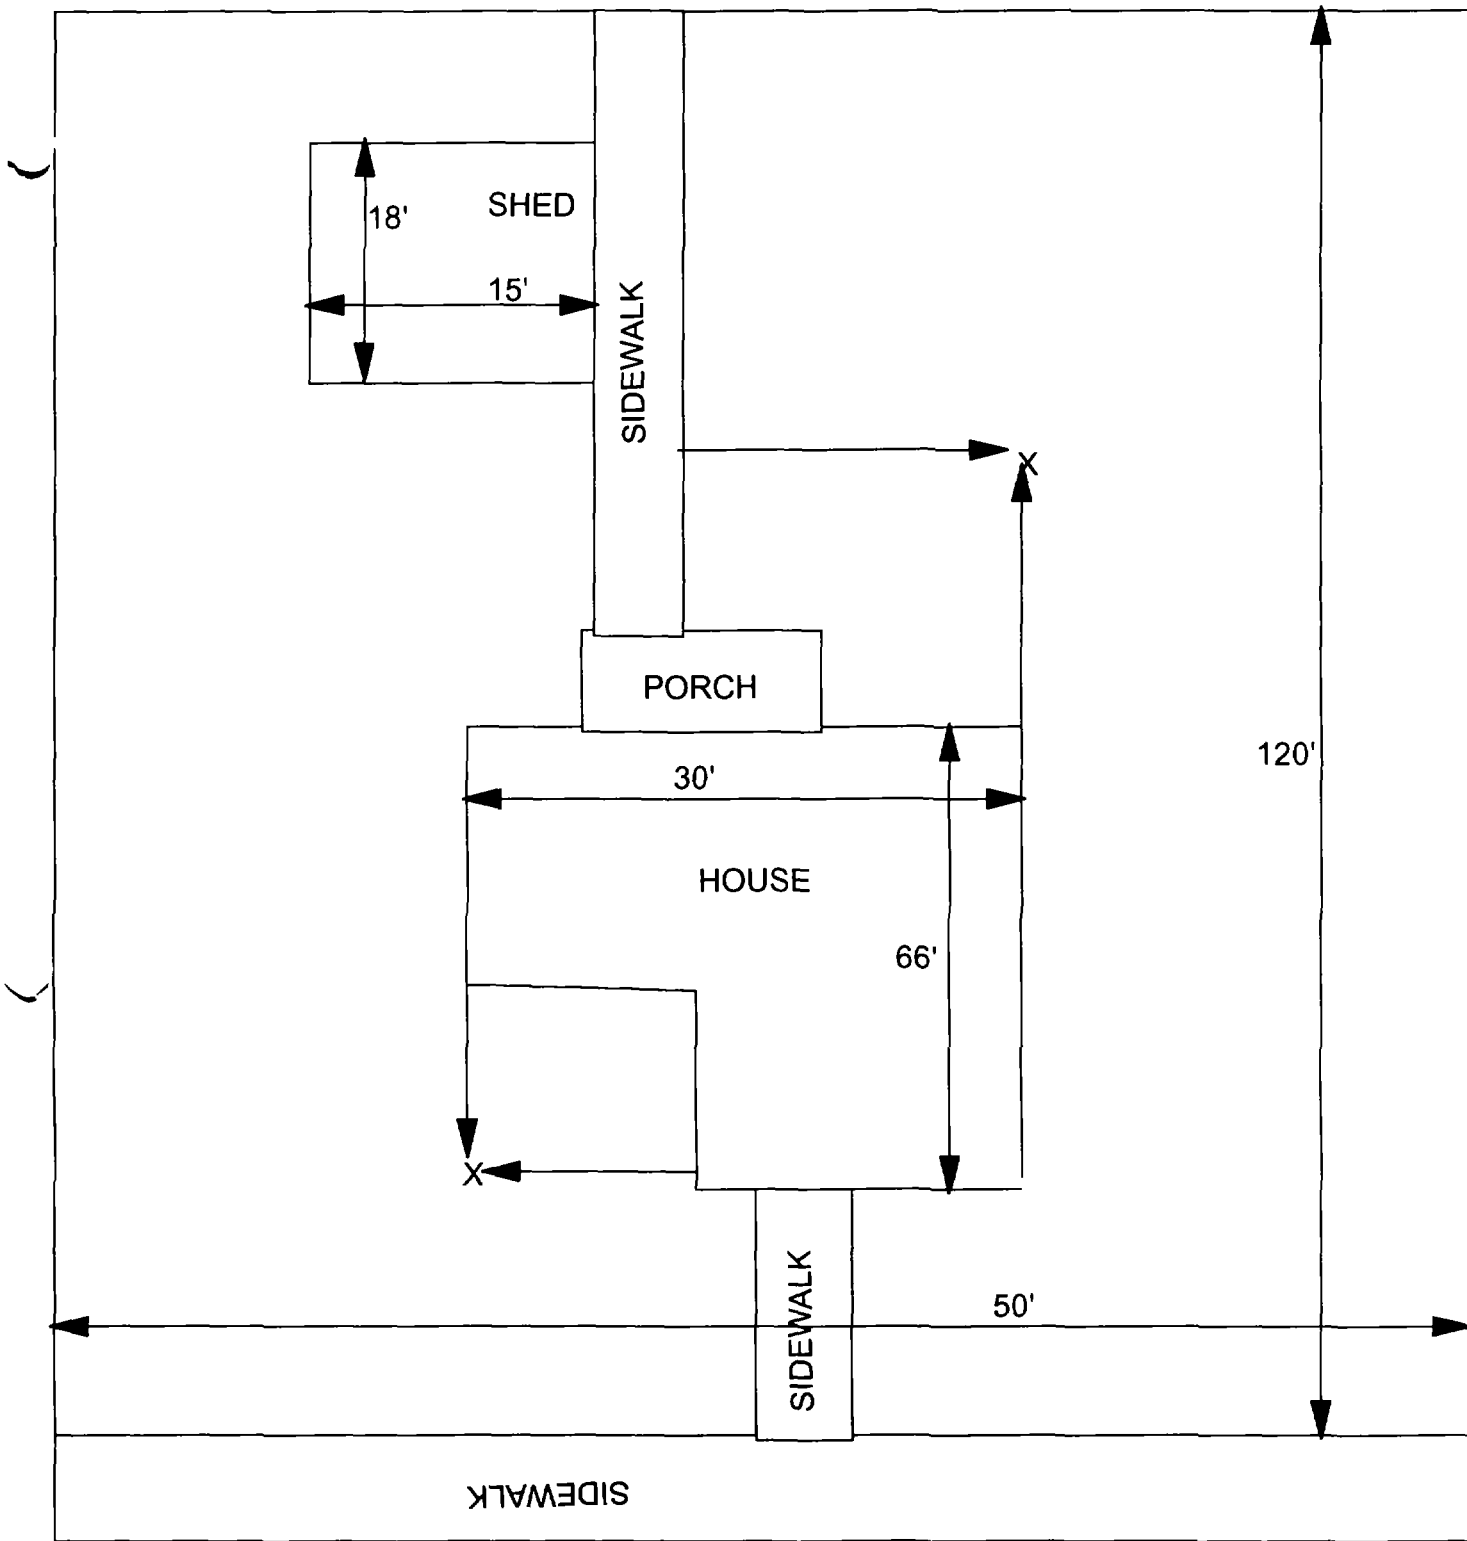

X = SAMPLE POINT

1227 IOWA
50' X 120'

OHM Corporation
Findlay, Ohio

Drawn By: **EDJ**

Checked By:

Date: **7/29/98**

Approved By:

Scale: **NTS**

Drawing No:

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Action Date: 7/22/97

Loadout: 7/25/97

Restoration Begins: 7/25/97

Restoration Completed: 8/1/97

*Stack emission sites were not sampled for verification due to the fact that a pre-determined depth for excavation was given to OHM by USACE.

*An excavation depth of 3 inches was established by USACE prior to work commencing.

*The excavation of special waste yielded a total of 97.33 cubic yards, which was shipped to WMI-Milam for disposal.

*Equipment utilized during excavation:

*TL-26

*TCM

*X331

*17-KW

*Subcontractors:

*WMI-landfill

*B. Garcia-trucking

*Granthum-trucking

*Schneider Turf Farm

OHM CORPORATION
PROJECT 19531
GRANITE CITY, IL

QUANTITY SUMMARY FOR 1230 Iowa

SPECIAL WASTE (TONS)	BACKFILL (LOADS)	TOPSOIL (TONS)	CA-6 (TONS)	CA-7 (TONS)	SAND (TONS)	SOD CU.YDS.	CONCRETE	OTHER
126.54	3	86.94	14.5	13.55		667		

**Sampling Analysis
Project #19531**


0 - 3" Front and Back			
Street/Number Address	A		A
	PPM	No.	PPM
1230 Iowa	741	232	
	655	490	

3 - 6" Front and Back			
B	B		B
	PPM	No.	PPM
442		136	

6 - 12" Front and Back			
C	C		C
	PPM	No.	PPM
110		333	

Depth	
Excav.	
(inch)	

3

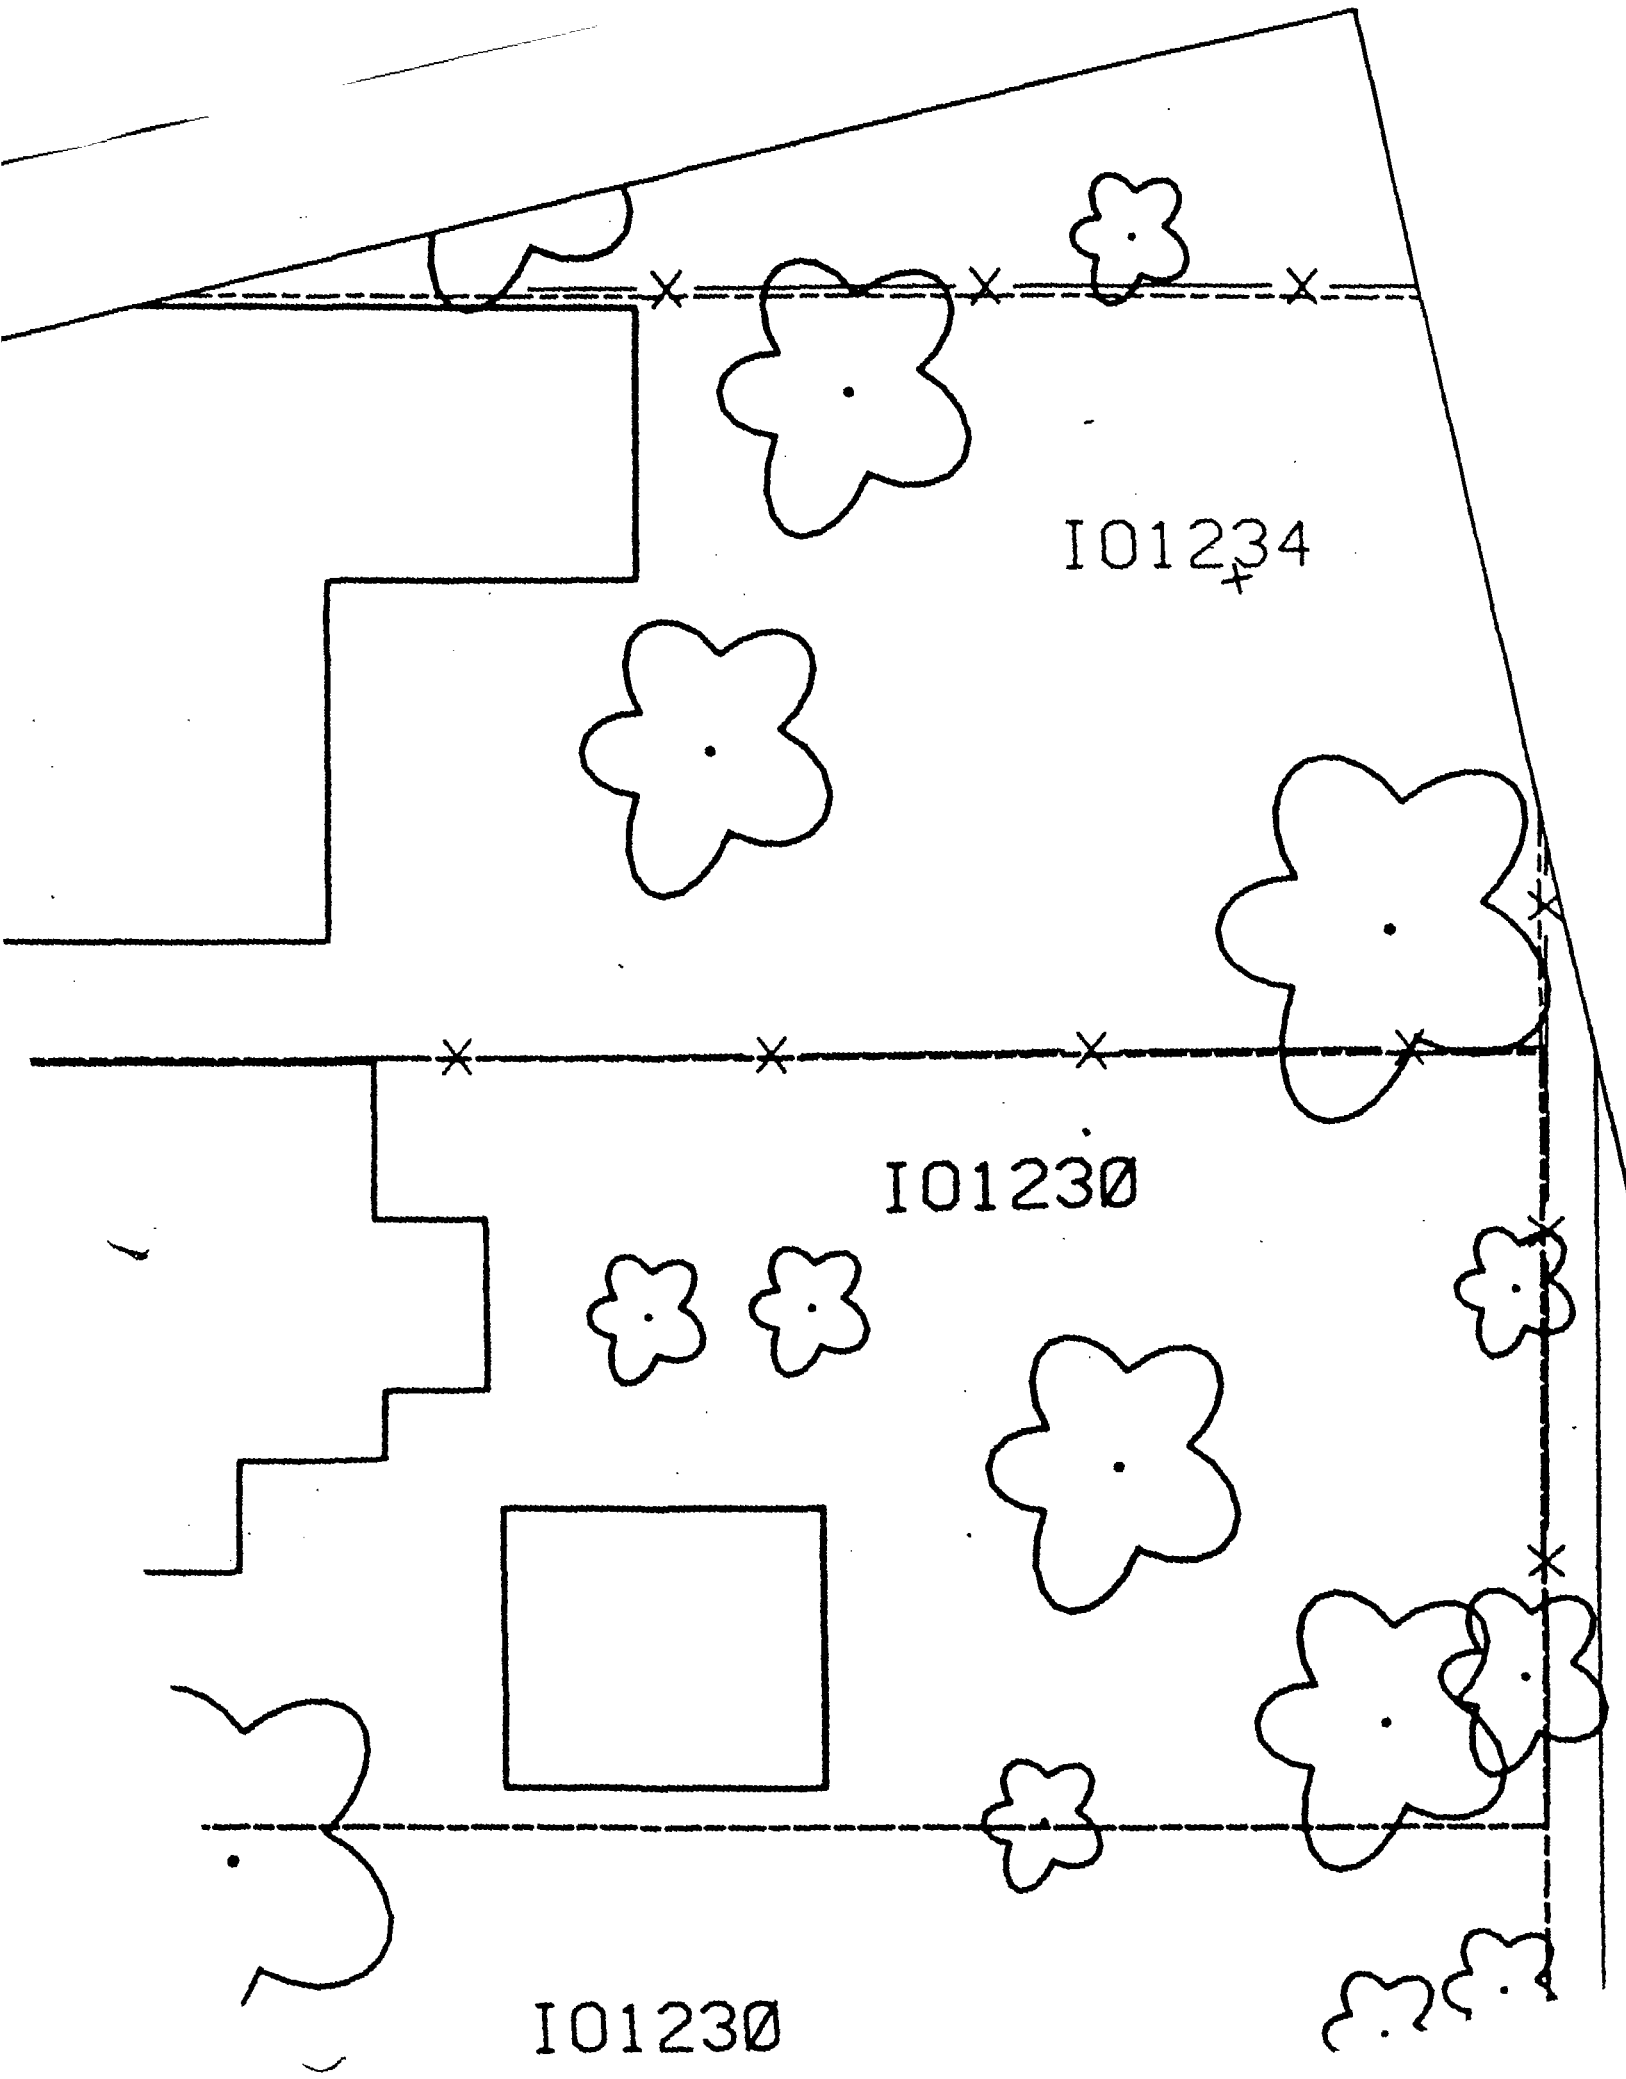

1

2

3

Action Date: 7/29/97

Loadout: 7/30/97

Restoration Begins: 7/30/97

Restoration Completed: 8/29/97

*Stack emission sites were not sampled for verification due to the fact that a pre-determined depth for excavation was given to OHM by USACE.

*An excavation depth of 12 inches was established by USACE prior to work commencing.

*The excavation of special waste yielded a total of 62.46 cubic yards, which was shipped to WMI-Milam for disposal.

*Equipment utilized during excavation:

*TL-26

*TCM

*X331

*17-KW

*Subcontractors:

*WMI-landfill

*B. Garcia-trucking

*Granthum-trucking

*Emerald Turf Farm

OHM CORPORATION
PROJECT 19531
GRANITE CITY, IL

QUANTITY SUMMARY FOR

1231 Iowa

SPECIAL WASTE (TONS)	BACKFILL (LOADS)	TOPSOIL (TONS)	CA-6 (TONS)	CA-7 (TONS)	SAND (TONS)	SOD CU.YDS.	CONCRETE	OTHER
81.21	2	31.12	29.9	15.3		120		

**Sampling Analysis
Project #19531**

0 - 3" Front and Back

Street/Number	A	A	A
Address	PPM	PPM	PPM
	No.	No.	No.

1231 Iowa

615

284

3 - 6" Front and Back

B	B	B
PPM	PPM	PPM
No.	No.	No.

538

414

6 - 12" Front and Back


C	C	C
PPM	PPM	PPM
No.	No.	No.

444

572

Depth
Excav.
(inch)

12

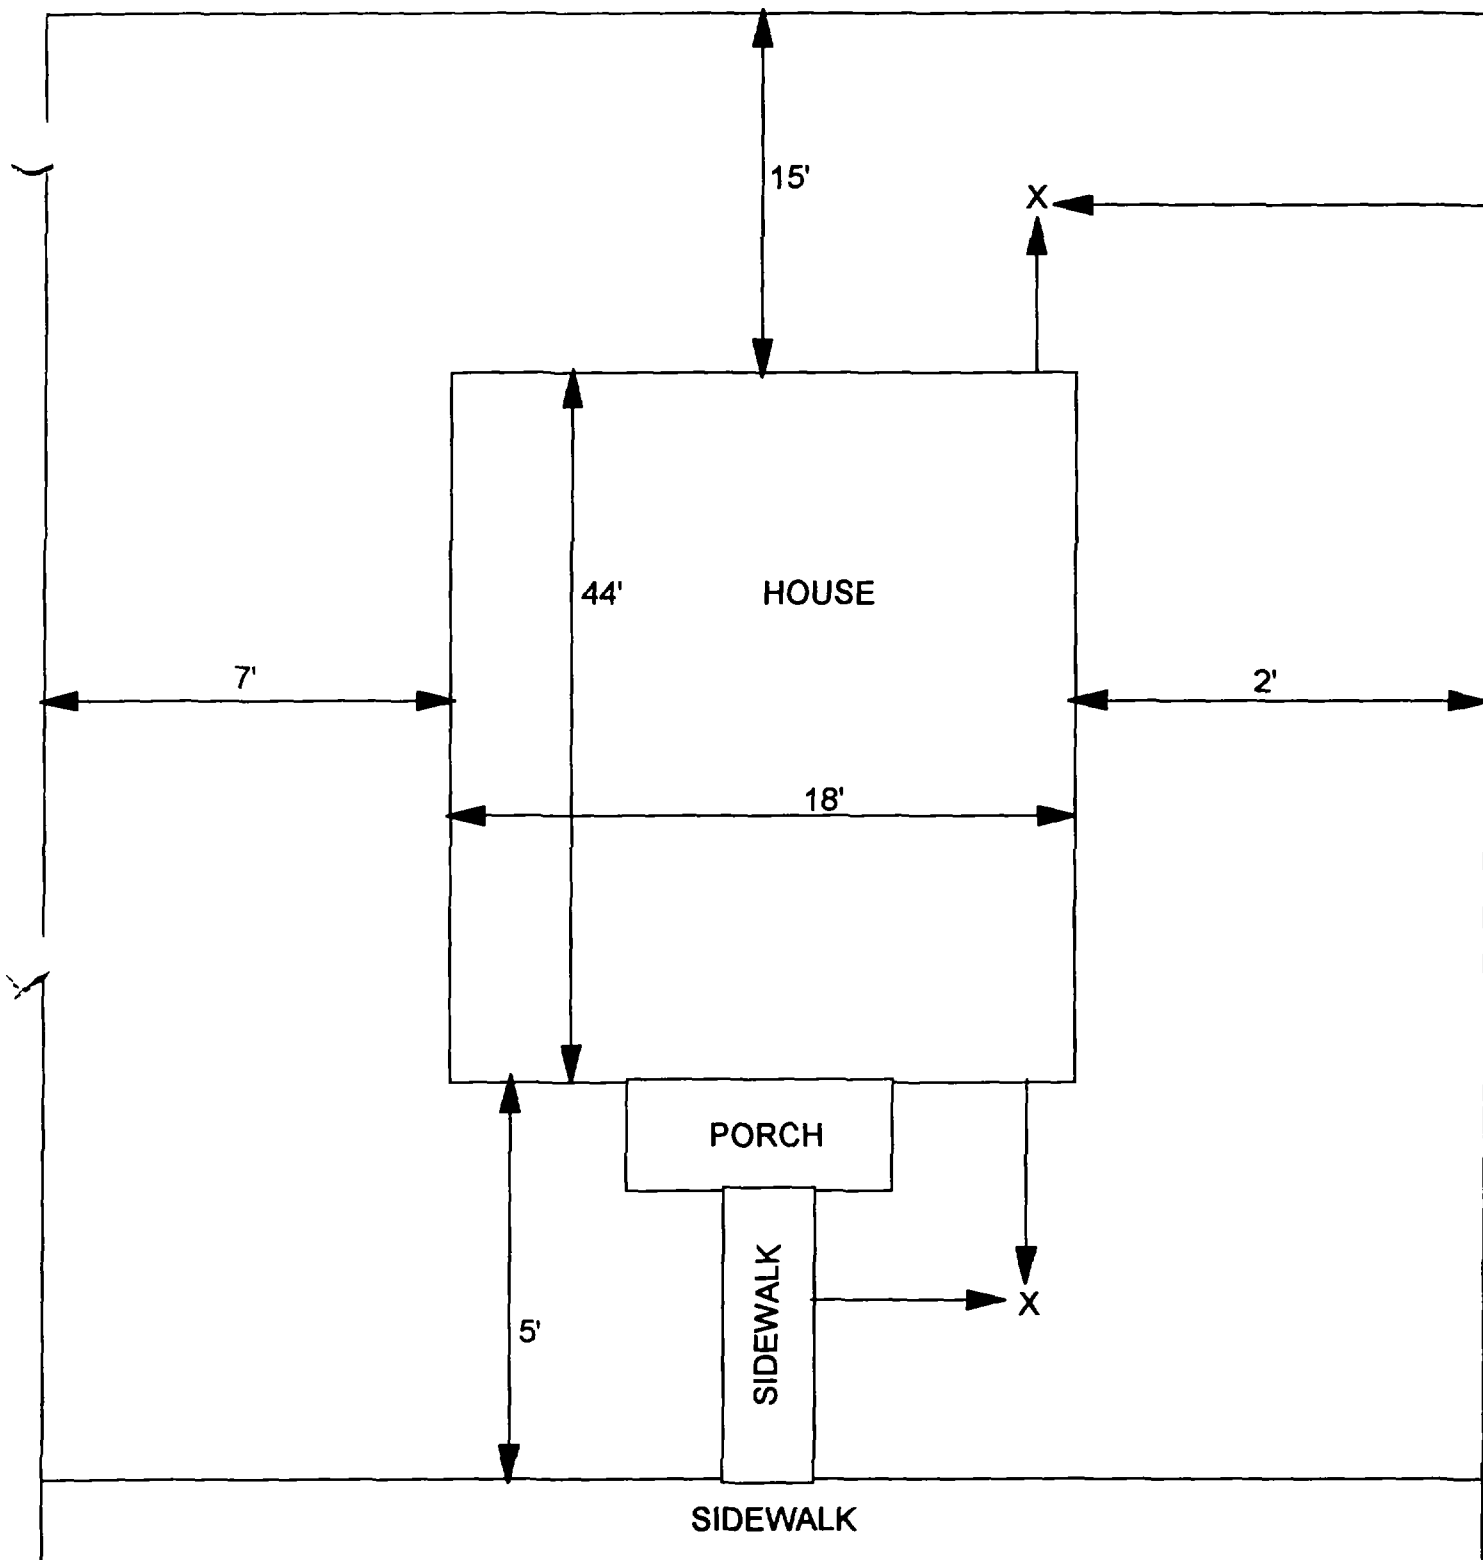

X - SAMPLE POINT

1231 IOWA
27' X 64'

OHM
Corporation
Findley, Ohio

Drawn By: EDJ	Checked By:
Date: 10/14/98	Approved By:
Scale: NTS	Drawing No:

1

2

3

1245 Iowa

Action Date: 12/9/97

— Loadout: 12/12/97

Restoration Begins: 12/12/97

Restoration Completed: 12/20/97

*Stack emission sites were not sampled for verification due to the fact that a pre-determined depth for excavation was given to OHM by USACE.

*An excavation depth of 12 inches was established by USACE prior to work commencing.

*The excavation of special waste yielded a total of 113.52 cubic yards, which was shipped to WMI-Milam for disposal.

*Equipment utilized during excavation:

*TL-26

*TCM

*X331

*17-KW

*Subcontractors:

*WMI-landfill

*B. Garcia-trucking

*Grantham-trucking

*Emerald-turf farm

OHM CORPORATION
PROJECT 1953I
GRANITE CITY, IL

QUANTITY SUMMARY FOR

1245 Iowa

SPECIAL WASTE (TONS)	BACKFILL (LOADS)	TOPSOIL (TONS)	CA-6 (TONS)	CA-7 (TONS)	SAND (TONS)	SOD CU.YDS.	CONCRETE	OTHER
147.58	9	52.47		14.75		480		

**Sampling Analysis
Project #19531**

0 - 3" Front and Back

Street/Number Address	A		A	
	PPM	No.	PPM	No.
1245 Iowa	4320	854		


3 - 6" Front and Back

	B		B	
	PPM	No.	PPM	No.
	195	594		
	710	180		

6 - 12" Front and Back

	C		C	
	PPM	No.	PPM	No.
	70	971		
	1179	796		

Depth
Excav. (inch)
12

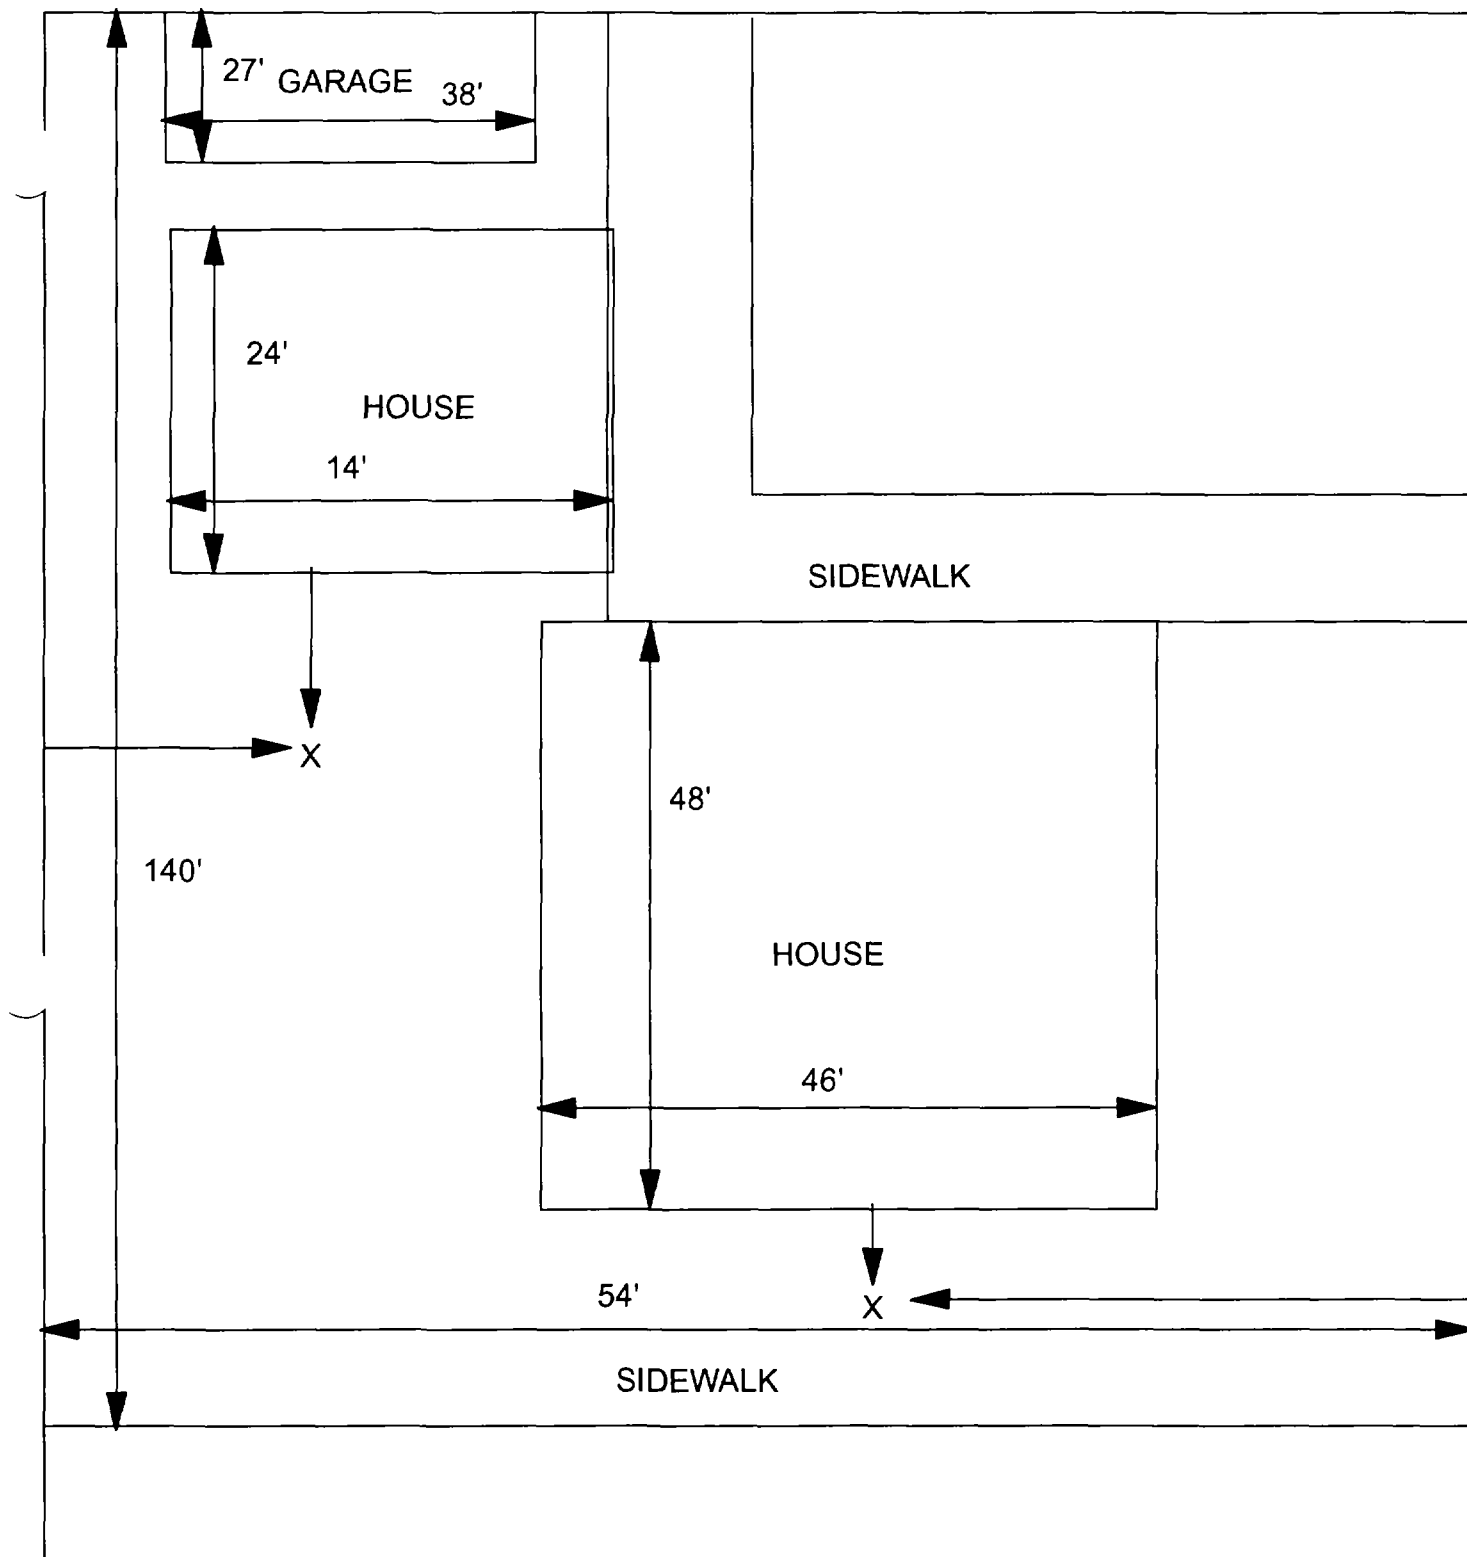

X = SAMPLE POINT

1245 IOWA
54' X 140'

OHM Corporation
Findlay, Ohio

Drawn By: EDJ	Checked By:
Date: 7/29/98	Approved By:
Scale: NTS	Drawing No:

1

2

3

1301 Iowa

Action Date: 8/8/97

Loadout: 8/13/97

Restoration Begins: 8/13/97

Restoration Completed: 9/3/97

*Stack emission sites were not sampled for verification due to the fact that a pre-determined depth for excavation was given to OHM by USACE.

*An excavation depth of 12 inches was established by USACE prior to work commencing.

*The excavation of special waste yielded a total of 130.01 cubic yards, which was shipped to WMI-Milam for disposal.

*Equipment utilized during excavation:

*TL-26

*TCM

*X331

*17-KW

*Subcontractors:

*WMI-landfill

*B. Garcia-trucking

*Granthum-trucking

*Emerald Turf Farm

OHM CORPORATION
PROJECT 19531
GRANITE CITY, IL

QUANTITY SUMMARY FOR 1301 Iowa

SPECIAL WASTE (TONS)	BACKFILL (LOADS)	TOPSOIL (TONS)	CA-6 (TONS)	CA-7 (TONS)	SAND (TONS)	SOD CU.YDS.	CONCRETE	OTHER
169.02	10	73.16				600		

**Sampling Analysis
Project #19531**

0 - 3" Front and Back

Street/Number Address	A		A	
	PPM	No.	PPM	No.
1301 Iowa	448	542		

3 - 6" Front and Back

B	B		B	
	PPM	No.	PPM	No.
	545	411		

6 - 12" Front and Back

C	C		C	
	PPM	No.	PPM	No.
	395	1451		
	89	108		
	506	354		

Depth Excav. (inch)
12

I01307

I01301



Action Date: 7/17/97

Loadout: 7/19/97

Restoration Begins: 7/21/97

Restoration Completed: 8/4/97

*Stack emission sites were not sampled for verification due to the fact that a pre-determined depth for excavation was given to OHM by USACE.

*An excavation depth of 12 inches was established by USACE prior to work commencing.

*The excavation of special waste yielded a total of 30.41 cubic yards, which was shipped to WMI-Milam for disposal.

*Equipment utilized during excavation:

*TL-26

*TCM

*X331

*17-KW

*Subcontractors:

*WMI-landfill

*B. Garcia-trucking

*Granthum-trucking

*Schneider Turf Farm

OHM CORPORATION
PROJECT 19531
GRANITE CITY, IL

QUANTITY SUMMARY FOR 1304 Iowa

SPECIAL WASTE (TONS)	BACKFILL (LOADS)	TOPSOIL (TONS)	CA-6 (TONS)	CA-7 (TONS)	SAND (TONS)	SOD CU.YDS.	CONCRETE	OTHER
39.54		15.71	29.5	14.8		32		

Sampling Analysis
Project #19531

0 - 3" Front and Back

Street/Number Address	A		A	
	PPM	No.	PPM	No.
1304 Iowa	795	171	236	
	850	463		


3 - 6" Front and Back

B	B		B	
	PPM	No.	PPM	No.
642	120	122		
	366	470		

6 - 12" Front and Back

C	C		C	
	PPM	No.	PPM	No.
254	843	994		
	242	590		

Depth Excav. (inch)
12

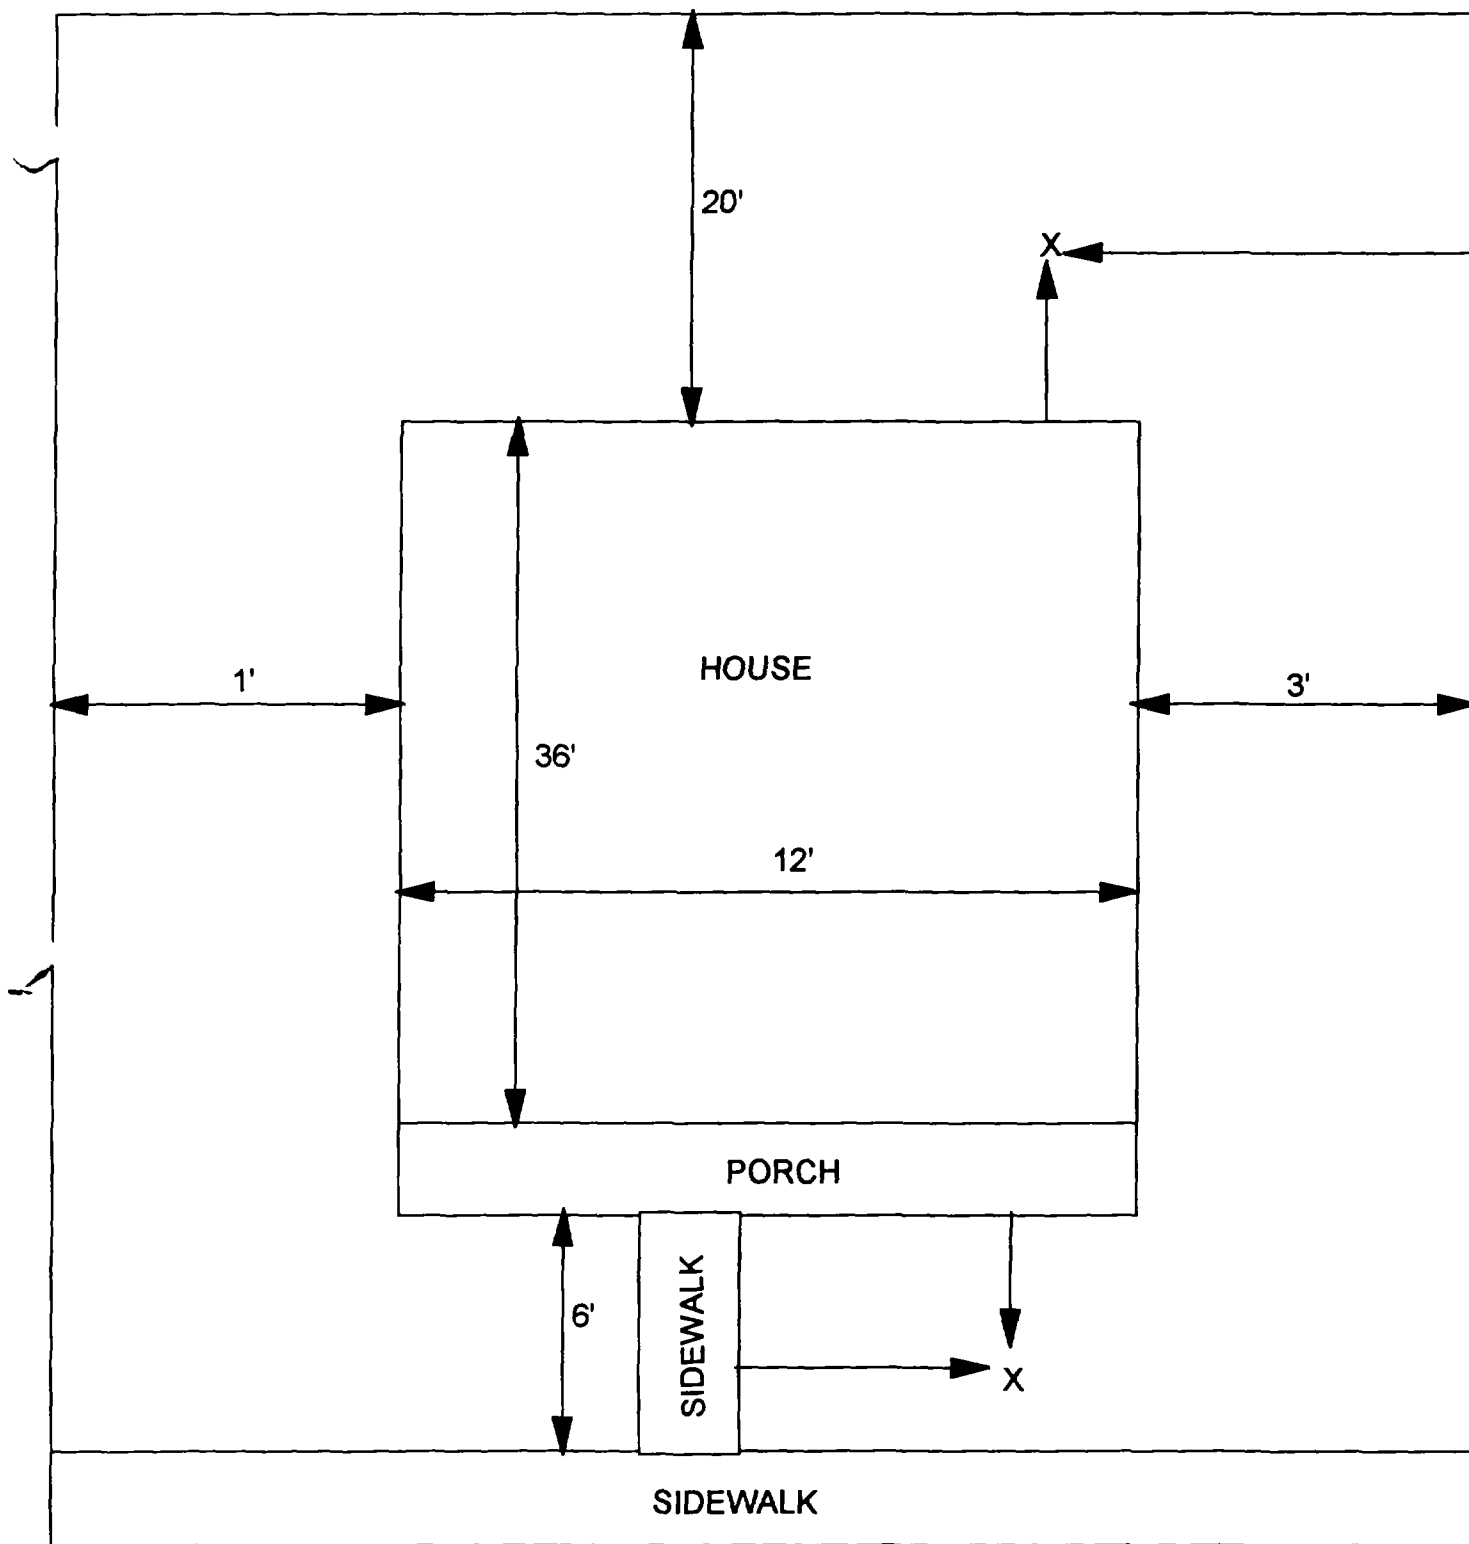

X - SAMPLE POINT

1304 IOWA
16' X 62'

OHM 
Corporation
Findlay, Ohio

Drawn By: **EDJ**

Checked By:

Date: **10/14/98**

Approved By:

Scale: **NTS**

Drawing No:

✓

✓

✓

Action Date: 8/8/97

Loadout: 8/13/97

Restoration Begins: 8/13/97

Restoration Completed: 9/3/97

*Stack emission sites were not sampled for verification due to the fact that a pre-determined depth for excavation was given to OHM by USACE.

*An excavation depth of 12 inches was established by USACE prior to work commencing.

*The excavation of special waste yielded a total of 77.96 cubic yards, which was shipped to WMI-Milam for disposal.

*Equipment utilized during excavation:

*TL-26

*TCM

*X331

*17-KW

*Subcontractors:

*WMI-landfill

*B. Garcia-trucking

*Granthum-trucking

*Emerald Turf Farm

OHM CORPORATION
 PROJECT 19531
 GRANITE CITY, IL

QUANTITY SUMMARY FOR 1305 Iowa

SPECIAL WASTE (TONS)	BACKFILL (LOADS)	TOPSOIL (TONS)	CA-6 (TONS)	CA-7 (TONS)	SAND (TONS)	SOD CU.YDS.	CONCRETE	OTHER
101.36	2	12.15	44.5			60		

**Sampling Analysis
Project #19531**

0 - 3" Front and Back

Street/Number Address	A		A	
	PPM	No.	PPM	No.
1305 Iowa	706		869	


3 - 6" Front and Back

B	B		B	
	PPM	No.	PPM	No.
	426		722	

6 - 12" Front and Back

C	C		C	
	PPM	No.	PPM	No.
	124		894	
	548		725	

Depth	
Excav.	(inch)
	12

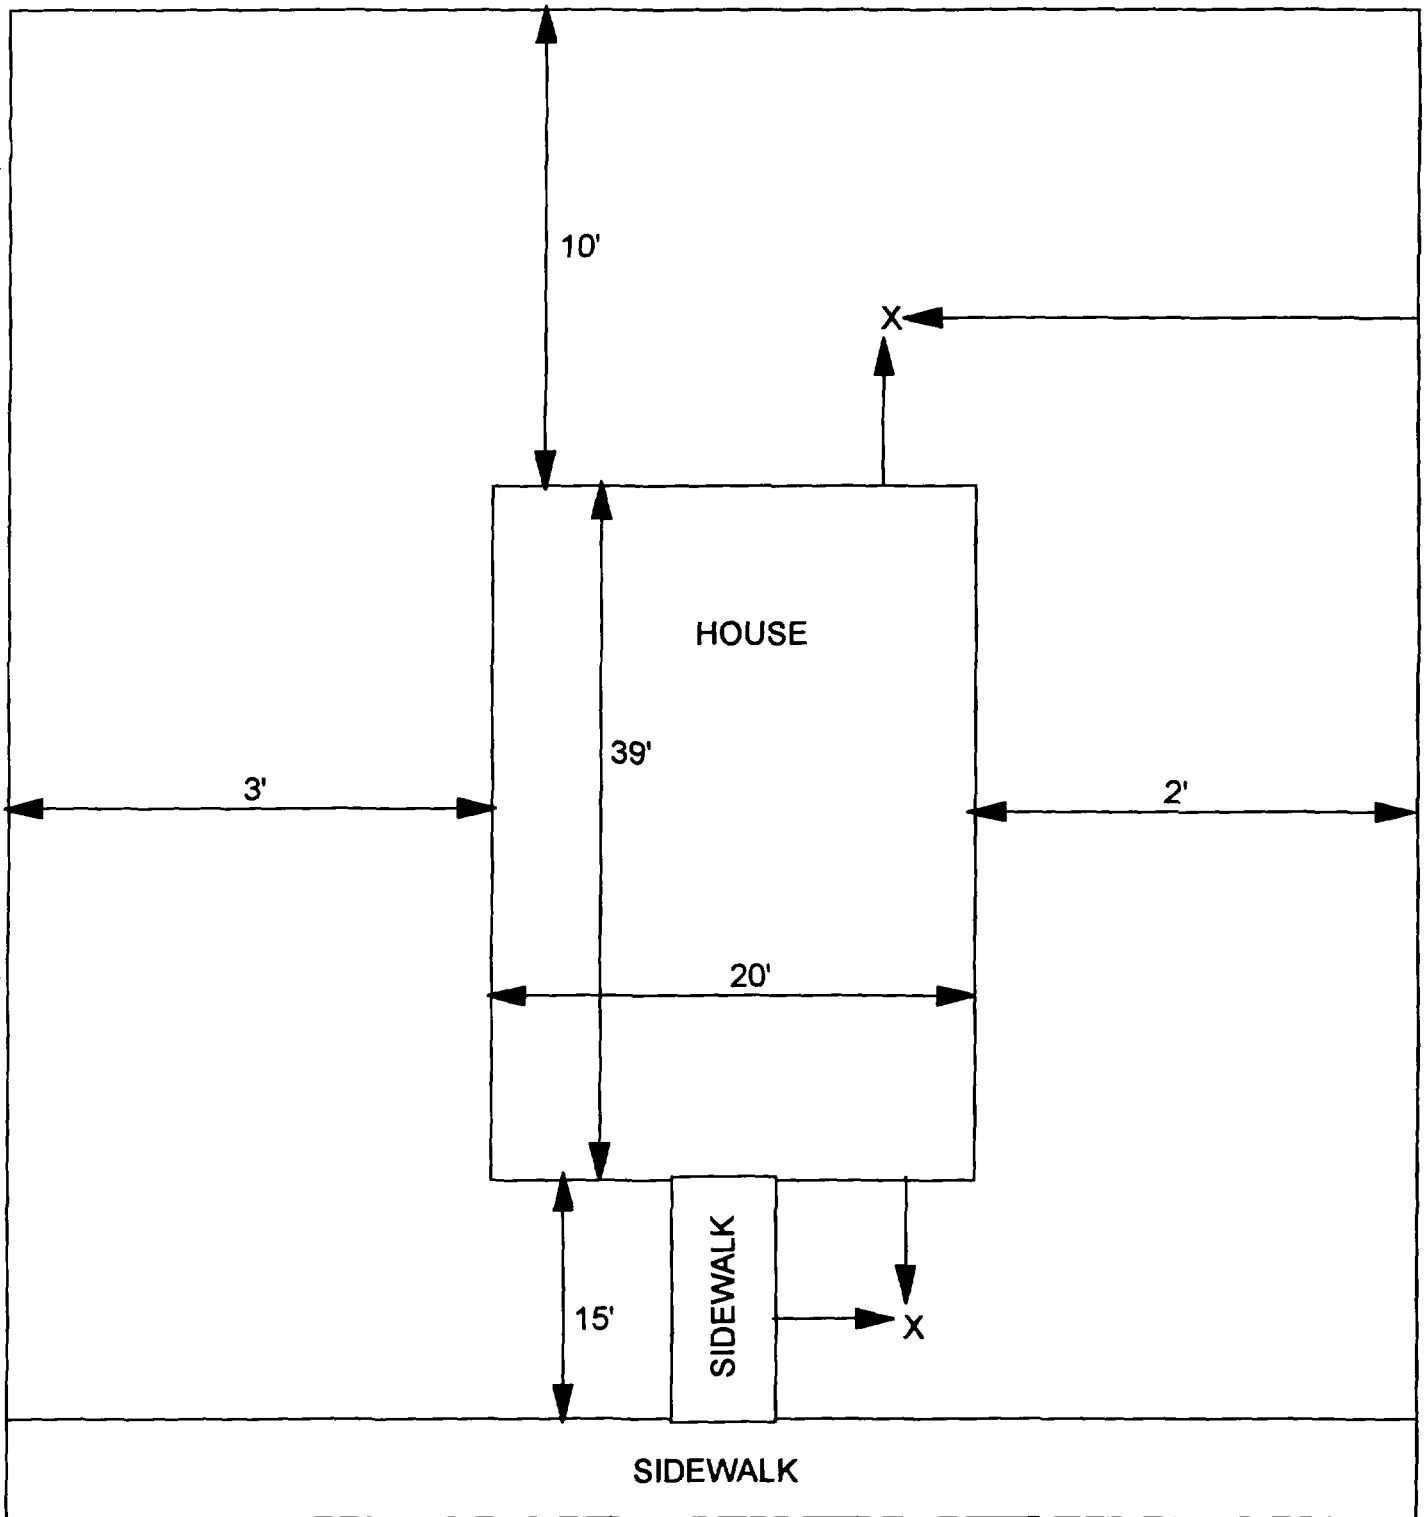

X - SAMPLE POINT

1305 IOWA
25' X 64'

OHM 
Corporation
Findlay, Ohio

Drawn By: **EDJ**

Checked By:

Date: **10/14/98**

Approved By:

Scale: **NTS**

Drawing No:

1

2

3

Action Date: 11/20/97

Loadout: 11/21/97

Restoration Begins: 11/21/97

Restoration Completed: 11/25/97

*Stack emission sites were not sampled for verification due to the fact that a pre-determined depth for excavation was given to OHM by USACE.

*An excavation depth of 6 inches was established by USACE prior to work commencing.

*The excavation of special waste yielded a total of 52.6 cubic yards, which was shipped to WMI-Milam for disposal.

*Equipment utilized during excavation:

*TL-26

*TCM

*X331

*17-KW

*Subcontractors:

*WMI-landfill

*B. Garcia-trucking

*Grantham-trucking

*Emerald-turf farm

**OHM CORPORATION
PROJECT 19531
GRANITE CITY, IL**

QUANTITY SUMMARY FOR

1311 Iowa

SPECIAL WASTE (TONS)	BACKFILL (LOADS)	TOPSOIL (TONS)	CA-6 (TONS)	CA-7 (TONS)	SAND (TONS)	SOD CU.YDS.	CONCRETE	OTHER
68.38	4	29.92				360		

**Sampling Analysis
Project #19531**

0 - 3" Front and Back

Street/Number Address	A		A	
	PPM	No.	PPM	No.

1311 Iowa 516 75
585 284

3 - 6" Front and Back

B	B		B	
	PPM	No.	PPM	No.

520 69
382 420


6 - 12" Front and Back

C	C		C	
	PPM	No.	PPM	No.

468 445

Depth
Excav. (inch)

6

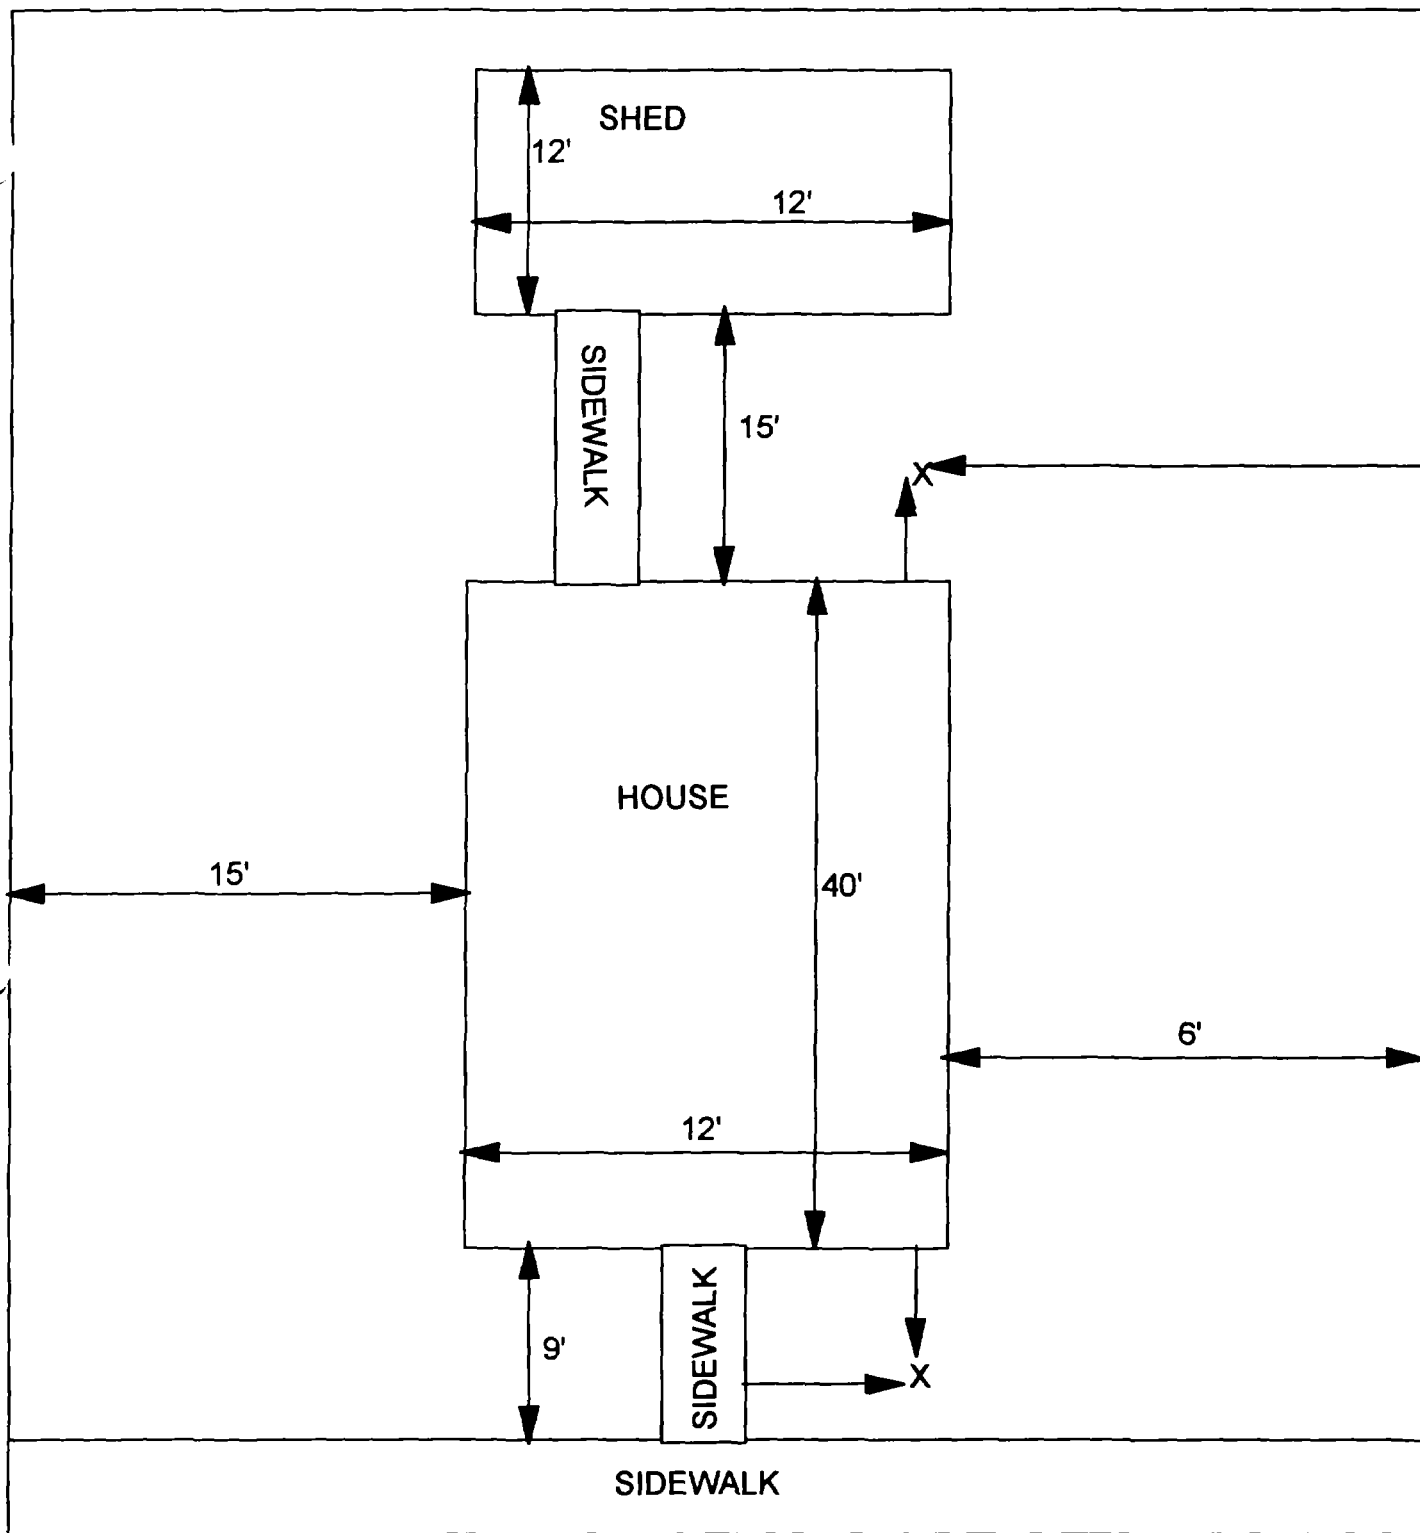

X - SAMPLE POINT

1311 IOWA
42' X 76'

OHM 
Corporation
Findlay, Ohio

Drawn By: **EDJ**

Checked By:

Date:
10/14/98

Approved By:

Scale: **NTS**

Drawing No:

1

2

3

Action Date: 8/20/97

— Loadout: 8/22/97

Restoration Begins: 8/25/97

Restoration Completed: 9/15/97

*Stack emission sites were not sampled for verification due to the fact that a pre-determined depth for excavation was given to OHM by USACE.

*An excavation depth of 6 inches was established by USACE prior to work commencing.

*The excavation of special waste yielded a total of 92.53 cubic yards, which was shipped to WMI-Milam for disposal.

*Equipment utilized during excavation:

*TL-26

*TCM

*X331

*17-KW

*Subcontractors:

*WMI-landfill

*B. Garcia-trucking

*Granthum-trucking

*Schneider Turf Farm

OHM CORPORATION
PROJECT 19531
GRANITE CITY, IL

QUANTITY SUMMARY FOR 1313 Iowa

SPECIAL WASTE (TONS)	BACKFILL (LOADS)	TOPSOIL (TONS)	CA-6 (TONS)	CA-7 (TONS)	SAND (TONS)	SOD CU.YDS.	CONCRETE	OTHER
120.29	6	67.9	16.05			600		

**Sampling Analysis
Project #19531**

0 - 3" Front and Back

Street/Number Address	A		A	
	PPM	No.	PPM	No.
1313 Iowa	580		584	


3 - 6" Front and Back

B		B	
PPM	No.	PPM	No.
216		506	
223		458	

6 - 12" Front and Back

C		C	
PPM	No.	PPM	No.
162		342	

Depth
Excav. (inch)
6

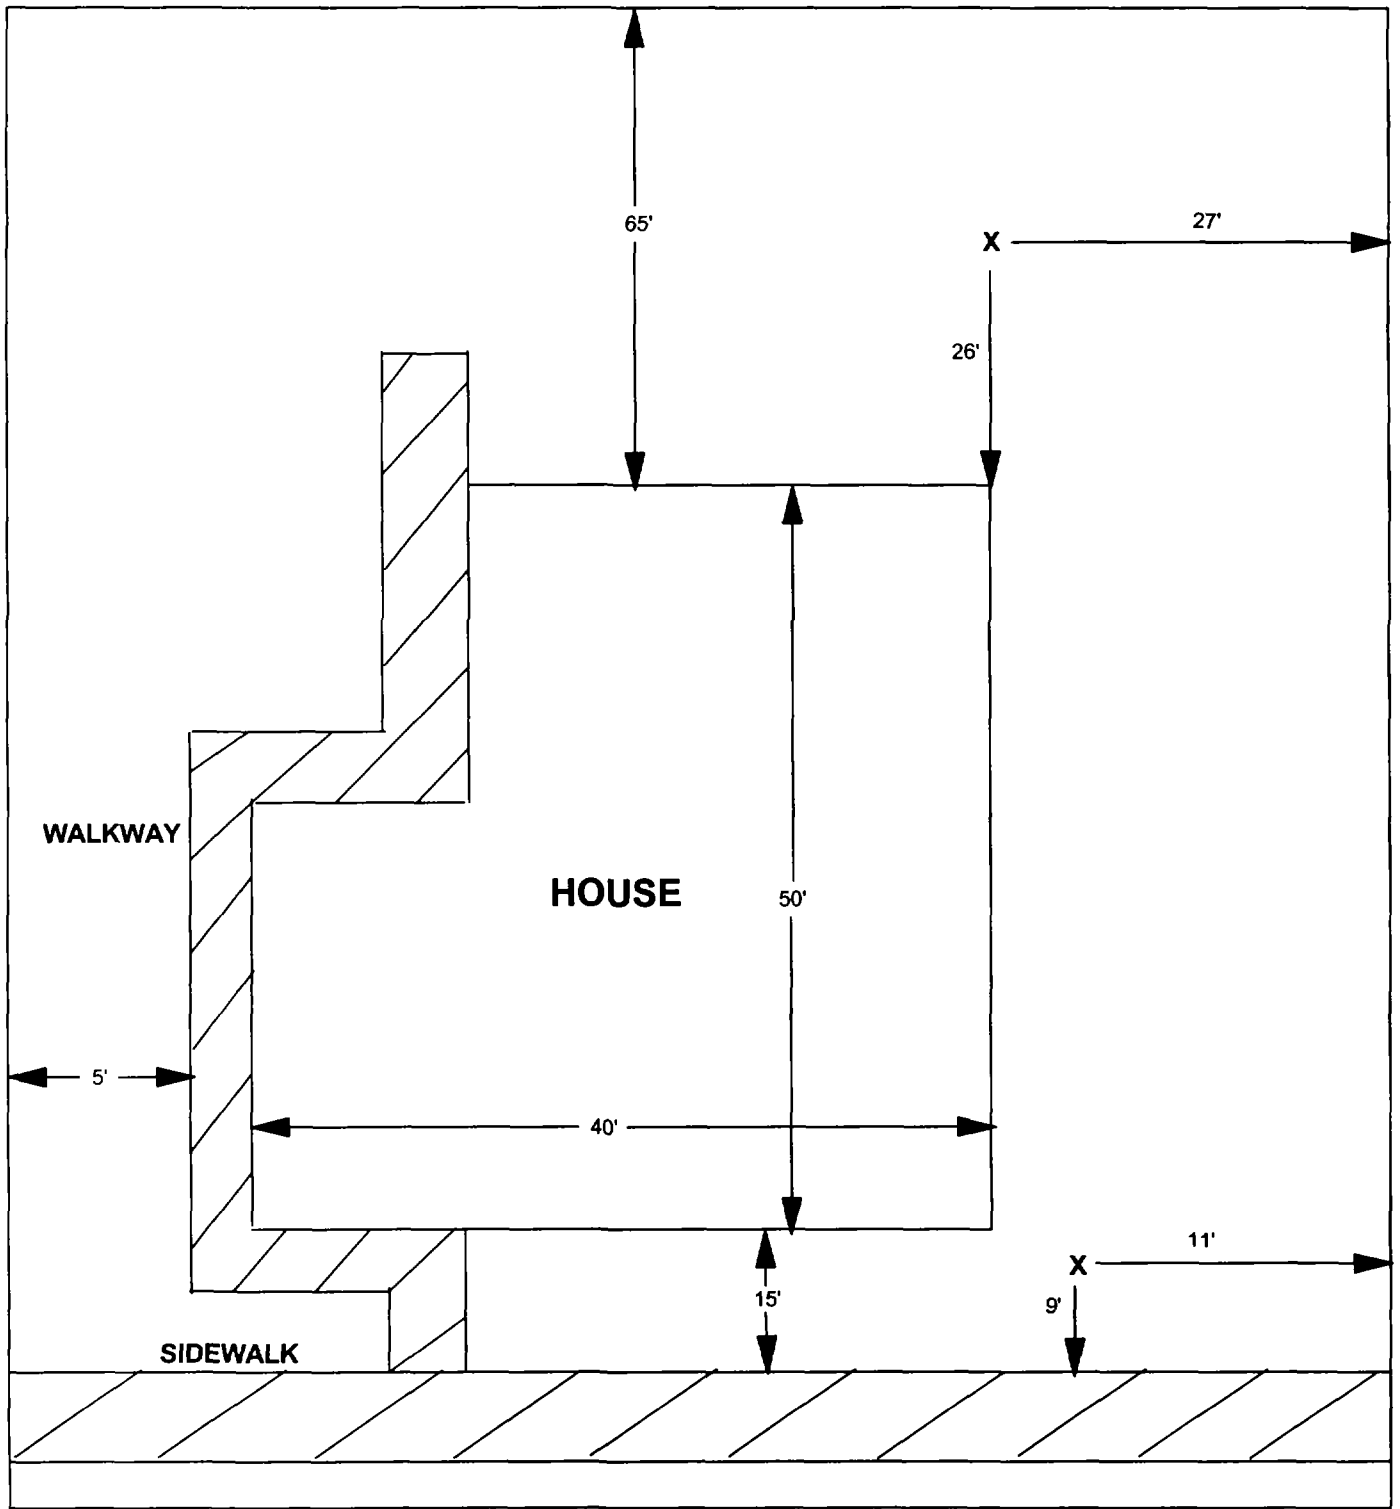

X = SAMPLE POINT

1313 IOWA

**TOTAL
DIMENSIONS
130'X72'**

OHM 
Corporation
Findlay, Ohio

Drawn By: **JG** Checked By:

Date: **8/21/98** Approved By:

Scale: **NTS** Drawing No:

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- Action Date: 6/28/97
- Loadout: 7/9/97
Restoration Begins: 7/10/97
Restoration Completed: 8/22/97

*Stack emission sites were not sampled for verification due to the fact that a pre-determined depth for excavation was given to OHM by USACE.

*An excavation depth of 6 inches was established by USACE prior to work commencing.

*The excavation of special waste yielded a total of 89.71 cubic yards, which was shipped to WMI-Milam for disposal.

*Equipment utilized during excavation:

*TL-26	*TCM
*X331	
*17-KW	

*Subcontractors:

- *WMI-landfill
- *B. Garcia-trucking
- *Granthum-trucking
- *Schneider Turf Farm

OHM CORPORATION
PROJECT 19531
GRANITE CITY, IL

QUANTITY SUMMARY FOR

1316 Iowa

SPECIAL WASTE (TONS)	BACKFILL (LOADS)	TOPSOIL (TONS)	CA-6 (TONS)	CA-7 (TONS)	SAND (TONS)	SOD CU.YDS.	CONCRETE	OTHER
116.63	4	51.43		15.6		360		

Sampling Analysis
Project #19531

0 - 3" Front and Back

	A	A	A
Street/Number	PPM	PPM	PPM
Address	No.	No.	No.

1316 Iowa

593 566

3 - 6" Front and Back

B	B	B
PPM	PPM	PPM
No.	No.	No.

558 352
262 469


6 - 12" Front and Back

C	C	C
PPM	PPM	PPM
No.	No.	No.

446 180

Depth
Excav.
(inch)

6

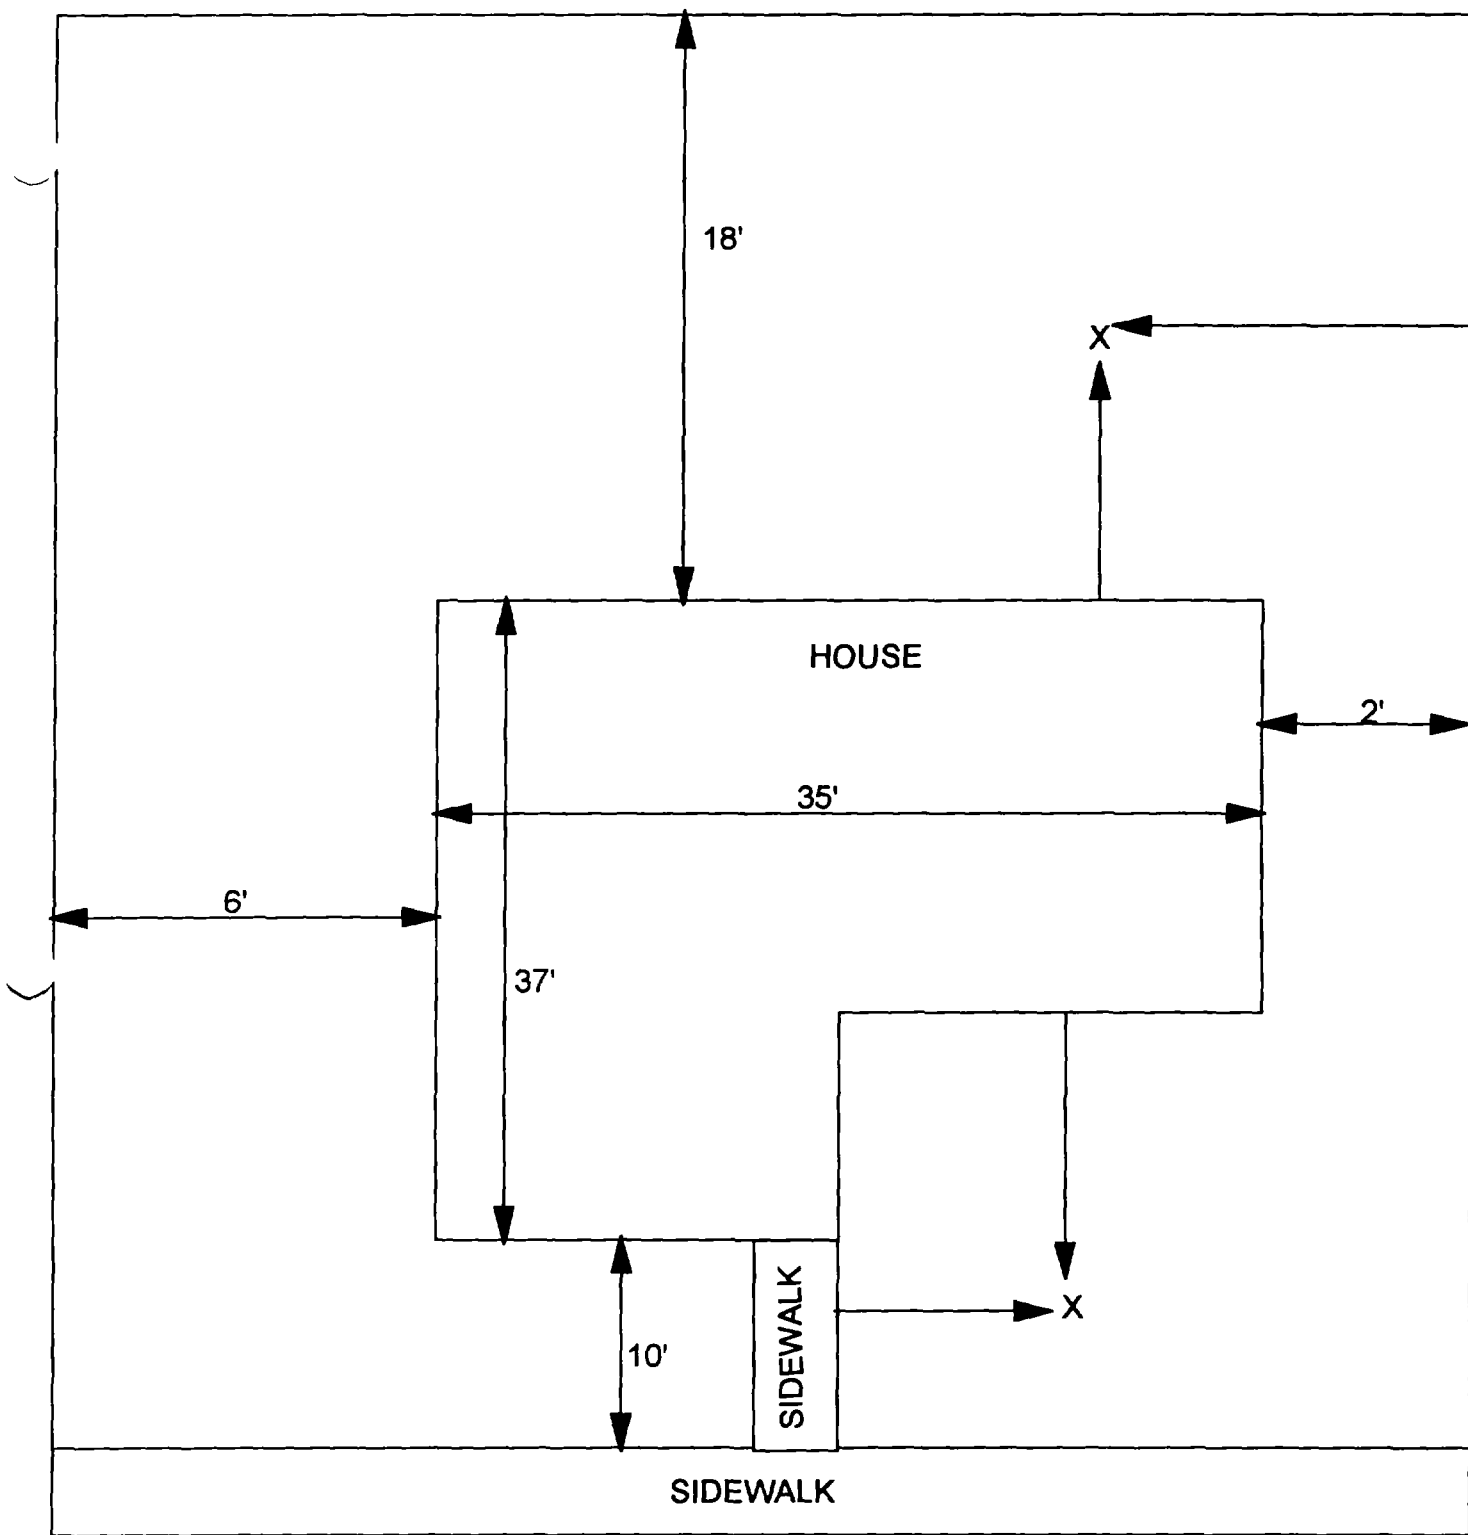

X - SAMPLE POINT

1316 IOWA
43' X 65'

OHM 
Corporation
Findlay, Ohio

Drawn By: EDJ	Checked By:
Date: 10/14/98	Approved By:
Scale: NTS	Drawing No:

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Action Date: 6/28/97

— Loadout: 7/10/97

Restoration Begins: 7/10/97

Restoration Completed: 8/22/97

*Stack emission sites were not sampled for verification due to the fact that a pre-determined depth for excavation was given to OHM by USACE.

*An excavation depth of 3 inches was established by USACE prior to work commencing.

*The excavation of special waste yielded a total of 44.10 cubic yards, which was shipped to WMI-Milam for disposal.

*Equipment utilized during excavation:

*TL-26

*TCM

*X331

*17-KW

*Subcontractors:

*WMI-landfill

*B. Garcia-trucking

*Granthum-trucking

*Schneider Turf Farm

OHM CORPORATION
PROJECT 19531
GRANITE CITY, IL

QUANTITY SUMMARY FOR 1322 Iowa

SPECIAL WASTE (TONS)	BACKFILL (LOADS)	TOPSOIL (TONS)	CA-6 (TONS)	CA-7 (TONS)	SAND (TONS)	SOD CU.YDS.	CONCRETE	OTHER
57.33	3	48.54				480		

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Sampling Analysis
Project #19531

0 - 3" Front and Back

Street/Number Address	A		A	
	PPM	No.	PPM	No.
1322 Iowa	466	734		


3 - 6" Front and Back

B	B		B	
	PPM	No.	PPM	No.
386		358		

6 - 12" Front and Back

C	C		C	
	PPM	No.	PPM	No.
183		50		

Depth	
Excav.	(inch)
	3

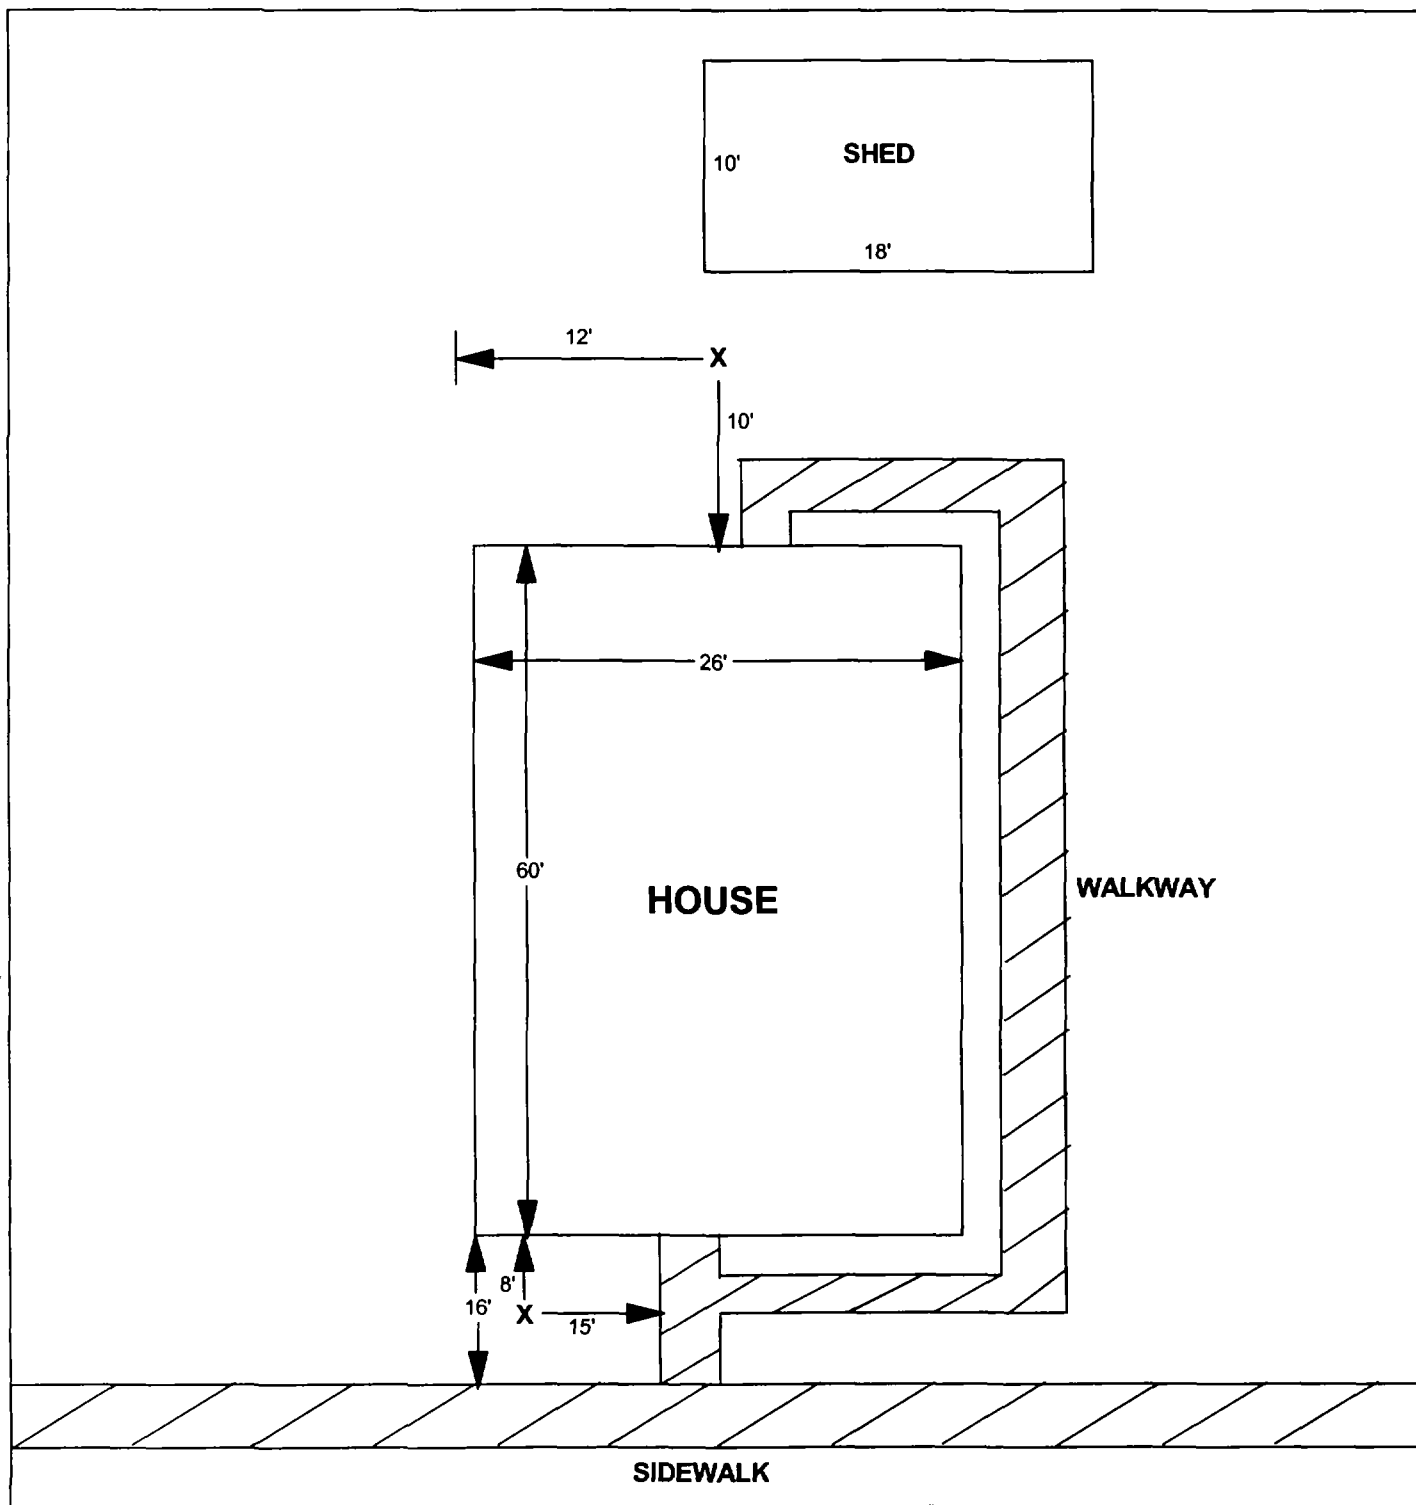

X = SAMPLE POINT

1322 IOWA

**TOTAL
DIMENSIONS
126'X50'**

OHM 
Corporation
Findlay, Ohio

Drawn By: JG	Checked By:
Date: 8/20/98	Approved By:
Scale: NTS	Drawing No:

2

3

4

Action Date: 6/28/97

— Loadout: 7/9/97

Restoration Begins: 7/9/97

Restoration Completed: 8/22/97

*Stack emission sites were not sampled for verification due to the fact that a pre-determined depth for excavation was given to OHM by USACE.

*An excavation depth of 6 inches was established by USACE prior to work commencing.

*The excavation of special waste yielded a total of 70.71 cubic yards, which was shipped to WMI-Milam for disposal.

*Equipment utilized during excavation:

*TL-26

*TCM

*X331

*17-KW

*Subcontractors:

*WMI-landfill

*B. Garcia-trucking

*Granthum-trucking

*Schneider Turf Farm

OHM CORPORATION
PROJECT 19531
GRANITE CITY, IL

QUANTITY SUMMARY FOR 1324 Iowa

SPECIAL WASTE (TONS)	BACKFILL (LOADS)	TOPSOIL (TONS)	CA-6 (TONS)	CA-7 (TONS)	SAND (TONS)	SOD CU.YDS.	CONCRETE	OTHER
91.93	2	64.29		14.25		360		

Sampling Analysis
Project #19531

0 - 3" Front and Back

Street/Number Address	A		A	
	PPM	No.	PPM	No.
1324 Iowa	343	674	593	


3 - 6" Front and Back

B		B	
PPM	No.	PPM	No.
390	518	479	

6 - 12" Front and Back

C		C	
PPM	No.	PPM	No.
91	272	266	

Depth Excav. (inch)
6

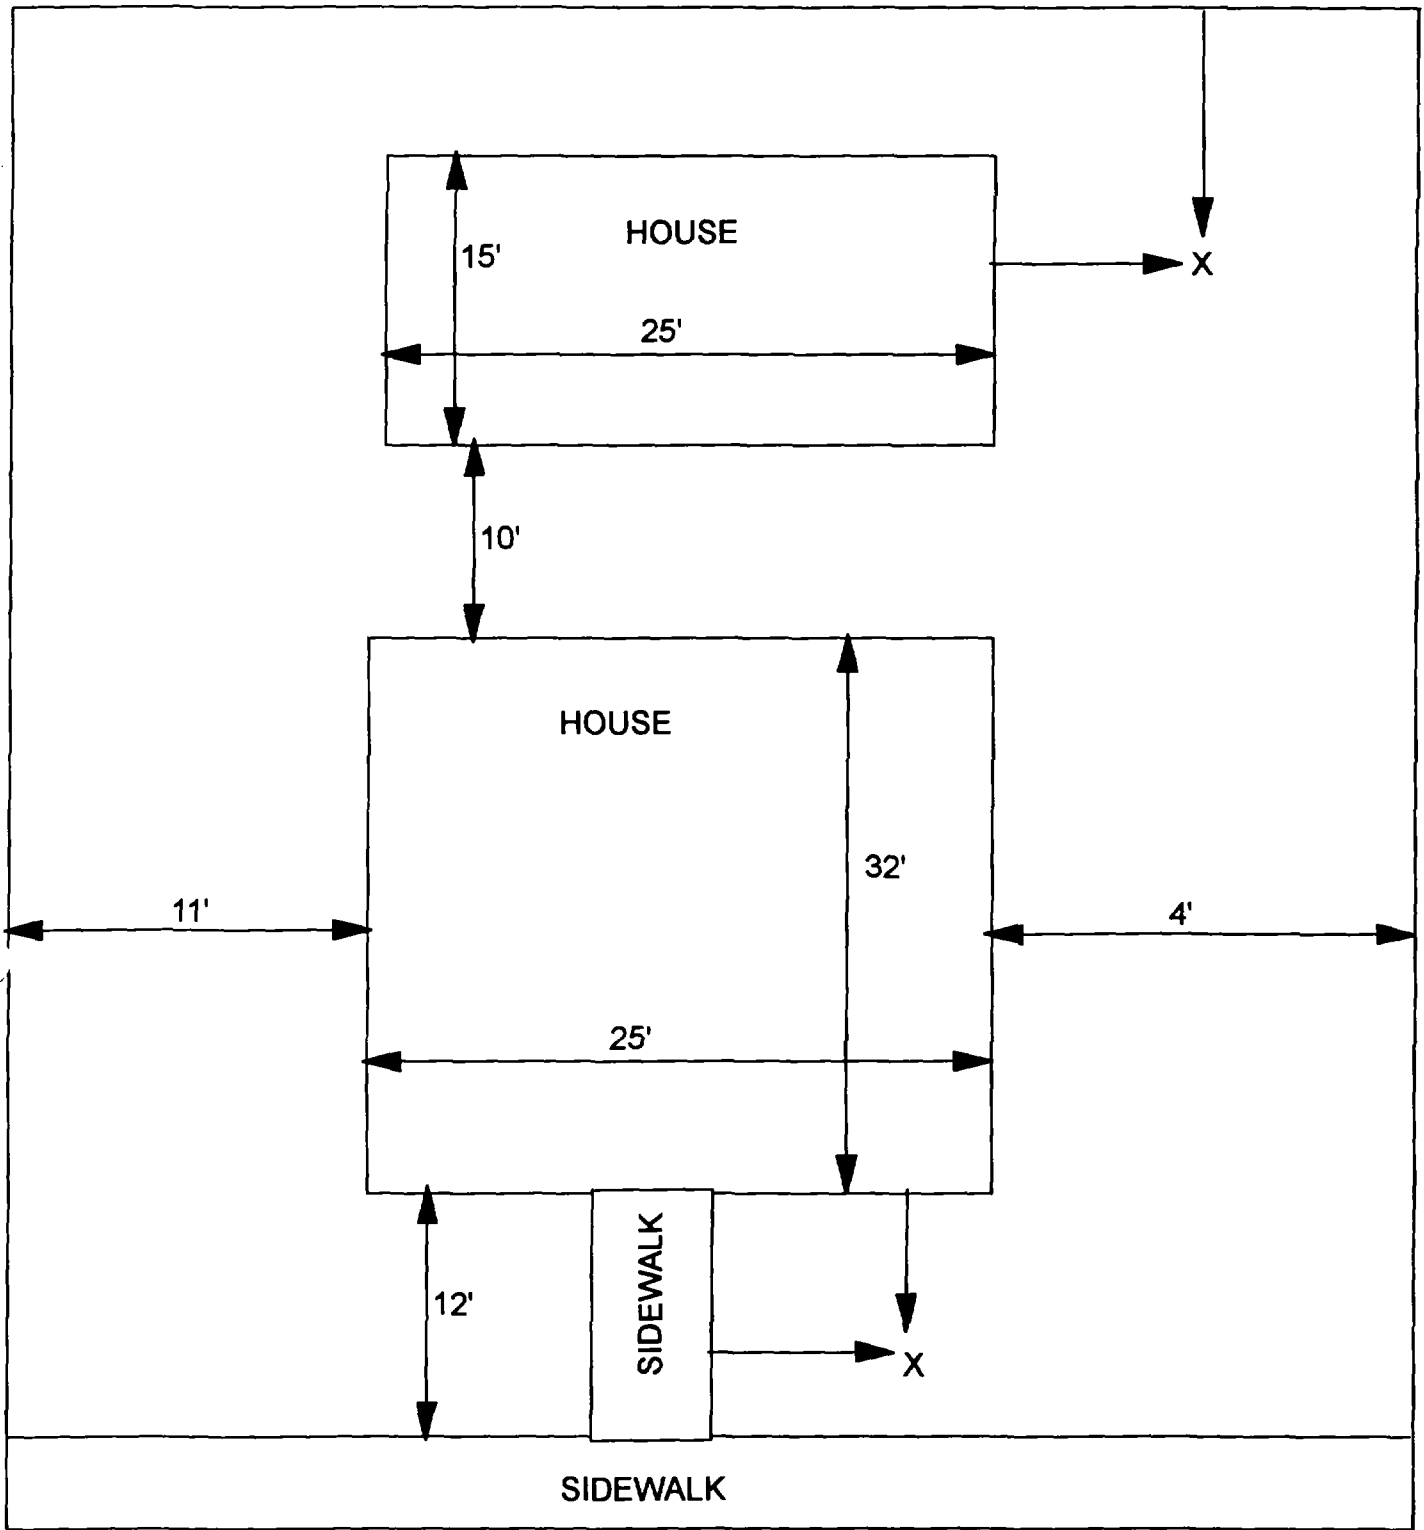

X - SAMPLE POINT

1324 IOWA
40' X 69'

OHM 
Corporation
Findlay, Ohio

Drawn By: **EDJ**

Checked By:

Date: **10/14/98**

Approved By:

Scale: **NTS**

Drawing No:

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2

3

4

Action Date: 9/12/97

Loadout: 9/13/97

Restoration Begins: 9/15/97

Restoration Completed: 10/1/97

*Stack emission sites were not sampled for verification due to the fact that a pre-determined depth for excavation was given to OHM by USACE.

*An excavation depth of 6 inches was established by USACE prior to work commencing.

*The excavation of special waste yielded a total of 83.66 cubic yards, which was shipped to WMI-Milam for disposal.

*Equipment utilized during excavation:

*TL-26

*TCM

*X331

*17-KW

*Subcontractors:

*WMI-landfill

*B. Garcia-trucking

*Grantham-trucking

*Emerald-turf farm

**OHM CORPORATION
PROJECT 19531
GRANITE CITY, IL**

QUANTITY SUMMARY FOR

1400 Iowa

SPECIAL WASTE (TONS)	BACKFILL (LOADS)	TOPSOIL (TONS)	CA-6 (TONS)	CA-7 (TONS)	SAND (TONS)	SOD CU.YDS.	CONCRETE	OTHER
108.77	6	28.41	14.65	13.25		540		

Sampling Analysis
Project #19531

0 - 3" Front and Back

	A	A	A
Street/Number	PPM	PPM	PPM
Address	No.	No.	No.

1400 Iowa

559

729

3 - 6" Front and Back

B	B	B
PPM	PPM	PPM
No.	No.	No.

433

753

6 - 12" Front and Back


C	C	C
PPM	PPM	PPM
No.	No.	No.

126

391

Depth
Excav.
(inch)

6

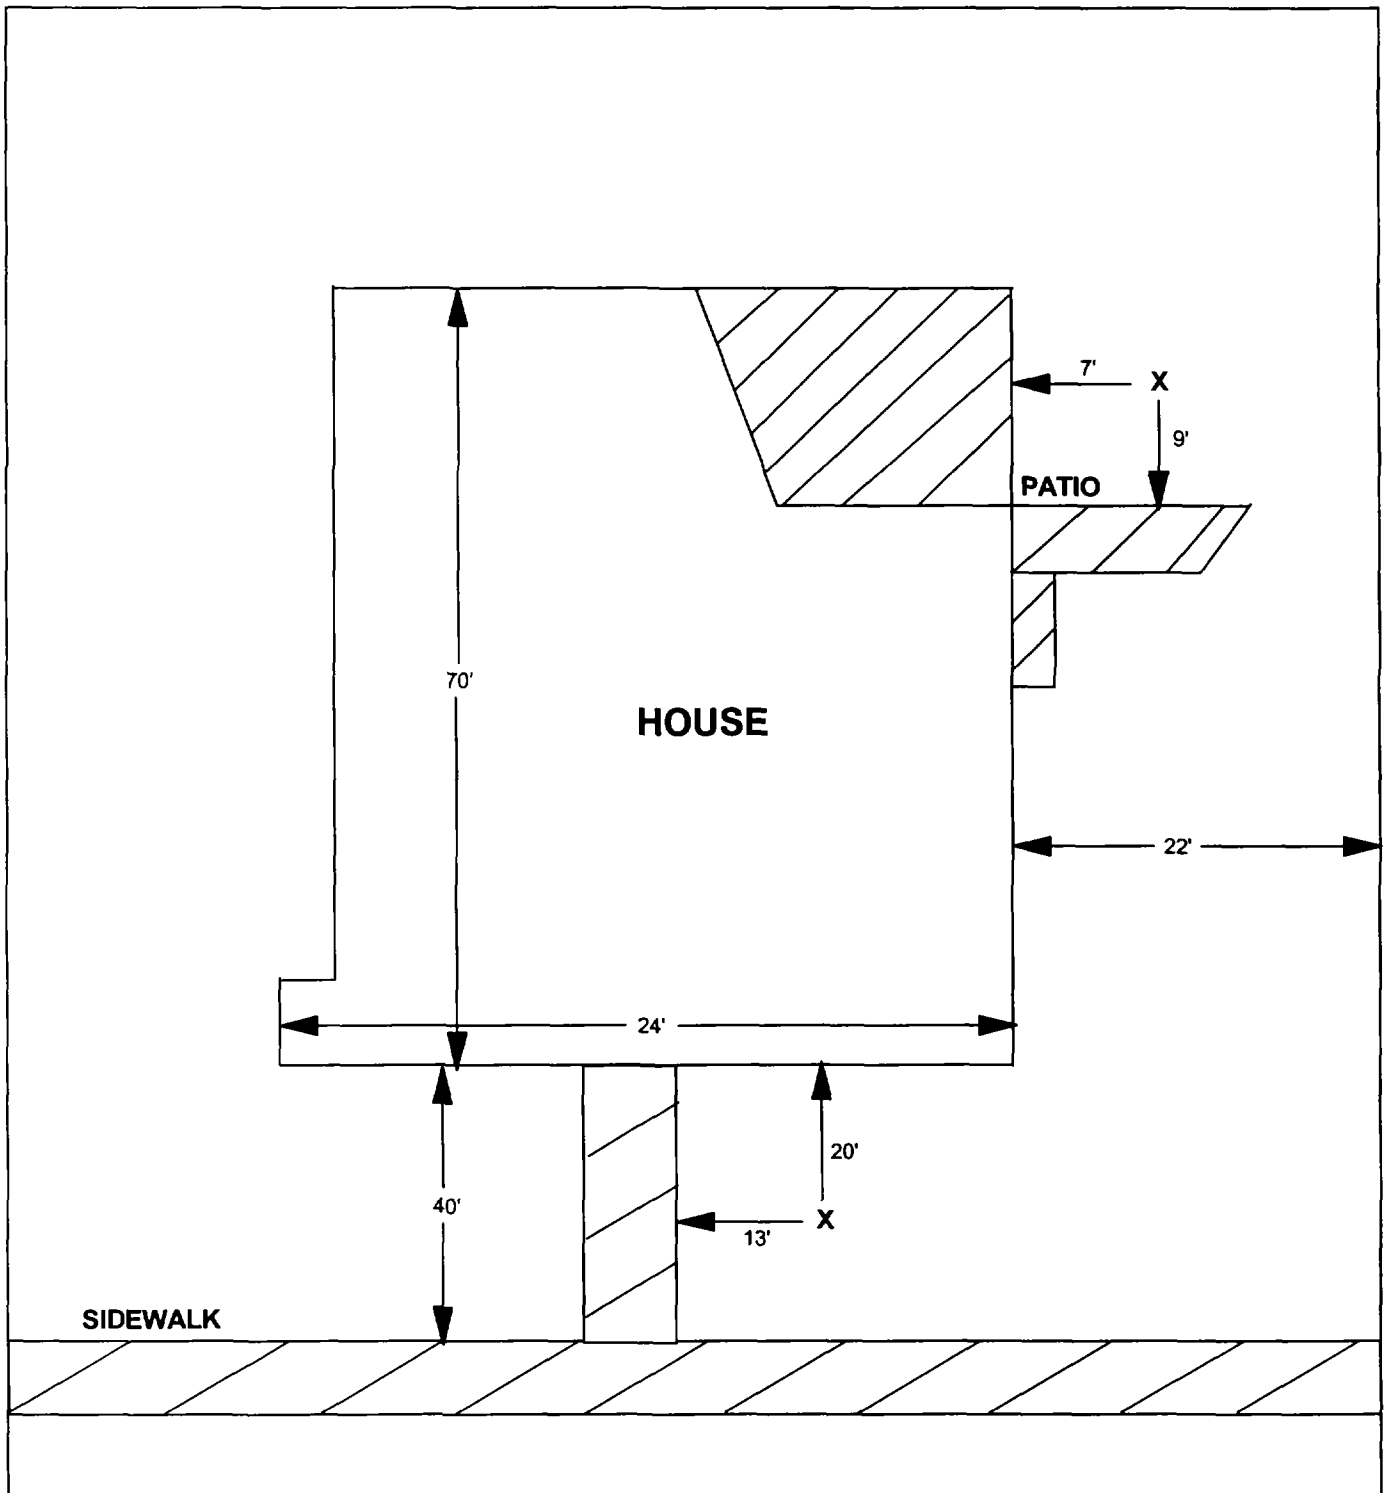

X = SAMPLE POINT

1400 IOWA

**TOTAL
DIMENSIONS
110'X46'**

OHM 
Corporation
Findlay, Ohio

Drawn By: JG	Checked By:
Date: 8/21/98	Approved By:
Scale: NTS	Drawing No:

Action Date: 5/15/97

Loadout: 5/19/97

Restoration Begins: 5/19/97

Restoration Completed: 5/22/97

*Stack emission sites were not sampled for verification due to the fact that a pre-determined depth for excavation was given to OHM by USACE.

*An excavation depth of 12 inches was established by USACE prior to work commencing.

*The excavation of special waste yielded a total of 163.90 cubic yards, which was shipped to WMI-Milam for disposal.

*Equipment utilized during excavation:

*TL-26

*TCM

*X331

*17-KW

*Subcontractors:

*WMI-landfill

*B. Garcia-trucking

*Granthum-trucking

*Schneider Turf Farm

OHM CORPORATION
PROJECT 19531
GRANITE CITY, IL

QUANTITY SUMMARY FOR 1406 Iowa

SPECIAL WASTE (TONS)	BACKFILL (LOADS)	TOPSOIL (TONS)	CA-6 (TONS)	CA-7 (TONS)	SAND (TONS)	SOD CU.YDS.	CONCRETE	OTHER
213.07	6	32.9	57.2	41.3		157.5		

Sampling Analysis
Project #19531

0 - 3" Front and Back

Street/Number	A	A	A
Address	PPM	PPM	PPM
	No.	No.	No.

1406 Iowa

6468 608

3 - 6" Front and Back

B	B	B
PPM	PPM	PPM
No.	No.	No.

1512 389

437 617

6 - 12" Front and Back


C	C	C
PPM	PPM	PPM
No.	No.	No.

1678 347

297 663

Depth
Excav.
(inch)

12

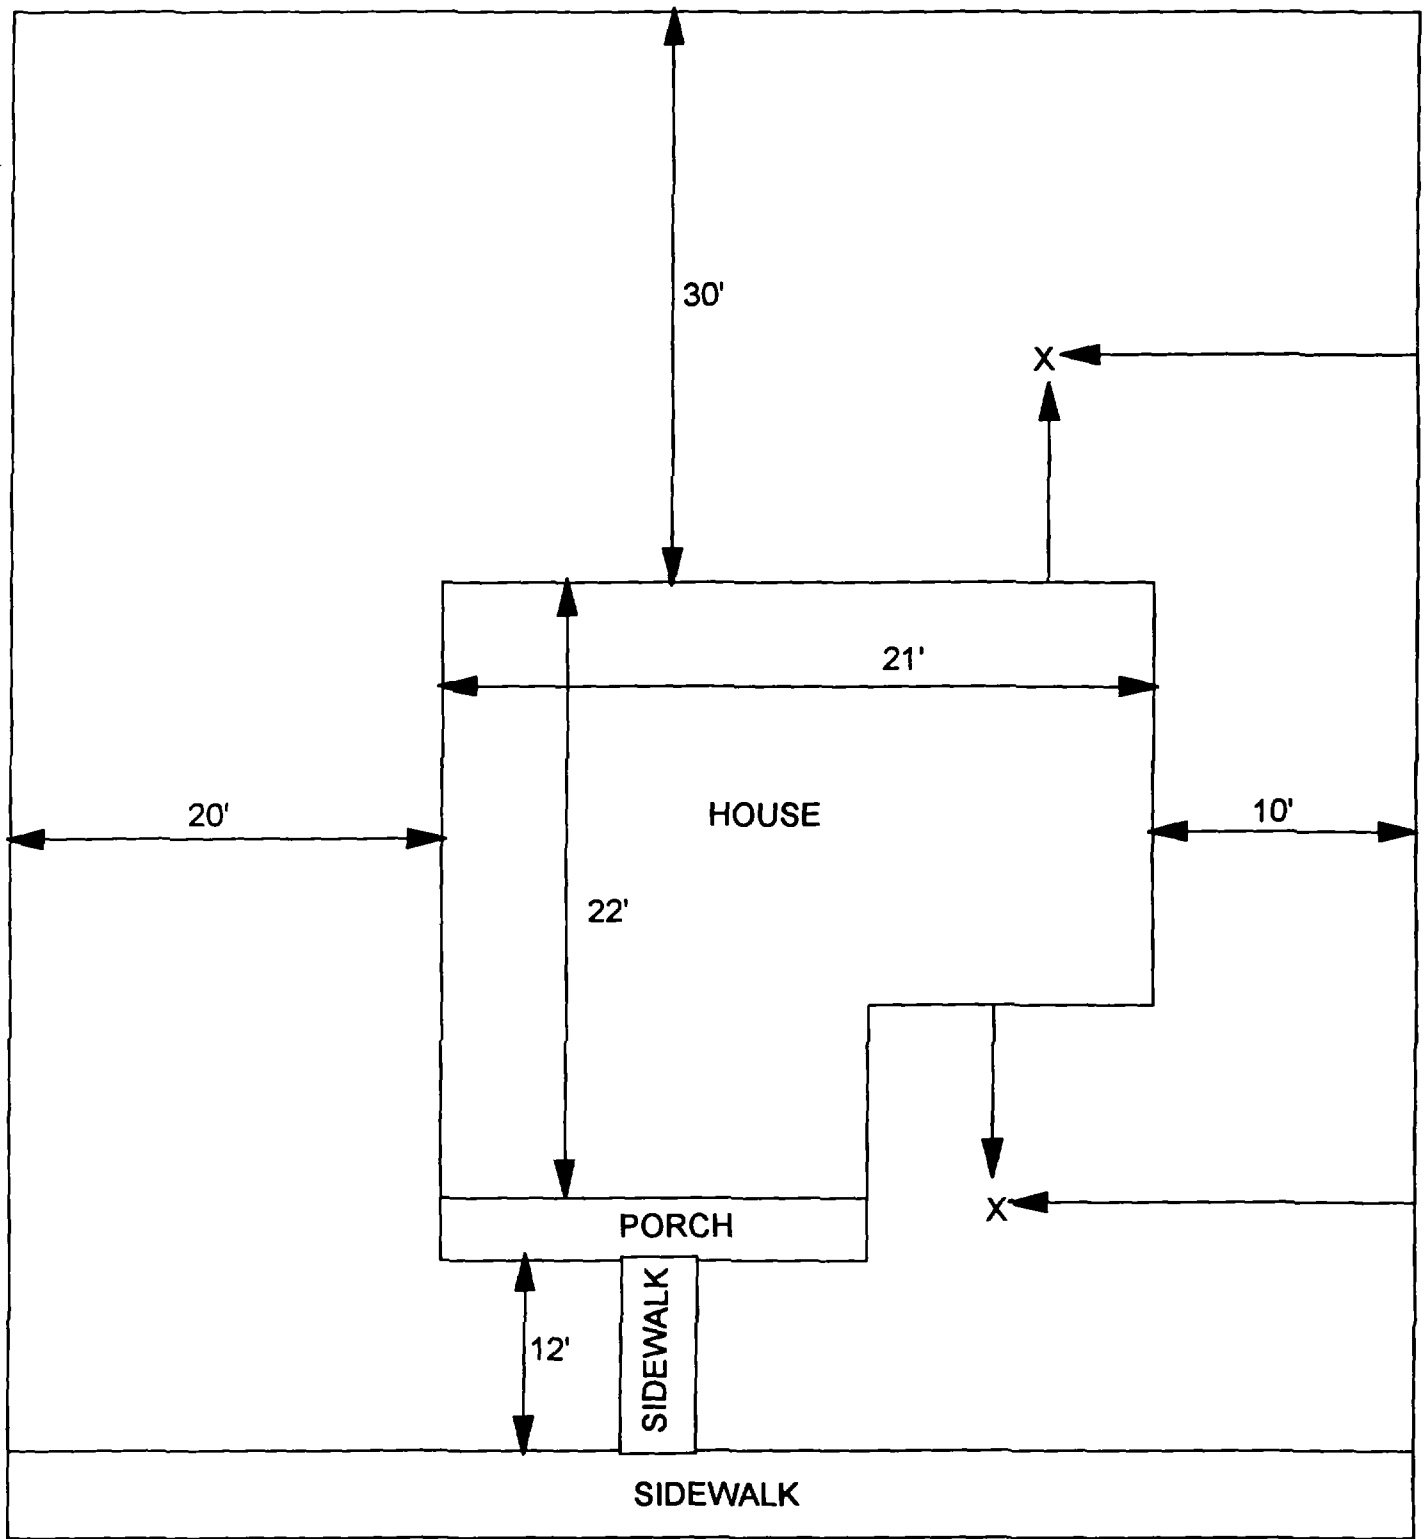

X - SAMPLE POINT

1406 IOWA
51' X 64'

OHM 
Corporation
Findley, Ohio

Drawn By: **EDJ**

Checked By:

Date: **10/14/98**

Approved By:

Scale: **NTS**

Drawing No:

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- Action Date: 4/9/97
Loadout: 4/16/97
Restoration Begins: 4/16/97
Restoration Completed: 5/6/97

*Stack emission sites were not sampled for verification due to the fact that a pre-determined depth for excavation was given to OHM by USACE.

*An excavation depth of 12 inches was established by USACE prior to work commencing.

*The excavation of special waste yielded a total of 251.44 cubic yards, which was shipped to WMI-Milam for disposal.

*Equipment utilized during excavation:

*TL-26	*TCM
*X331	
*17-KW	

*Subcontractors:

*WMI-landfill
*B. Garcia-trucking
*Granthum-trucking
*Schneider Turf Farm

EASEMENT INFORMATION

This easement was completed after the Temporary Restraining Order (TRO) was lifted.

OHM CORPORATION
PROJECT 19531
GRANITE CITY, IL

QUANTITY SUMMARY FOR 1408 Iowa

SPECIAL WASTE (TONS)	BACKFILL (LOADS)	TOPSOIL (TONS)	CA-6 (TONS)	CA-7 (TONS)	SAND (TONS)	SOD CU.YDS.	CONCRETE	OTHER
326.88	14	136.92	87.3	43.5		504		

Sampling Analysis
Project #19531

0 - 3" Front and Back

Street/Number	A	A	A
Address	PPM	PPM	PPM
	No.	No.	No.

3 - 6" Front and Back

B	B	B
PPM	PPM	PPM
No.	No.	No.

6 - 12" Front and Back

C	C	C
PPM	PPM	PPM
No.	No.	No.

Depth
Excav.
(inch)


1408 Iowa

1300 643 472

598 702 779

670 611 420

12

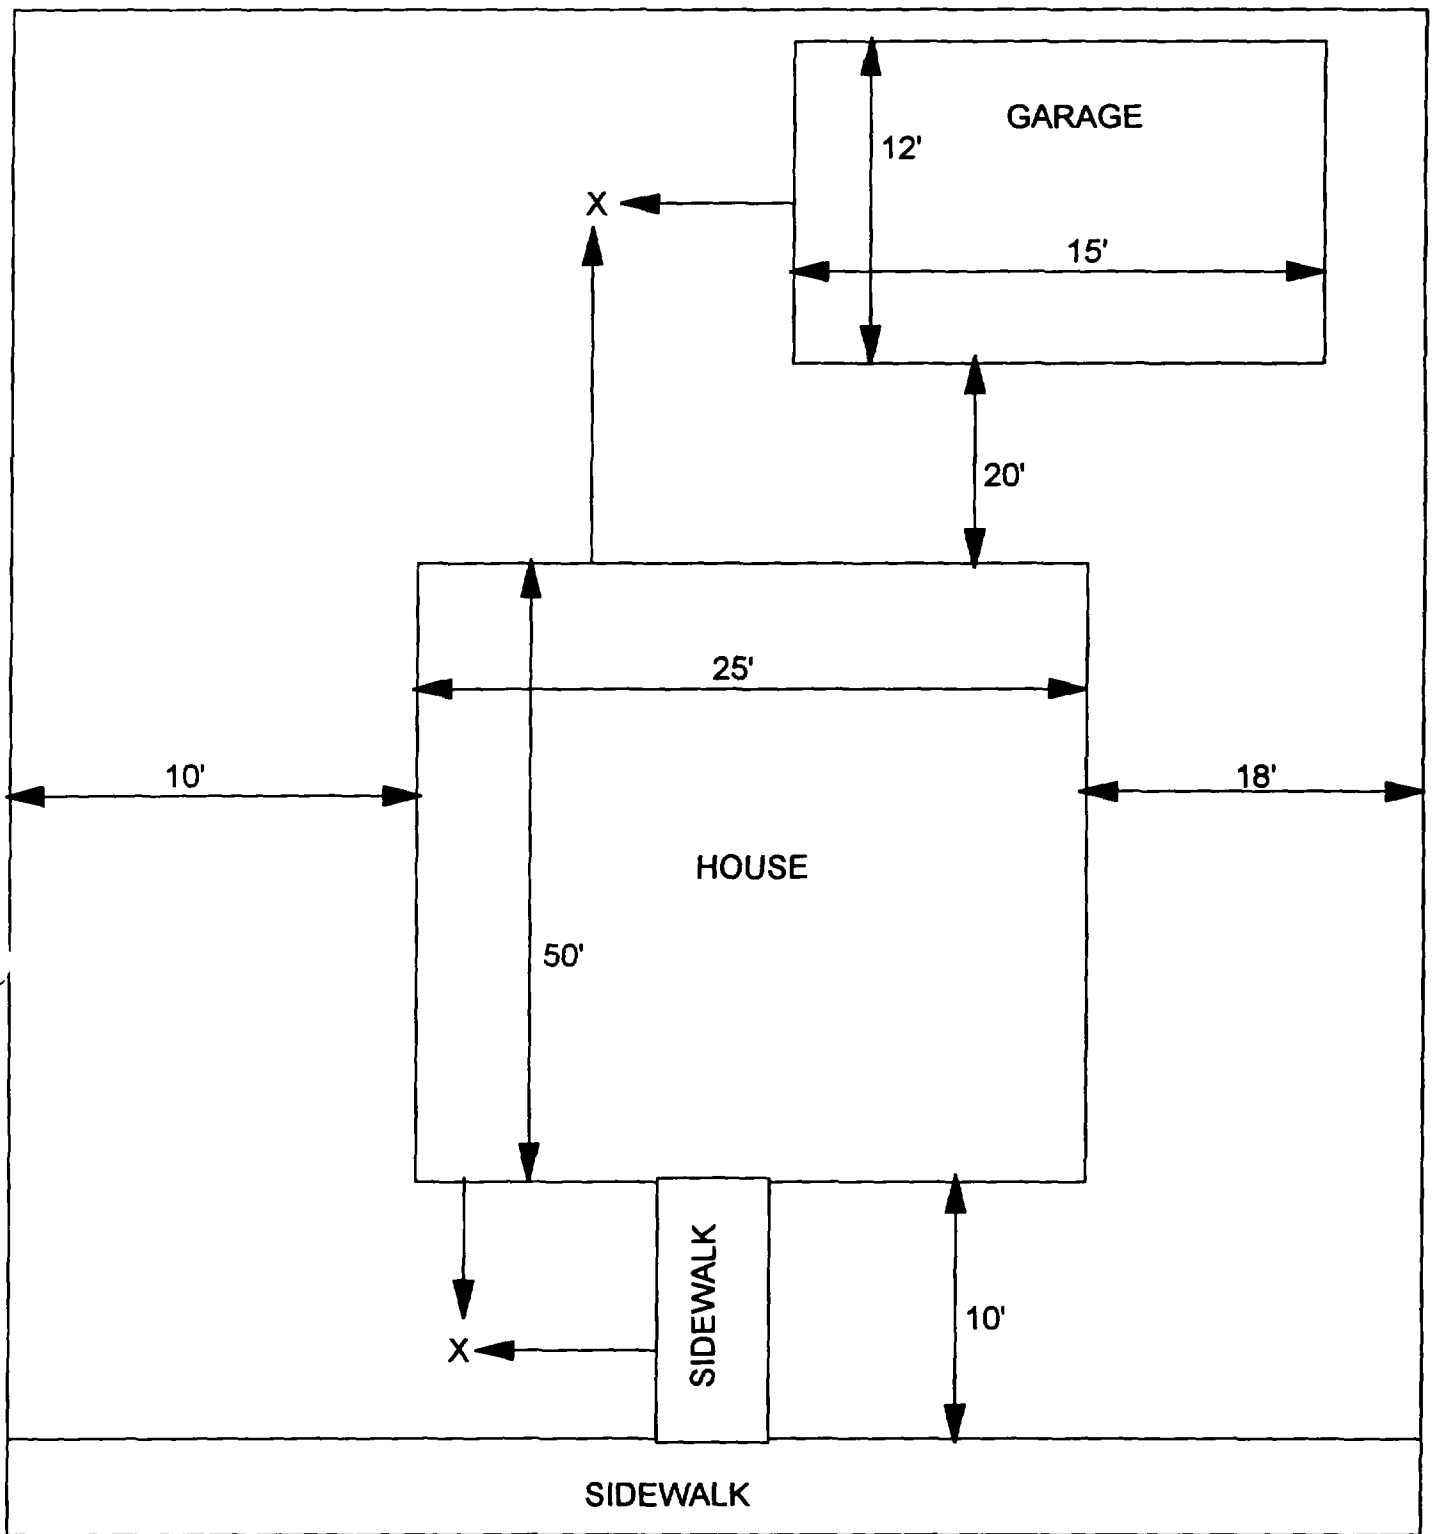

X - SAMPLE POINT

1408 IOWA
53' X 92'

OHM 
Corporation
Findley, Ohio

Drawn By: EDJ	Checked By:
Date: 10/14/98	Approved By:
Scale: NTS	Drawing No:

1

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Action Date: 5/1/97

Loadout: 5/7/97

Restoration Begins: 5/7/97

Restoration Completed: 5/19/97

*Stack emission sites were not sampled for verification due to the fact that a pre-determined depth for excavation was given to OHM by USACE.

*An excavation depth of 12 inches was established by USACE prior to work commencing.

*The excavation of special waste yielded a total of 62.10 cubic yards, which was shipped to WMI-Milam for disposal.

*Equipment utilized during excavation:

*TL-26

*TCM

*X331

*17-KW

*Subcontractors:

*WMI-landfill

*B. Garcia-trucking

*Granthum-trucking

*Schneider Turf Farm

EASEMENT INFORMATION

This easement was completed after the Temporary Restraining Order (TRO) was lifted.

OHM CORPORATION
PROJECT 19531
GRANITE CITY, IL

QUANTITY SUMMARY FOR 1419 Iowa

SPECIAL WASTE (TONS)	BACKFILL (LOADS)	TOPSOIL (TONS)	CA-6 (TONS)	CA-7 (TONS)	SAND (TONS)	SOD CU.YDS.	CONCRETE	OTHER
80.73	1	46.52	29	14.15		190.5		

**Sampling Analysis
Project #19531**

0 - 3" Front and Back

	A		A	
Street/Number	PPM	No.	PPM	No.
Address	No.	No.	No.	No.

1419 Iowa

486

674

3 - 6" Front and Back

	B		B	
PPM	PPM	No.	PPM	No.
No.	No.	No.	No.	No.

535

636

6 - 12" Front and Back

	C		C	
PPM	PPM	No.	PPM	No.
No.	No.	No.	No.	No.


388

595

513 337

Depth
Excav.
(inch)

12

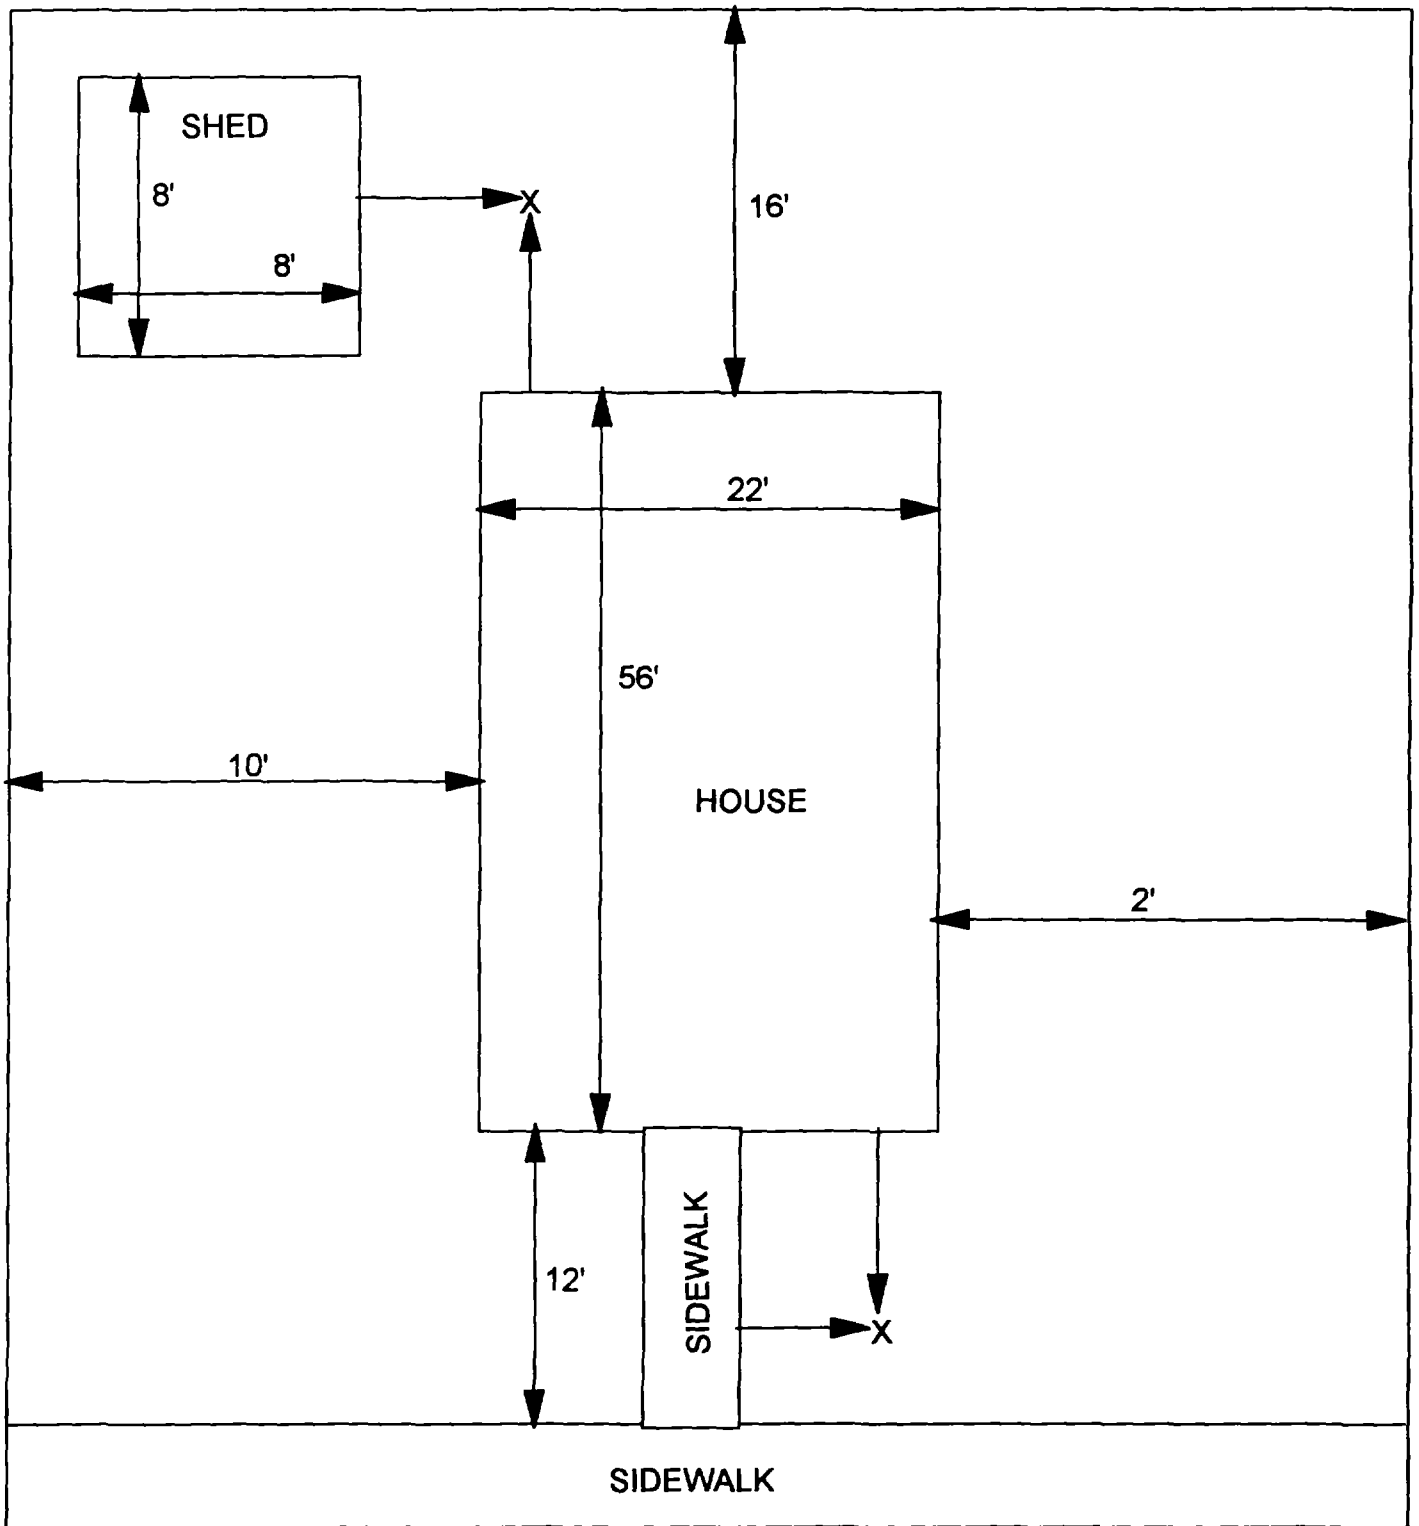

X - SAMPLE POINT

1419 IOWA
34' X 84'

OHM 
Corporation
Findley, Ohio

Drawn By: EDJ	Checked By:
Date: 10/14/98	Approved By:
Scale: NTS	Drawing No:

